CONTRA COSTA COUNTY DEPARTMENT OF CONSERVATION AND DEVELOPMENT

COMMUNITY DEVELOPMENT DIVISION

30 Muir Road

Martinez, CA 94553-4601 Phone: 925-655-2700 Fax: 925-655-2758



AGENCY COMMENT REQUEST

Date 11/18/2025 We request your comments regarding the attached application currently under review. DISTRIBUTION Please submit your comments to: **INTERNAL** Diana Lecca Project Planner ✓ Building Inspection **Grading Inspection** 925-655-2869 Phone # Advance Planning **Housing Programs** diana.lecca@dcd.cccounty.us E-mail Trans. Planning Telecom Planner CDDP25-03032 County File # **ALUC Staff HCP/NCCP Staff** 12/18/2025 County Geologist Prior to HEALTH SERVICES DEPARTMENT We have found the following special programs apply ✓ Environmental Health Hazardous Materials to this application: PUBLIC WORKS DEPARTMENT Active Fault Zone (A-P) Landslide **Engineering Services Special Districts** Flood Hazard Area Liquefaction Traffic 60-dBA Noise Control Flood Control (Full-size) CA EPA Hazardous Waste Site **LOCAL** High or Very High FHSZ ✓ Fire District Kensington Fire Protection San Ramon Valley – (email) rwendel@srvfire.ca.gov AGENCIES: Please indicate the applicable code Consolidated - (email) fire@cccfpd.org section for any recommendation required by law or ordinance. Please send copies of your response to the Sanitary District Stege Sanitary District Applicant and Owner. ✓ Water District EBMUD Comments: None Below Attached City of__ School District(s)_____ **LAFCO** Reclamation District # East Bay Regional Park District Diablo/Discovery Bay/Crockett CSD ✓ MAC/TAC KMAC Improvement/Community Association ✓ CC Mosquito & Vector Control Dist (email) OTHERS/NON-LOCAL CHRIS (email only: nwic@sonoma.edu) Print Name CA Fish and Wildlife, Region 3 – Bay Delta Native American Tribes DATE Signature ADDITIONAL RECIPIENTS Agency phone #



Planning Application Summary

County File Number: CDDP25-03032 File Date: 11/18/2025

Applicant:

Greg VanMechelen VanMechelen Architects

732 Gilman Street

Berkeley, CA 94710

greg@vanmechelenarchitects.com

(510) 558-1075

Property Owner:

KEN & JULIE KURTZMAN

134 BRAEBURN DR NEW CANAAN, CT 06840 510 julikurtzman@gmail.com

(805) 390-8122

Project Description:

The applicant requests approval of a Development Plan and Kensington Design Review for a residential addition yielding a gross floor area of 3,877 SF where 2,500 square feet is the gross floor area threshold for a public hearing. The project also includes a Variance for rear setback of 5-foot 10-inches (where 15 feet is the minimum) for the rear portion of the addition.

Project Location: (Address: 210 AMHERST AVE, KENSINGTON, CA 94708 100), (APN:

570050004)

Additional APNs:

General Plan Designation(s): RM **Zoning District(s):** "R-6, -TOV -K"

Flood Hazard Areas: X AP Fault Zone:

60-dBA Noise Control: MAC/TAC:

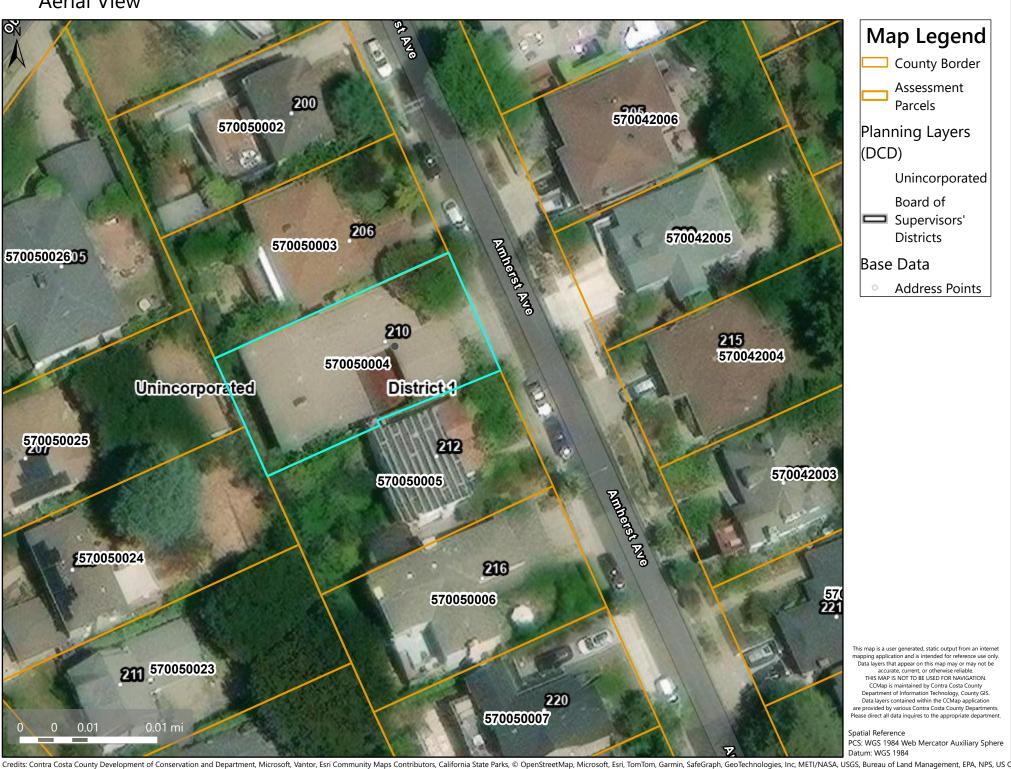
Sphere of Influence: El Cerrito Fire District: KENSINGTON FIRE

Sanitary District: STEGE SANITARY Housing Inventory Site: NO

Specific Plan:

Fees:				
Fee Item	Description	Account Code	Total Fee	Paid
048F	Fish & Wildlife Fee (\$75)	002606-9660-REV-000-5B048F	75.00	75.00
052B	Notification Fee (\$30)	002606-9660-REV-000-5B052B	30.00	30.00
HSDR	Environmental Health Fee (\$57)	002606-9660-REV-000-5BHSDR \$5.00	57.00	57.00
SLS036AH	Undersized Lot Review with Hearing	002606-9660-REV-000-5B036H	3000.00	3000.00
		Total:	3162.00	3162.00

Aerial View



Map Legend **County Border** Assessment Parcels Planning Layers (DCD) Unincorporated Board of Supervisors' Districts Base Data **Address Points**

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PCS: WGS 1984 Web Mercator Auxiliary Sphere

General Plan Land Use Designation Map Legend County Border Assessment Parcels 570042006 570050002 Planning Layers (DCD) General Plan RM (Residential Medium 570042005 Density) (7-17 570050003 57005002605 du/na) Unincorporated Board of Supervisors' 215 570042004 Districts 570050004 Base Data Unincorporated District 1 RM **Address Points** 570050025 570042003 570050005 570050024 570050006 This map is a user generated, static output from an internet mapping application and is intended for reference use only Data layers that appear on this map may or may not be 570050023 accurate, current, or otherwise reliable. THIS MAP IS NOT TO BE USED FOR NAVIGATION.

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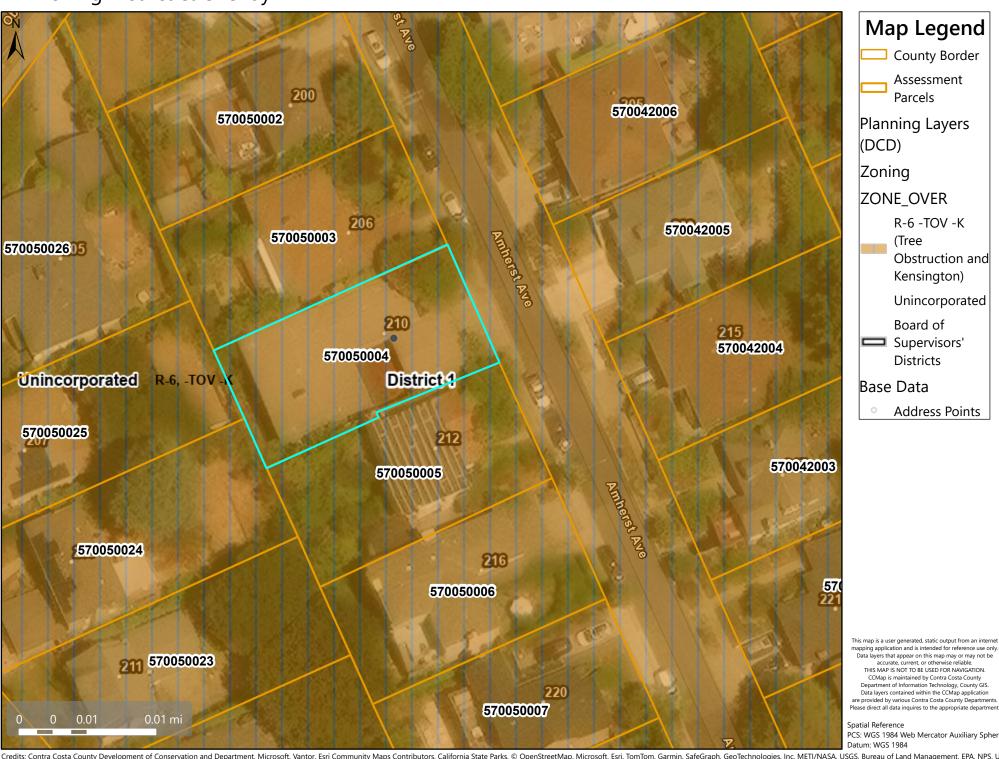
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Please direct all data inquiries to the appropriate department.

PCS: WGS 1984 Web Mercator Auxiliary Sphere

0.01 mi

570050007

Zoning District & Overlay



Map Legend

County Border

Planning Layers

R-6 -TOV -K

Obstruction and Kensington)

Unincorporated

Address Points

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PCS: WGS 1984 Web Mercator Auxiliary Sphere

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GENERAL NOTES

- 1 Scope: These notes apply to all drawings and govern unless noted or specified for more detailed requirements applicable to particular divisions of the work. See specifications and sheet notes contained in the subsections of these drawings.
- 2 Applicable Codes: The intent of the drawings and specifications is to construct the building in the project scope in accordance with the 2022 California Residential Code (CRC), Mechanical Code (CMC), Electrical Code (CEC), Plumbing Code (CPC), and California Title 24 Energy Standards; all including errata and supplements, as amended by Contra Costa County.
- 3 Construction Documents: The General Conditions of the Contract for Construction, (AIA Document A201), latest edition, and the Specifications supplement these drawings and are part of the construction documents. By accepting and using the construction documents, including but not limited to the drawings and specifications, the Contractor agrees to be solely and completely responsible for the accuracy of said construction documents: architectural, structural, civil, mechanical, plumbing, electrical and fire protection.
- 4 Copyright: These drawings and all ideas, arrangements and plans, either indicated or represented by these drawings are owned by, and are the property of VanMechelen Architects, and were created, evolved and developed for use on and in connection with the project designated in the title block. None of these designs, arrangements, or plans shall be used by, or disclosed to, any person, firm, or corporation for any purpose whatsoever, nor shall any changes be made on this drawing without the written permission from VanMechelen Architects. These drawings are not valid for any use unless they bear the original seal and signature of the Architect. Upon completion of the project, all plans shall be returned to the Architect.
- 5 Document Coordination: The Contractor shall be responsible for coordination between architectural, structural, civil, mechanical, plumbing, electrical and fire protection drawings. This includes reviewing existing conditions and requirements of individual systems before ordering and installation of any work. Verify all architectural details and all finish conditions, whether depicted in drawings or not, with same disciplines.
- 6 Non-Industry-Standard Materials and Methods: This project is considered to be an "Environment Friendly Project". It utilizes non-industry-standard materials and methods including but not limited to: FSC Certified Wood, non-toxic paints, sealants and adhesives, thermal mass. The intent is to construct energy efficient buildings which are easy and inexpensive to maintain while using construction materials which reduce environmental impacts and construction methods which reduce construction waste and increase recycling. Some of the products may have limited suppliers or unusual delivery requirements. Some of the details and construction methods are unusual and may require more attention than normal. The Contractor shall review the plans and specifications carefully in this regard and be solely responsible for completing the work as intended. Any substitution requests will be evaluated on environmental considerations as well as on specified criteria.
- 7 Dimensions: On drawings only written dimensions shall be used. Do not scale the drawings. The Contractor shall review and assume responsibility for all dimensions of building and site and notify the architect in writing of any suggested or required discrepancies before proceeding with construction.
- 8 Site Conditions: The Contractor shall visit the site and be fully cognizant of all field conditions, delivery methods and storage facilities, and consult with potential suppliers and subcontractors prior to submitting bid or cost estimate. He or she shall verify all site conditions, delivery methods and storage facilities and assumes all risk associated with field conditions.
- 9. Site Restrictions: The site will be vacated by the owners throughout the construction process. The Contractor, Contractor's personnel, subcontractors and all persons visiting the site shall abide by the following rules:
- a. Intoxicants and drugs: No alcohol, drugs, tobacco, or other intoxicants are allowed on site.
- b. Noise: Noise shall be kept to a minimum including radios or music.
- d. Pets: No pets allowed on site.
- 10 Job Site Conditions: The Contractor agrees to be solely and completely responsible for the job site conditions during the course of construction for the project; including the safety of all persons and property and that this requirement shall apply continuously and not be limited to normal working
- 11 Protection of Existing Facilities: Contractor shall protect all existing infrastructure, utilities landscaping and other site elements. Contractor shall replace or compensate the Owner for damage
- 12 Indemnification: The Contractor shall defend, indemnify, and hold the Owner, the Architect, its employees and consultants, harmless from any and all liability, real or alleged, in connection with the performance of work on this Project, excepting for liability arising from the sole negligence of the Owner, the Architect, its employees and consultants.
- 13 Errors, Omissions & Conflicts: Any errors, omissions, or conflicts found in the various parts of the construction documents or between the construction documents and existing site conditions shall be immediately brought to the attention of the Architect and the Owner before submitting cost estimates, bids or proceeding with the Work.
- 14 Changes: Should any conditions develop which suggest or require changes to the work, including but not limited to errors, omissions, conflicts, alternates or code compliance, the Contractor shall submit to the Architect a written Request for Change Order detailing the required work and associated costs changes. A written Change Order shall be prepared by the Architect and signed by the Contractor before proceeding with the work. No claim shall be allowed for work already started or completed. No claim shall be allowed for difficulties encountered that could have reasonably been inferred from examination of the site and the construction documents prior to submitting the bid. No claim shall be allowed for adjustments which could be reasonably expected based on the Contractor's general experience in this type of construction.
- 15 The Heating System: There shall be a new heating system for both units.
- 16 There is no Fire Sprinkler System in the existing structure and none shall be provided in this
- 17 All persons working at this site must implement applicable portions of the State Storm Water Best Management Practices Manual for Construction to the maximum extent practicable to prevent erosion and sediment from entering into the storm drain system.
- 19. No person shall erect (including excavation and grading), demolish, alter or repair any building or structure other than between the hours as allowed by Contra Costa County.

WASTE MANAGEMENT PLAN

1. If required by Contra Costa County, the Contractor shall provide a Waste Management Plan, and shall provide waste diversion in accordance with the Plan and County requirements. In addition, all cardboard, concrete, asphalt and metals shall be diverted from the waste stream.

EROSION, SEDIMENT, & STORMWATER NOTES

- 1 The Contractor shall maintain controls that do not permit soil and sediment to leave the site via erosion or wind.
- 2. Exposed and disturbed soil shall be surrounded by a straw wattle to prevent runoff. Straw mulch
- 3. Stockpiles of soil, sand or gravel shall be covered with secured plastic tarps to prevent material from being blown off site, and shall be surrounded by straw wattles to prevent storm runoff.
- 4. Concrete trucks shall be washed offsite, at a site owned or used by the contractor that has been approved for this activity.
- 5. Concrete waste water including site mixed concrete and sweepings from exposed aggregate concrete, shall not be allowed to drain into storm sewers. Contractor shall provide a temporary drying basin for any washout, and dry residue collected from that basin shall be disposed of in accordance with City of Oakland disposal regulations. The drying basin may be excavated below grade or fabricated with perimeter straw bales above grade, but shall have sufficient volume for all water discharge, and shall be lined with minimum 10 mil polyethylene sheeting free of holes or tears, staked into ground or bales.

DRAWING INDEX

RCHITECTURAL				
IO.	SHEET NAME	DATE		
1.1	SITE PLAN, PROJECT INFORMATION, VICINITY MAP,	11 Nov 2025		
	GENERAL NOTES			
1.2	SURVEY	11 Nov 2025		
1.3	EXISTING/ DEMOLITION PLANS AND ELEVATIONS	11 Nov 2025		
2.1	LOWER LEVEL PLAN	11 Nov 2025		
2.2	LOWER LEVEL REFLECTED CLG PLAN	11 Nov 2025		
2.3	UPPER LEVEL PLAN	11 Nov 2025		
2.4	UPPER LEVEL REFLECTED CLG PLAN	11 Nov 2025		
\ 3.1	EXTERIOR ELEVATIONS	11 Nov 2025		
3.2	BUILDING SECTIONS	11 Nov 2025		
\3.3	BUILDING SECTIONS	11 Nov 2025		
-				

CODE INFORMATION

APPLICABLE CODES:

(4)

____-

PRINCETON

-PROJECT

LOCATION

27

(S)

ASSESSORS PARCEL MAP

571 PB

A1.1 no scale

1 \ SITE PLAN

A1.1/ 1/8" = 1'-0"

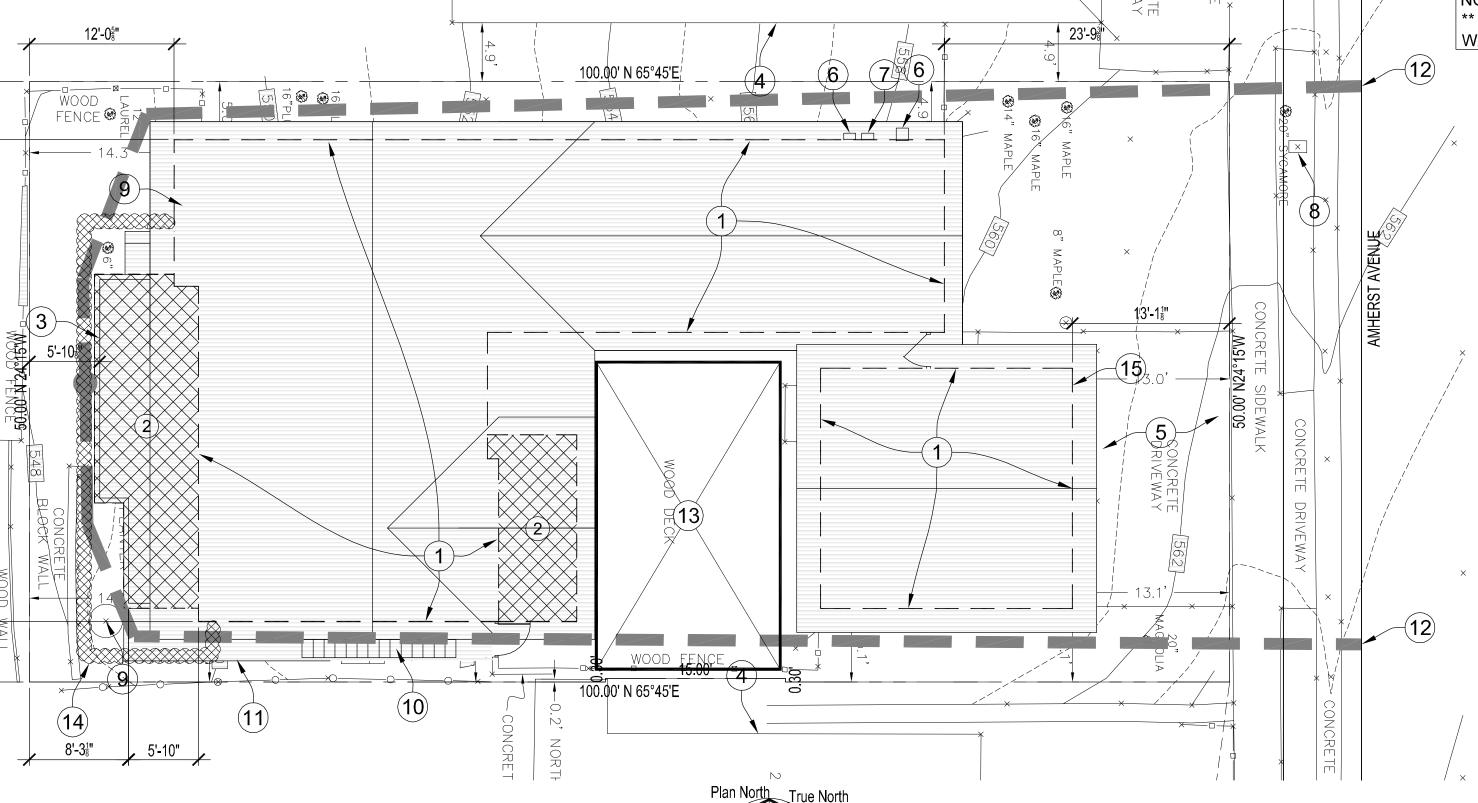
The following Codes shall apply to this project: 2022 California Residential Code (CRC 2022 Mechanical Code (CMC), 2022 Electrical Code (CEC), 2022 Plumbing Code (CPC), 2022 California Green Building Standards (CalGreen), and 2022 California Title 24 Energy Standards; all including errata and supplements, as amended by Contra Costa County.

FIRE SPRINKLERS AND FIRE ALARMS

A fire sprinkler system is not required. Local fire alarms shall be provided in both units, interconnected in the new ADU. **DEFERRED SUBMITTALS**



-PROJECT **VICINITY MAP LOCATION** A1.1 no scale



PROJECT DESCRIPTION

Addition and remodel to create a new Accessory Dwelling Unit and Laundry on the Lower Level, and new Deck, expanded Kitchen, and remodeled Primary Suite on the Upper Level. The addition will have fiber cement siding and flat panelling. The roof will be composite shingles, windows will be vinyl or fiberglass. There is no excavation required for the project other than for new footings/ foundations.

732 Gilman Street Berkeley, CA 94710 Tel: 510.558.1075 Fax: 510.558.1076 info@vanmechelenarchitects.com

Structural Engineer

VanMechelen Architects

Project Team

Greg VanMechelen

PROJECT INFORMATION RECEIVED on 11/18/2025 CDDP25-0303. Kensington, CA 9470 Department of Conservation and Development

> 570-050-004 Juli and Ken Kurtzman 210 Amherst Avenue Kensington, CA 94708

805.390.8122 julikurtzman@gmail.com

PROJECT DATA

LEVEL ONE TOTAL HABITABLE

LEVEL TWO BALCONY/ DECK

COVERAGE PERCENTAGE

BUILDING HEIGHT - FEET

OFF STREET PARKING

BUILDING HEIGHT - STORIES

TOTAL AREA INCLUDING GARAGE

TOTAL HABITABLE FLOOR AREA 3204 SF

LEVEL TWO

COVERAGE AREA

PARCEL NUMBER

OWNER

	EXISTING	PROPOSED	REQUIRED/ ALLOWED
ZONING	R-6 -TOV -K	NO CHANGE	
WILDLAND FIRE HAZARD RISK	YES	NO CHANGE	
FLOOD ZONE	NO	NO CHANGE	
ALQUIST-PRIOLO FAULT ZONE	NO	NO CHANGE	
LIQUEFACTION RISK	VERY LOW	NO CHANGE	
OCCUPANCY TYPE	R-3/ U	NO CHANGE	
CONSTRUCTION TYPE	V-B	NO CHANGE	
LOT AREA	4995.5 SF	NO CHANGE	
AVERAGE LOT SLOPE	14%	NO CHANGE	
NO. OF DWELLING UNITS	1	1 + ADU	2
MAIN HOUSE SETBACKS			
FRONT (EAST)	23'-9"	NO CHANGE	
FRONT GARAGE	13'-0"	NO CHANGE	
REAR (WEST)	12'-4"	5'-10"	15'-0"
LEFT SIDE (SOUTH)	5'-0"	NO CHANGE	4'-0"
RIGHT SIDE (NORTH)	5'-0"	NO CHANGE	4'-0"
MAIN HOUSE BUILDING AREA			
GARAGE	420 SF	NO CHANGE	
LEVEL ONE MAIN HOUSE*	699 SF	383 SF	-316 SF
LEVEL ONE ADU	0 SF	611 SF	611 SF
LEVEL ONE NON-HABITABLE	891 SF	746 SF	-145 SF
		1	·

2017 SF PRIVATE OPEN SPACE 1700 SF * LEVEL ONE AREA INCREASE INCLUDES CONVERSION OF 145 SF OF NONHABITABLE SPACE, AND 150 SF OF NEW ADDITION.

** HEIGHT INCREASE IS DUE TO LOWER EXISTING DOWNSLOPE GRADE AT WEST WALL EXPANSION.

1590 SF

1614 SF

112 SF

2176 SF

22'-6"

1740 SF

1717 SF

3457 SF

3877 SF

200 SF

NO CHANGE

NO CHANGE 2

2374 SF

23'-3"

150 SF

103 SF

253 SF

253 SF

88 SF

198 SF

SITE PLAN NOTES

SEE SHEET L1.1 FOR LANDSCAPE PLAN

SEE SHEET A2.4 FOR ROOF PLAN

(1) EXISTING BUILDING OUTLINE PROPOSED ADDITIONS, EXPANSION AREA SHOWN IN HATCH

NEW UPPER LEVEL DECK

NEIGHBORING HOUSES

EXISTING DRIVEWAY AND GARAGE TO REMAIN

EXISTING GAS AND ELECTRIC METERS

NEW ELECTRIC METER FOR ADU, VERIFY LOCATION AND INSTALL PER UTILITY

REQUIREMENTS AND THE CALIFORNIA ELECTRIC CODE

(8) EXISTING WATER METER

(9) EXISTING SEWER LINE CLEANOUT. VERIFY LOCATION AND CONDITION OF EXG SEWER LINE,

PROJECT INFORMATION REPLACE EXISTING SEWER LINE IF REQUIRED, FIELD VERIFY LOCATION. PROVIDE CLEANOUT AT ANY BEND >45°.

(10) NEW WOOD STAIRS TO ACCESS ADU, SEE FLOOR PLAN 1/A2.1

NEW PERVIOUS CONCRETE OR PAVER WALK PATH

12) FIRE HOSE LENGTH TO FARTHEST SECTION OF STRUCTURE = 125'-0" (13) CONSTRUCTION STAGING AREA. MATERIALS SHALL BE STORED IN SUCH MANNER AS TO

PREVENT LEAKAGE, OR BLOWING BY WINDS. (14) PROVIDE STRAW WATTLES FOR EROSION CONTROL THROUGHOUT CONSTRUCTION. WATTLES SHALL BE TUBULAR IN SHAPE, ±10" Ø, 20'-30' LONG, FILLED WITH STRAW AND HOUSED IN BIODEGRADABLE NETTING. WATTLES SHALL BE PLACED TO PREVENT WATER RUNOFF IN A TRENCH 3"-5" DEEP, STAKED WITH 1"X1"X24" STAKES ±24" O.C. SEE 2/L1.1.

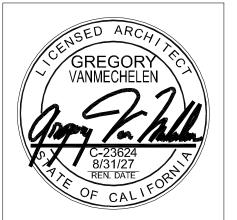
(15) PROVIDE STREET ADDRESS SIGNAGE, SEE SHEET A3.1

HEAT PUMP COMPRESSOR/ OUTDOOR UNIT. INSTALL PER MANUFACTURER'S INSTRUCTION.

(17) PROVIDE CONCRETE SLAB IN ACCORDANCE WITH MANUFACTURER'S REQUIREMENTS.

Title 24 Energy Consultant

Sprinkler and Fire Alarm



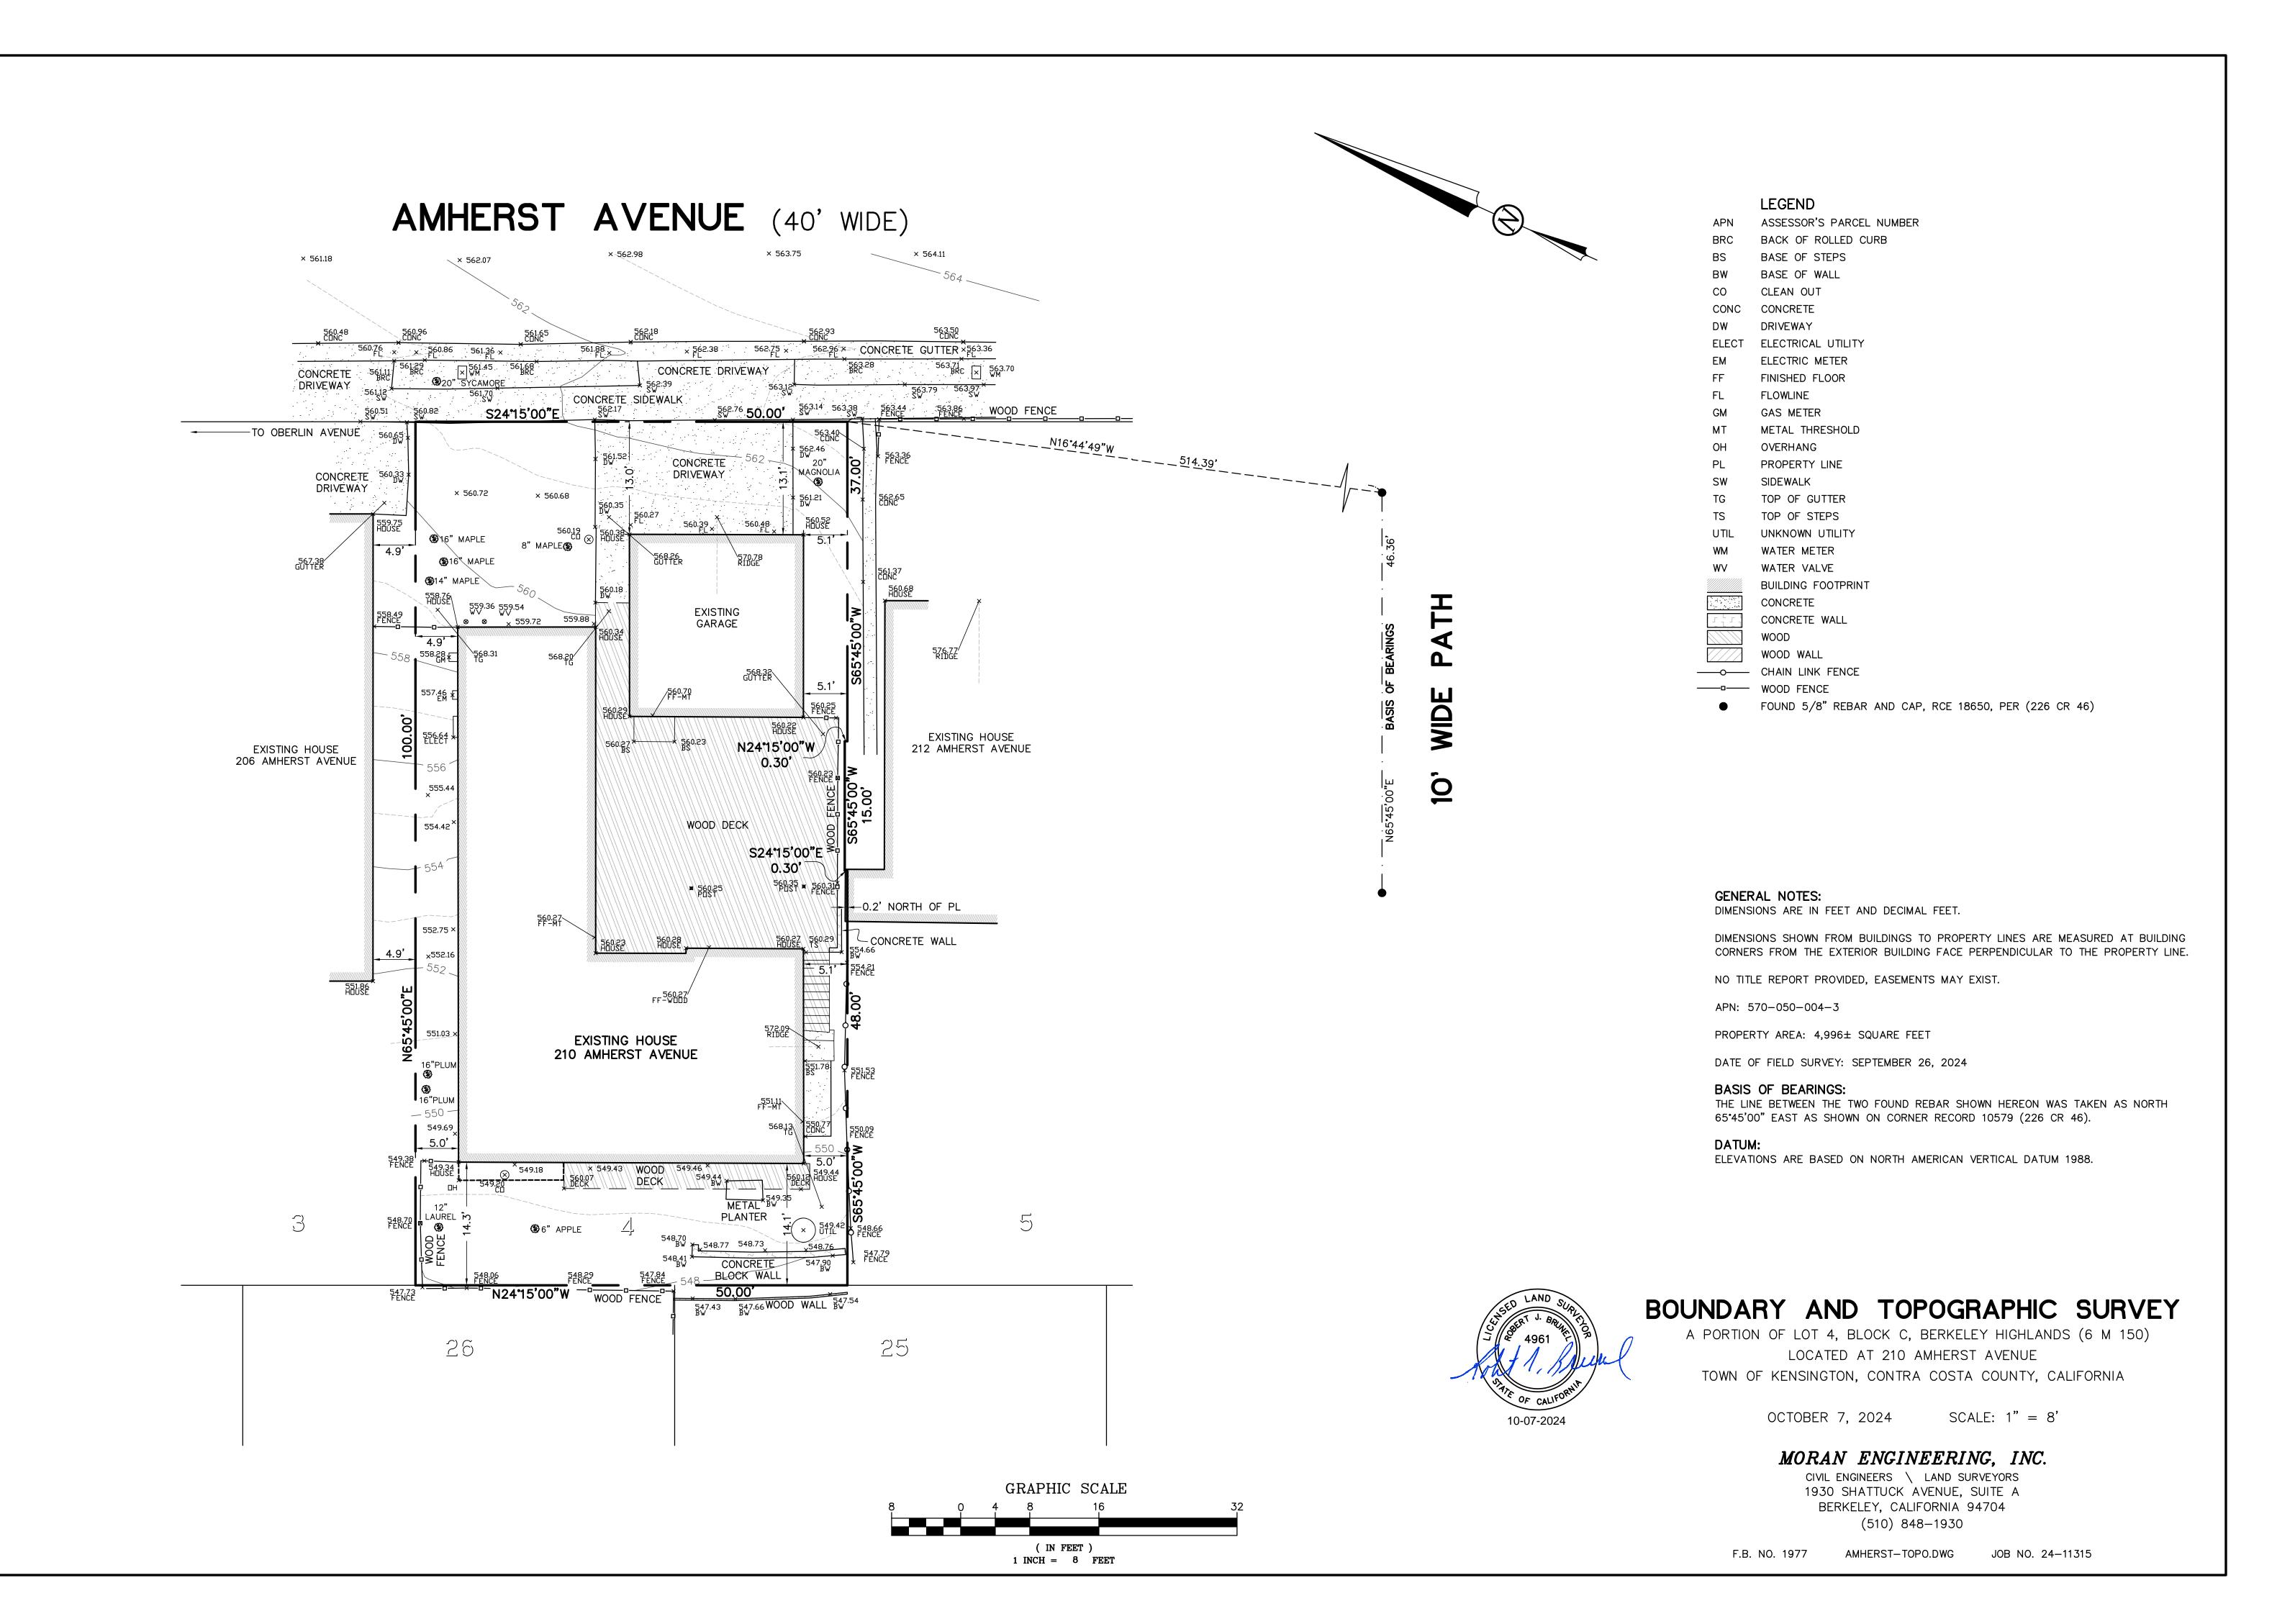
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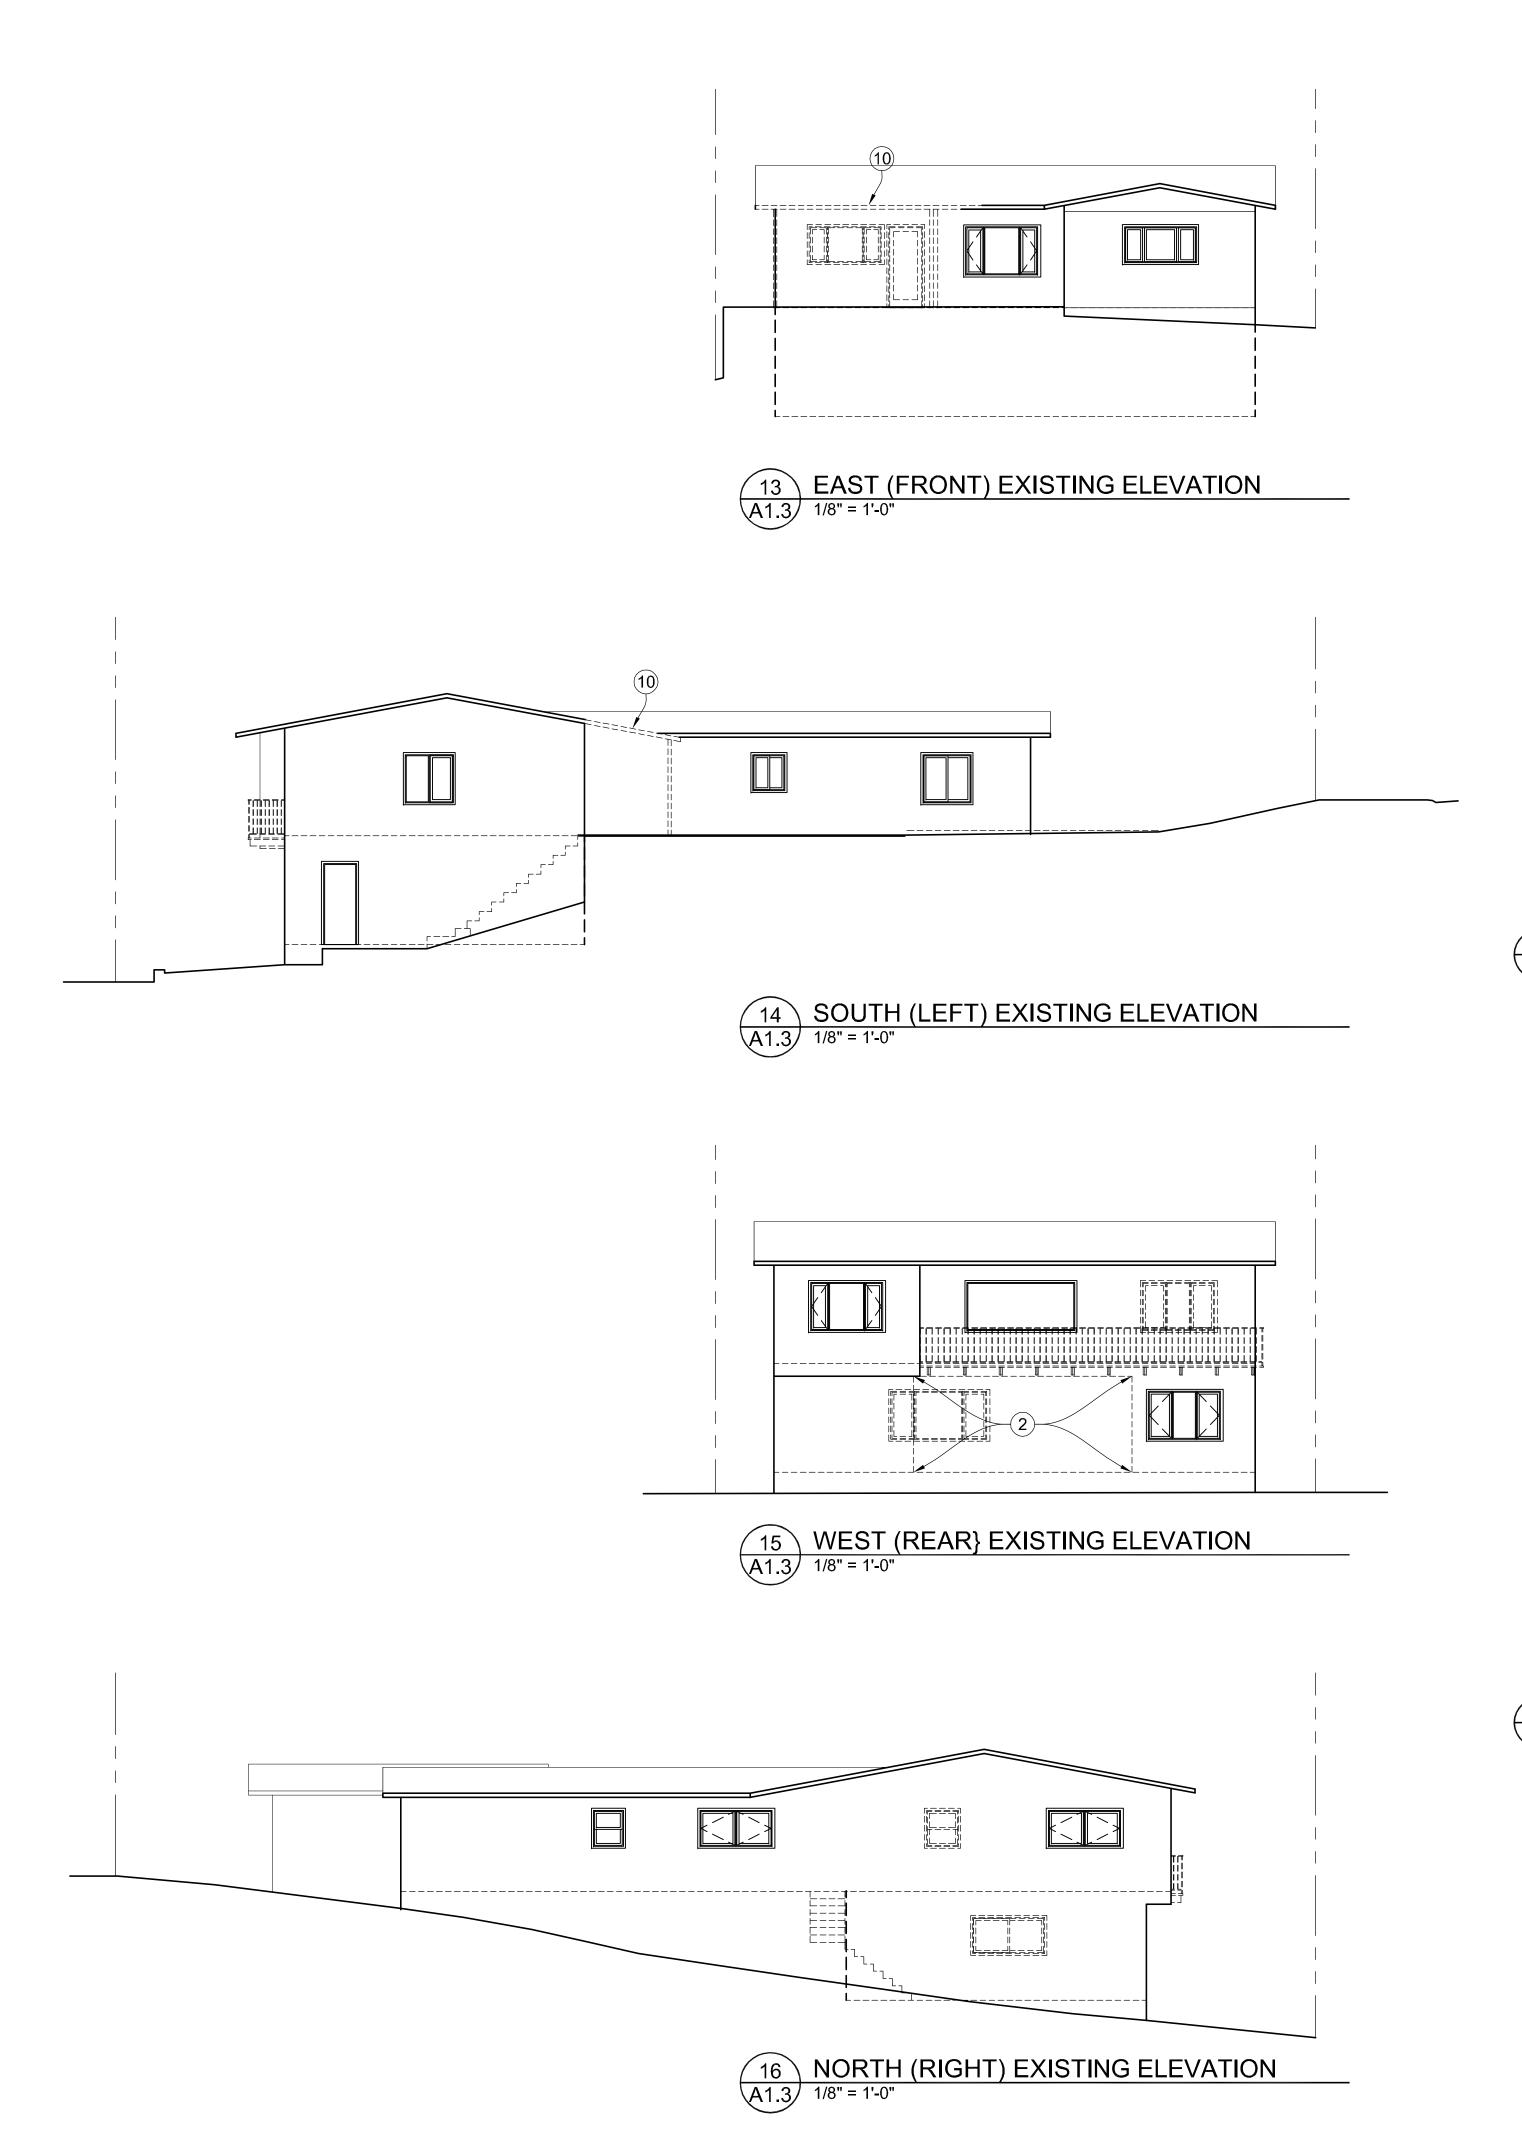
SITE PLAN VICINITY MAP **GENERAL NOTES**

Revision	on
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Date:	3 November 2025

Drawn:

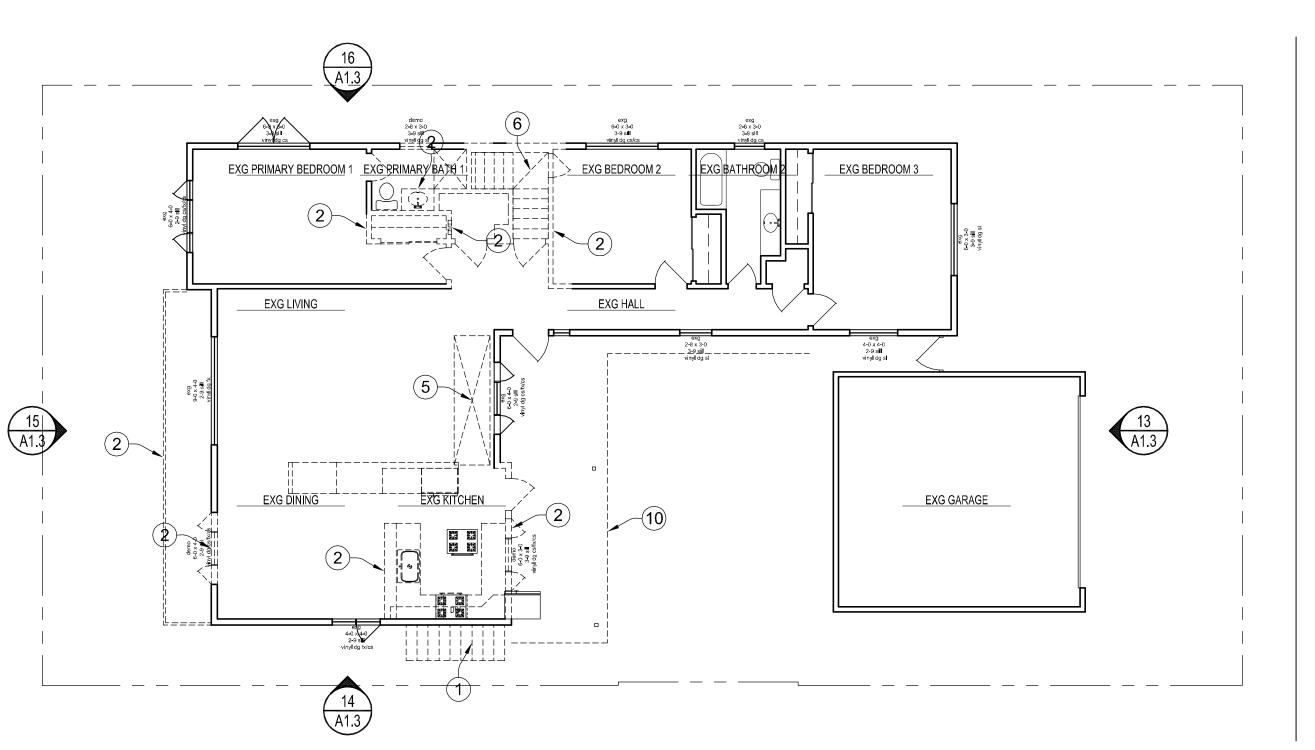
Scale

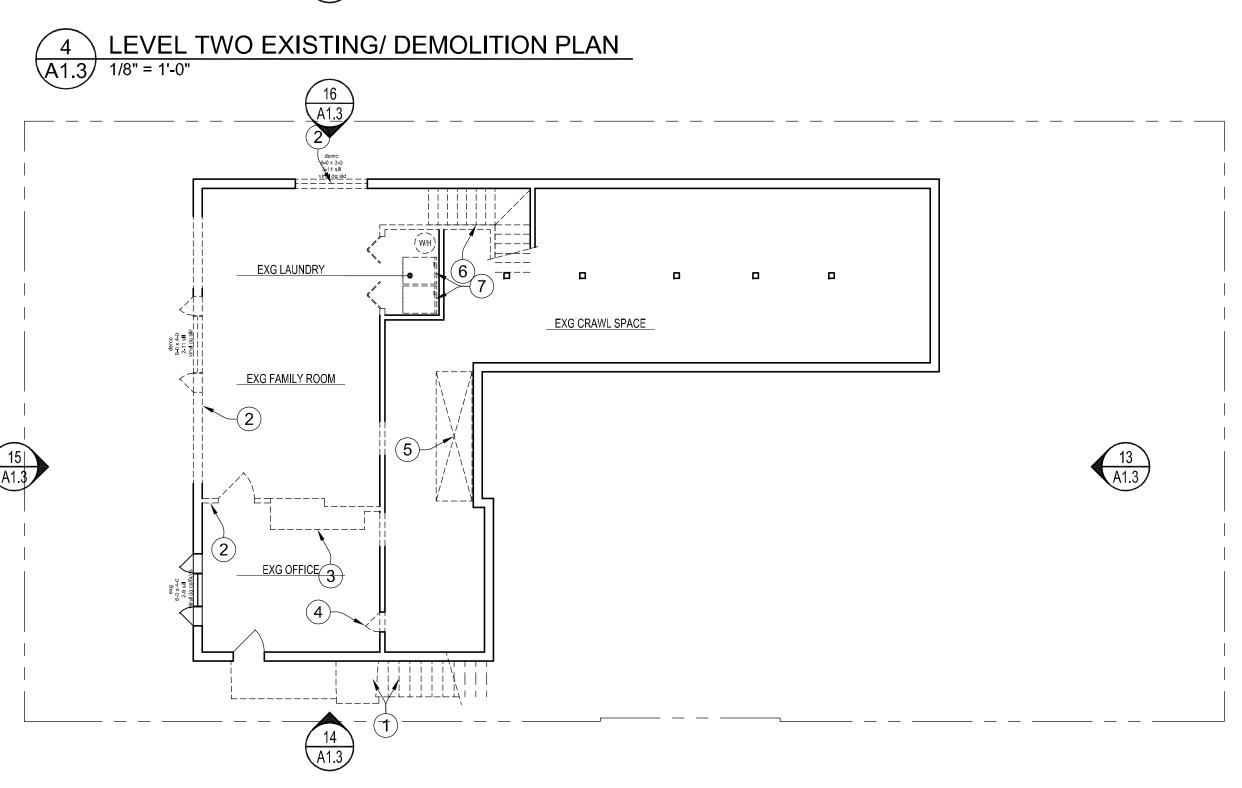




DEMOLITION NOTES

- 1 REMOVE EXISTING EXTERIOR STAIRS AND CONCRETE LANDING AND PATH.
- 2 REMOVE EXISTING WALLS, DOORS AND FIXTURES AS INDICATED. SALVAGE PER OWNER'S DIRECTION, AND DISPOSE PER REQUIREMENTS OF CALGREEN AND CONTRA COSTA
- COUNTY WASTE DIVERSION REQUIREMENTS.
- (3) REMOVE EXISTING BRICK FIREPLACE AND CHIMNEY.
- (4) REMOVE EXISTING CRAWL SPACE ACCESS DOOR
- 5 REMOVE SECTION OF FLOOR AS REQUIRED FOR NEW STAIR
- 6 REMOVE EXISTING INTERIOR STAIR
- 7 REMOVE EXISTING WASHER AND DRYER
- 8 REMOVE EXISTING WALL SECTION FOR NEW WINDOW OR DOOR
 9 EXISTING FLOOR LEVEL AND FRAMING TO REMAIN. NOTIFY ARCHITECT AND STRUCTURAL
 ENGINEER OF ANY FLOOR FRAMING LESS THAN 2X8 @ 16" O.C., OR ANY FRAMING THAT HAS
 BEEN CUT, SPLICED, OR INDICATES ROT OR OTHER DAMAGE, OR FRAMING THAT HAS BEEN
- CHANGED IN ANY MANNER THAT IS NOT CONSISTENT WITH THE WOOD FRAMING STANDARDS IN THE CALIFORNIA RESIDENTIAL CODE.
- 10 REMOVE SECTION OF ROOF, SEE ELEVATION NOTE #2/A3.1.





4 LEVEL ONE EXISTING/ DEMOLITION PLAN
A1.3 1/8" = 1'-0"

5 10 ft

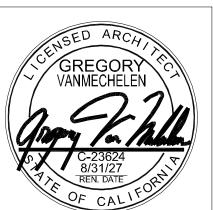
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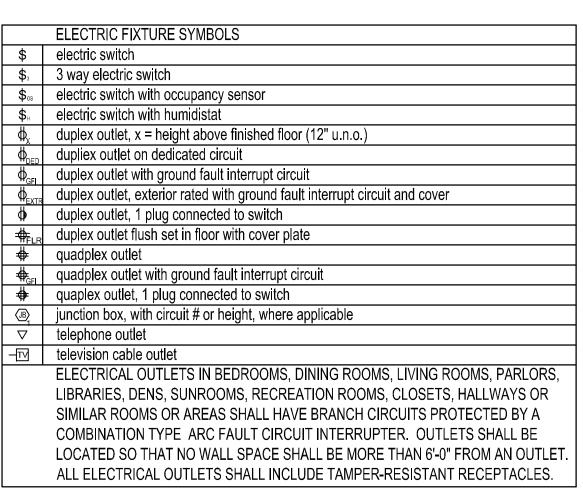


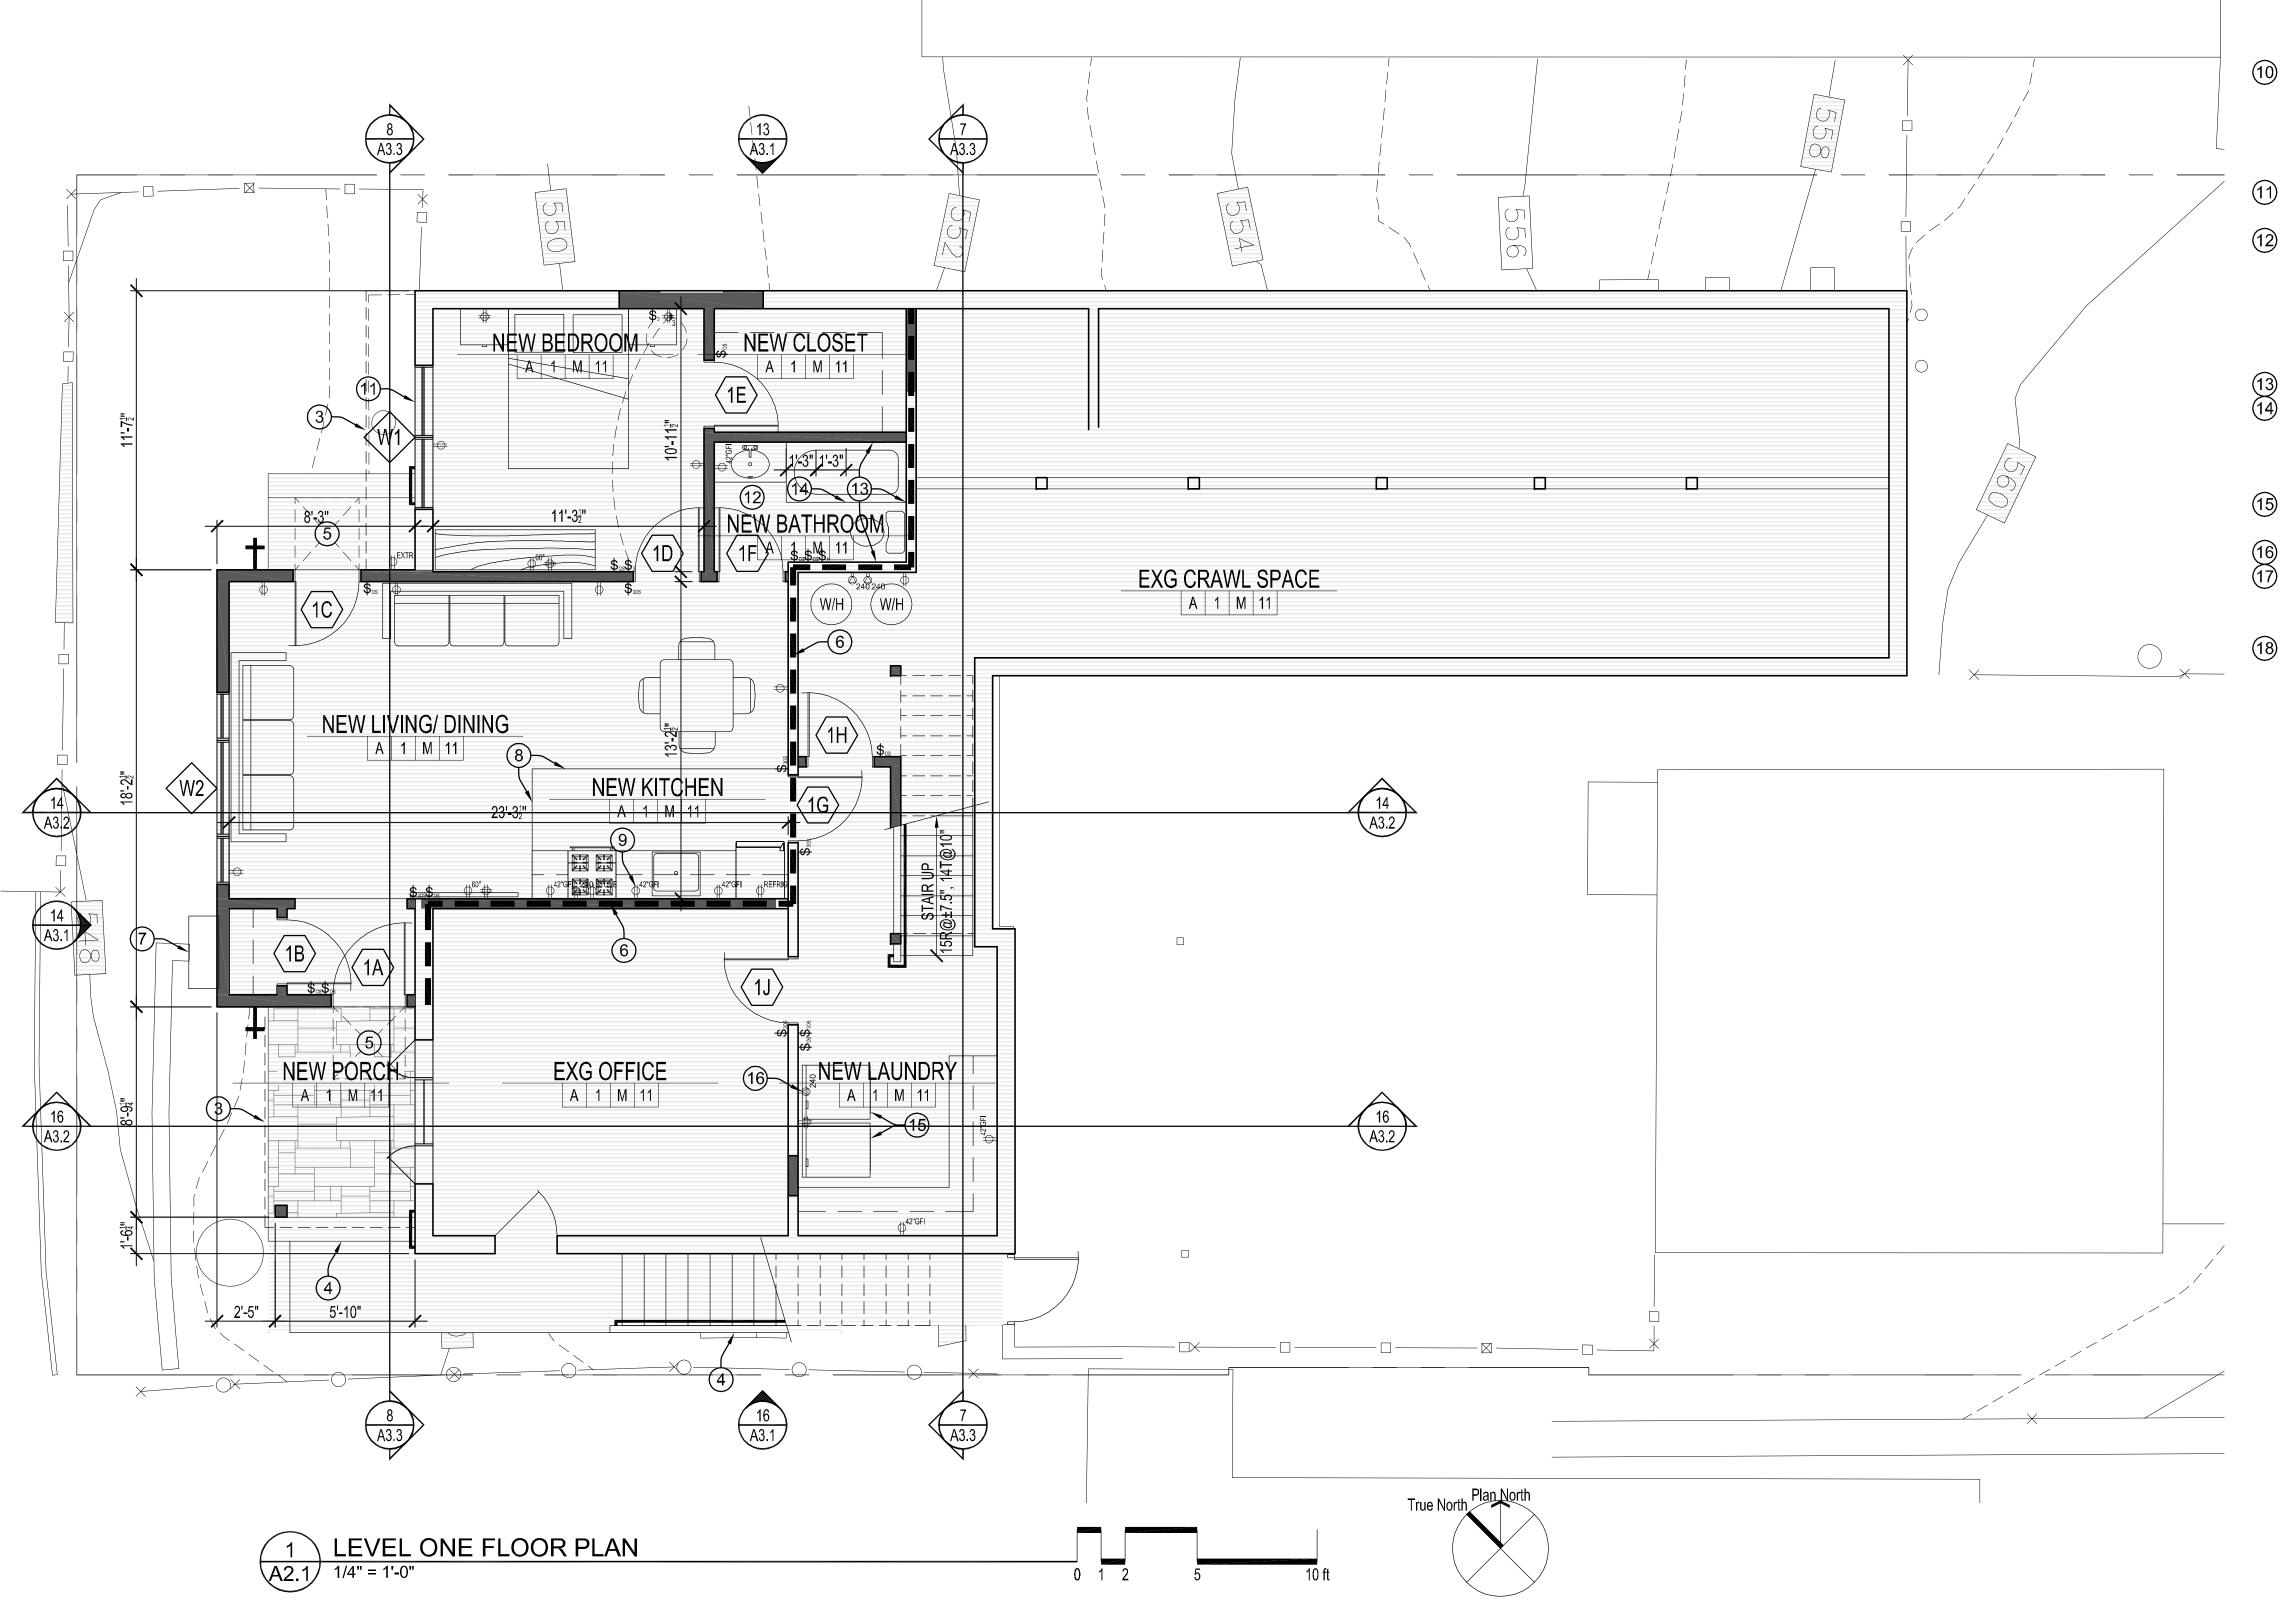
urtzman vvenue v 94708

PLAINING SOB Residential Renovation Sulington, CA

EXISTING/ DEMOLITION PLANS AND ELEVATIONS

A1.3





LEVEL ONE PLAN NOTES

ALL DIMENSIONS ARE TO FACE OF FINISH, UNLESS OTHERWISE NOTED.

SEE FOR WALL TYPES

(1) WALKWAY, SEE SITE PLAN A1.1

(2) HOSE BIB

(2) HUSE BIB
(3) PROJECTING OVERHANG ABOVE

EXTERIOR STAIRS WITH MAX 7.75" RISERS, 11" TREAD - MIN. 10" TREAD REQUIRED. PROVIDE 1½" WOOD HANDRAIL MIN 1 SIDE, 34" ABOVE TREAD NOSINGS, 1½" CLEAR FROM WALL, RETURN AT ENDS. STAIRS SHALL HAVE A MINIMUM WIDTH OF 36" ABOVE HANDRAIL. WHERE ADJOINING SURFACE IS > 2'-6" BELOW STAIR WITHIN 3'-0" HORIZONTAL. PROVIDE GUARDRAIL MIN. 34" HIGH WITH NO OPENING ALLOWING PASSAGE OF 4" Ø SPHERE. SEE SECTION AT 12/A4.2 PROVIDE 3'-0" LANDING AT TOP AND BOTTOM OF STAIR, A DOOR OR GATE THAT DOES NOT SWING OVER THE TOP STAIR IS PERMITTED AT THE TOP OF THE STAIR.

- 5 PROVIDE MIN. 36" DEEP LANDING AT EXTERIOR DOORS, MAX 7.75" BELOW DOOR THRESHOLD WHERE DOOR DOES NOT SWING OVER STEP, SLOPE MAX. 2% SLOPE.
- 6 1 HOUR FIRE RATED WALL FOR DWELLING UNIT SEPARATION WITH MINIMUM STC OF 45. SEE DETAIL 3/A4.2
- 7 TWO ZONE WALL MOUNTED HEAT PUMP CONDENSER UNIT. LOCATION FOR INDOOR AIR HANDLING UNITS TO BE DETERMINED.
- (8) JOINT BETWEEN WOOD AND TILE OR RESILIENT FLOORING
- PROVIDE GFI ELECTRICAL OUTLETS ON COUNTER SIDE SO THAT NO COUNTER SPACE IS NO MORE THAN 2'-0" FROM AN OUTLET. PROVIDE MIN. (2) 20 AMP CIRCUITS TO COUNTERTOP OUTLETS FOR SMALL APPLIANCES, AND PROVIDE SEPARATE CIRCUIT FOR REFRIGERATOR OUTLET. OUTLETS MAY BE DELETED WHERE FULL HEIGHT CABINETS ARE PROVIDED.
- NEW INTERIOR STAIR WITH MAX 7.75" RISERS, MIN. 10" TREAD. PROVIDE $1\frac{1}{2}$ "Ø WOOD HANDRAIL MIN 1 SIDE, 34" ABOVE TREAD NOSINGS, $1\frac{1}{2}$ " CLEAR FROM WALL, RETURN AT ENDS. STAIRS SHALL HAVE A MINIMUM WIDTH OF 36" ABOVE HANDRAIL. WHERE ADJOINING SURFACE IS > 2'-6" BELOW STAIR WITHIN 3'-0" HORIZONTAL. PROVIDE GUARDRAIL MIN. 34" HIGH WITH NO OPENING ALLOWING PASSAGE OF 4" Ø SPHERE.
- PROVIDE EGRESS/ RESCUE WINDOW AT BEDROOMS. SEE DOOR AND WINDOW SCHEDULE SHEET A-2.4 FOR REQUIREMENTS.
- NEW PLUMBING FIXTURES SHALL HAVE THE FOLLOWING FLOW RATES:
 TOILETS: EFFECTIVE FLUSH VOLUME SHALL NOT EXCEED 1.28 GALLONS
 SHOWERHEADS: MAX 1.8 GPM @ 80 PSI
 LAVATORY FAUCETS: MAX 1.2 GPM @ 60 PSI (0.8 GPM AT 20 PSI MIN)
- WRAP ALL EXPOSED HOT WATER PIPES WITH MIN. R-4 INSULATION
- PROVIDE NONABSORBENT WALL SURFACE TO MIN. 6' ABOVE FLOOR AT TUB/ SHOWER.

 SHOWER SHALL HAVE A MIN. 1024 SQ IN OF INTERIOR AREA, AND PROVIDE SPACE FOR A
- MIN. 30"Ø CIRCLE. GLASS IN SHOWER ENCLOSURES SHALL BE APPROVED SAFETY GLASS, AND SHOWER DOORS, IF PROVIDED SHALL BE MIN. 24" CLEAR WIDTH AND SHALL OPEN OUTWARD FROM THE SHOWER COMPARTMENT.
- SIDE BY SIDE WASHER/ DRYER, PROVIDE SHUT-OFF VALVE FOR ANY GAS LINE. VENT DRYER THROUGH THE SOUTH WALL. PROVIDE 30 AMP CIRCUIT TO LAUNDRY.
- PROVIDE 240V OUTLET FOR POTENTIAL ELECTRIC DRYER.

KITCHEN FAUCETS: MAX 1.8 GPM @ 60 PSI

- NEW AND/ OR RELOCATED HOT WATER HEATERS FOR MAIN HOUSE AND ADU. PROVIDE 240V ELECTRICAL OUTLET FOR HEAT PUMP. PROVIDE PAN AND CONDENSATE LINE TO EXTERIOR.
- 18) ELECTRICAL SUB-PANEL

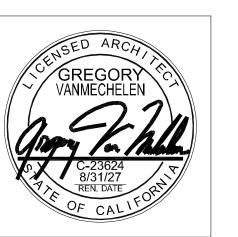
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Sesidential Renovations for:

Juli and Ken Kurtzman
210 Amherst Avenue
Kensington, CA 94708
APN 570-050-004

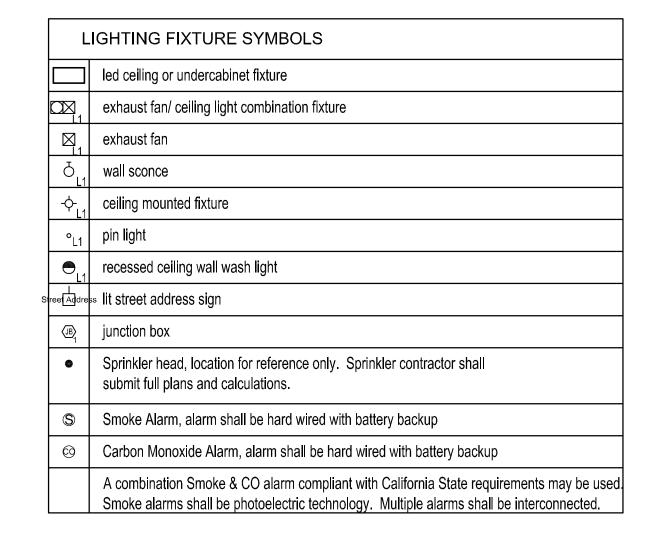
LOWER LEVEL FLOOR PLAN

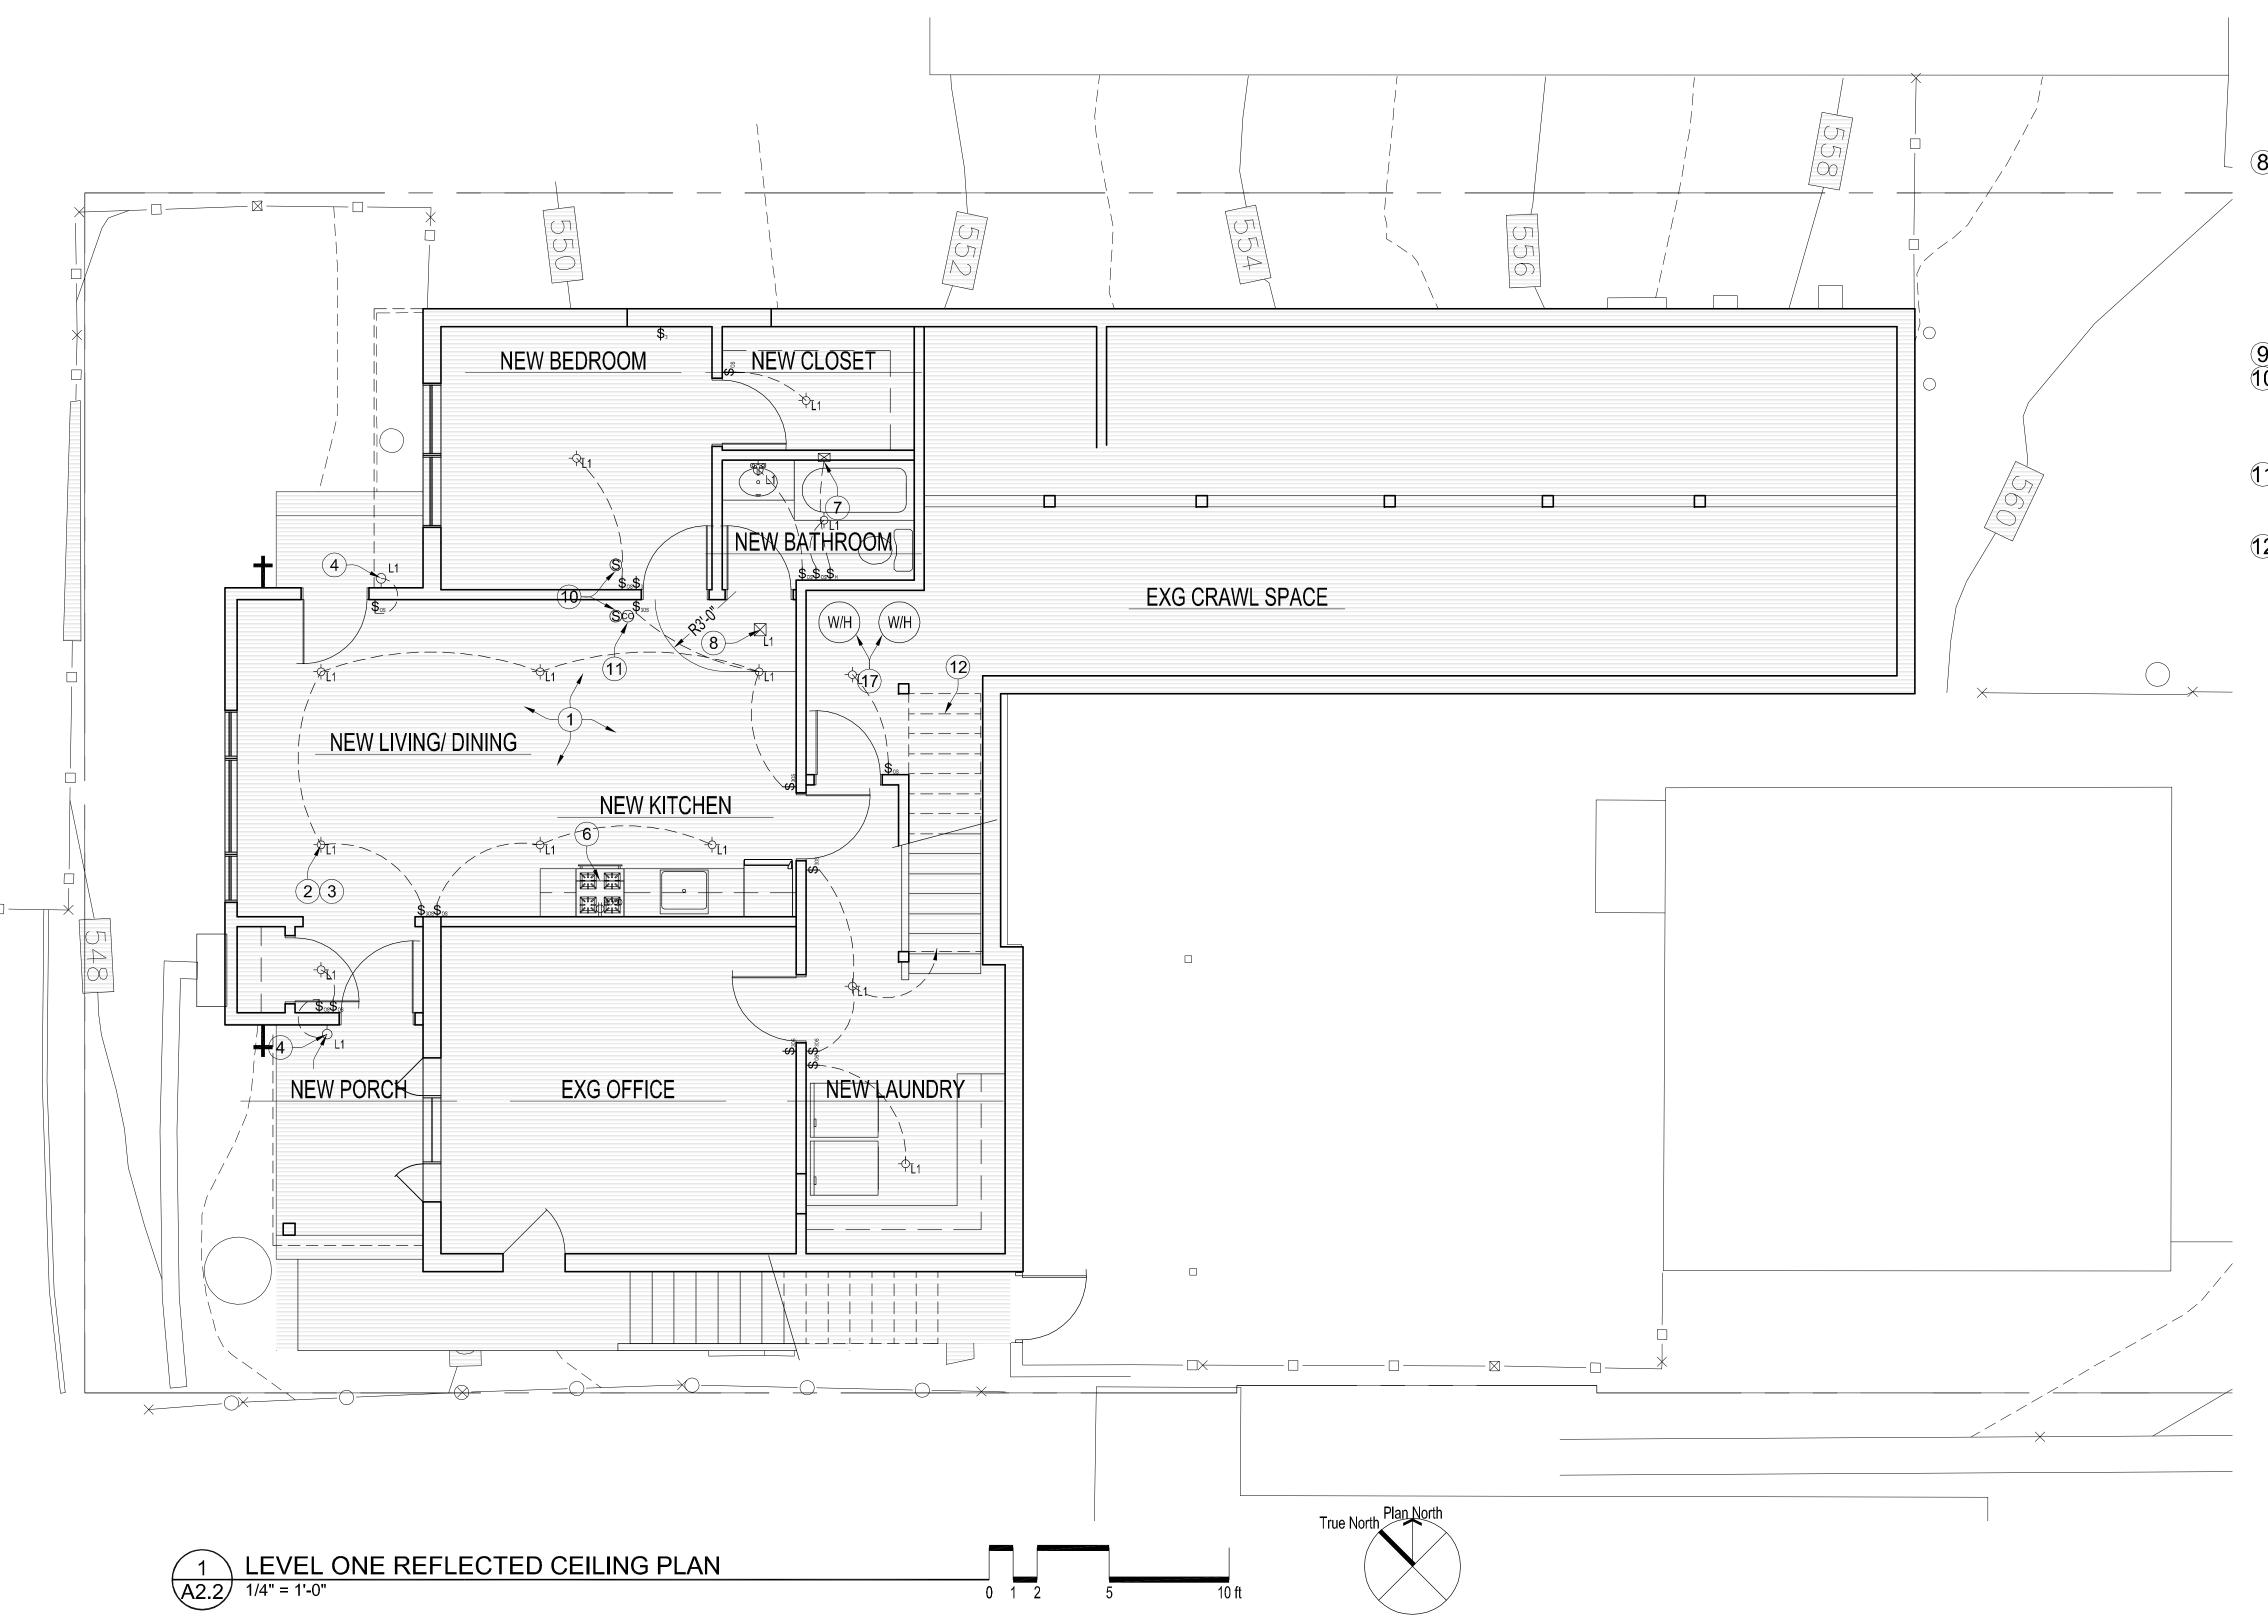
FINISH SCHEDULE			
FLOOR	BASE	WALLS	CEILINGS
A. WOOD	1. PAINTED WOOD OR MDF	M. GYPSUM BOARD TYPE 1	11. GYPSUM BOARD
B. CERAMIC TILE	2. CERAMIC TILE	N. CEMENT BOARD OR SHOWER BACKER BOARD	12. PAINTED GYPSUM BOARD
C. CONCRETE	3. RUBBER	O. MIN. ½" GYPSUM BOARD WITH TAPE AND MUD	13. MIN. 5/8 " GYPSUM BOARD WITH TAPE AND MUD

NEW WALL
EXISTING WALL TO REMAIN
EXISTING WALL REMOVED

WALL LEGEND

A2.1





LEVEL ONE REFLECTED CEILING PLAN NOTES

ALL RECESSED CEILING FIXTURES IN INSULATED CEILINGS SHALL BE IC RATED FOR CONTACT WITH INSULATION AND AIRTIGHT LABELED.

ONE HOUR RATED FLOOR-CEILING ASSEMBLY WHERE ACCESSORY

DWELLING UNIT IS BENEATH UPPER LEVEL UNIT. FLOOR CEILING ASSEMBLY

SHALL ALSO HAVE A MINUIMUM STC 45 ACOUSTIC RATING AND MINIMUM 45

IIC RATING. SEE DETAIL 1/A4.2.

- 2 CEILING LIGHT FIXTURES BELOW UPPER UNIT SHALL BE SURFACE MOUNT, OR SHALL BE RATED FOR INSTALLATION IN A ONE HOUR CEILING, OR SHALL BE ENCLOSED IN A FIRE-RATED BOX PER DETAIL 5/A4.2
- NEW LIGHT FIXTURES IN LIVING SPACES SHALL BE HIGH EFFICIACY AND SHALL HAVE OCCUPANCY SENSOR OR DIMMER SWITCH SEE SHEET T24-3 FOR ADDITIONAL LIGHTING REQUIREMENTS.
- 4 EXTERIOR LIGHTING FIXTURES SHALL BE APPROVED DARK SKY RATED, WITH SHIELDING TO PREVENT LIGHT SPILLING ONTO ADJOINING PROPERTIES
- (5) STREET ADDRESS NUMBER, SEE ELEVATION 4/A3.1
- KITCHEN EXHAUST FAN WITH MINIMUM 100 CFM, VENT THROUGH WALL OR ROOF, MIN. 3'-0" FROM PROPERTY LINE AND ANY OPENINGS. SEE ROOF PLAN A2.5 FOR VENT OUTLET LOCATION.
- BATHROOM WALL MOUNTED EXHAUST FAN/ LIGHT, PANASONIC WHISPER LIGHT MIN 50 CFM. FANS SHALL BE ENERGY STAR COMPLIANT AND BE DUCTED TO TERMINATE OUTSIDE THE BUILDING, PROVIDE BACKDRAFT PREVENTER. PROVIDE SEPARATE, HUMIDISTAT CONTROLLED SWITCH FOR FAN. LIGHT SHALL BE HIGH EFFICACY. WHERE EXHAUST FANS OCCUR IN ONE HOUR RATED CEILINGS PROVIDE RATED DAMPER OR PROVIDE LOWERED CEILING TO RUN EXHAUST DUCT HORIZONTALLY WITHOUT PENETRATING RATED CEILING.
- WHOLE HOUSE FAN. ADU FLOOR AREA = 568 SF; 1 BR. 568 x 0.03 + ((1+1) x 7.5) = 17 + 15 = 32. PROVIDE MINIMUM 40 CFM FAN WITH CONTINUOUS OPERATION, MIN. 6" Ø DUCTING, MAX 1 SONE, PANASONIC WHISPERCEILING FV-1115VQ1, OR EQUAL ALTERNATE: PROVIDE VARIABLE SPEED WITH CONTINUOUS OPERATION AT 50 CFM, WHISPERVALUE® DC FAN WITH PICK-A-FLOW®, 50-80-100 CFM, MODEL: FV-0510VS1. IF CEILING MOUNT IS SELECTED PROVIDE GYPSUM WRAP FOR 1 HOUR FIRE RATING PER DETAIL --/A4.1. FAN MAY BE VENTED THROUGH NORTH WALL TO EXTERIOR.

 (9) WALL OR CEILING MOUNTED FAN COIL UNIT, SEE SHEET A2.7.
- PROVIDE SMOKE ALARMS IN ALL BEDROOMS AND HALL OR COMMON SPACE SERVING BEDROOMS, LOCATE MIN. 3'-0" FROM DOOR TO BATHROOMS CONTAINING TUB AND/ OR SHOWER. SMOKE ALARMS SHALL BE HARD WIRED WITH BATTERY BACK-UP, AND SHALL BE INTERCONNECTED.
- PROVIDE AT LEAST (1) CARBON MONOXIDE DETECTOR ON EACH FLOOR LEVEL. CO DETECTORS SHALL BE HARD WIRED WITH BATTERY BACK-UP, AND SHALL BE INTERCONNECTED.
- MINIMUM 5" GYPSUM BOARD APPLIED ON CEILING OF ENCLOSED SPACE UNDER STAIRS.

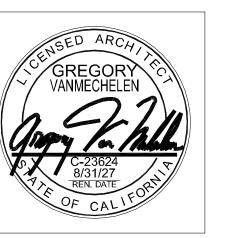
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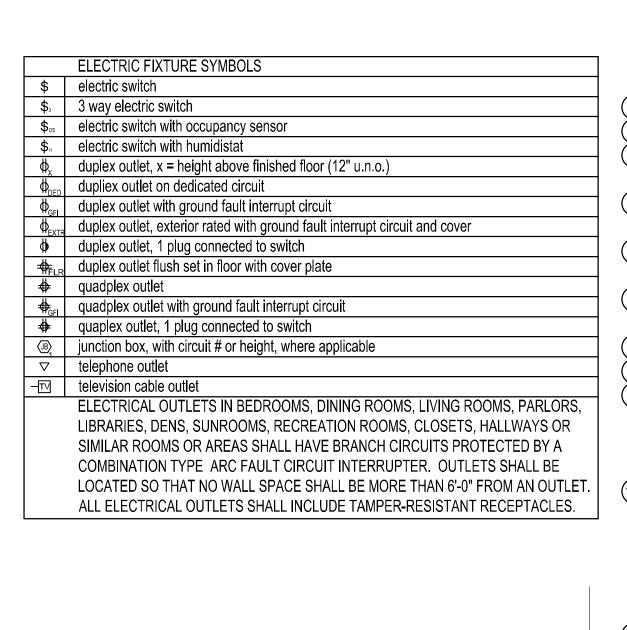


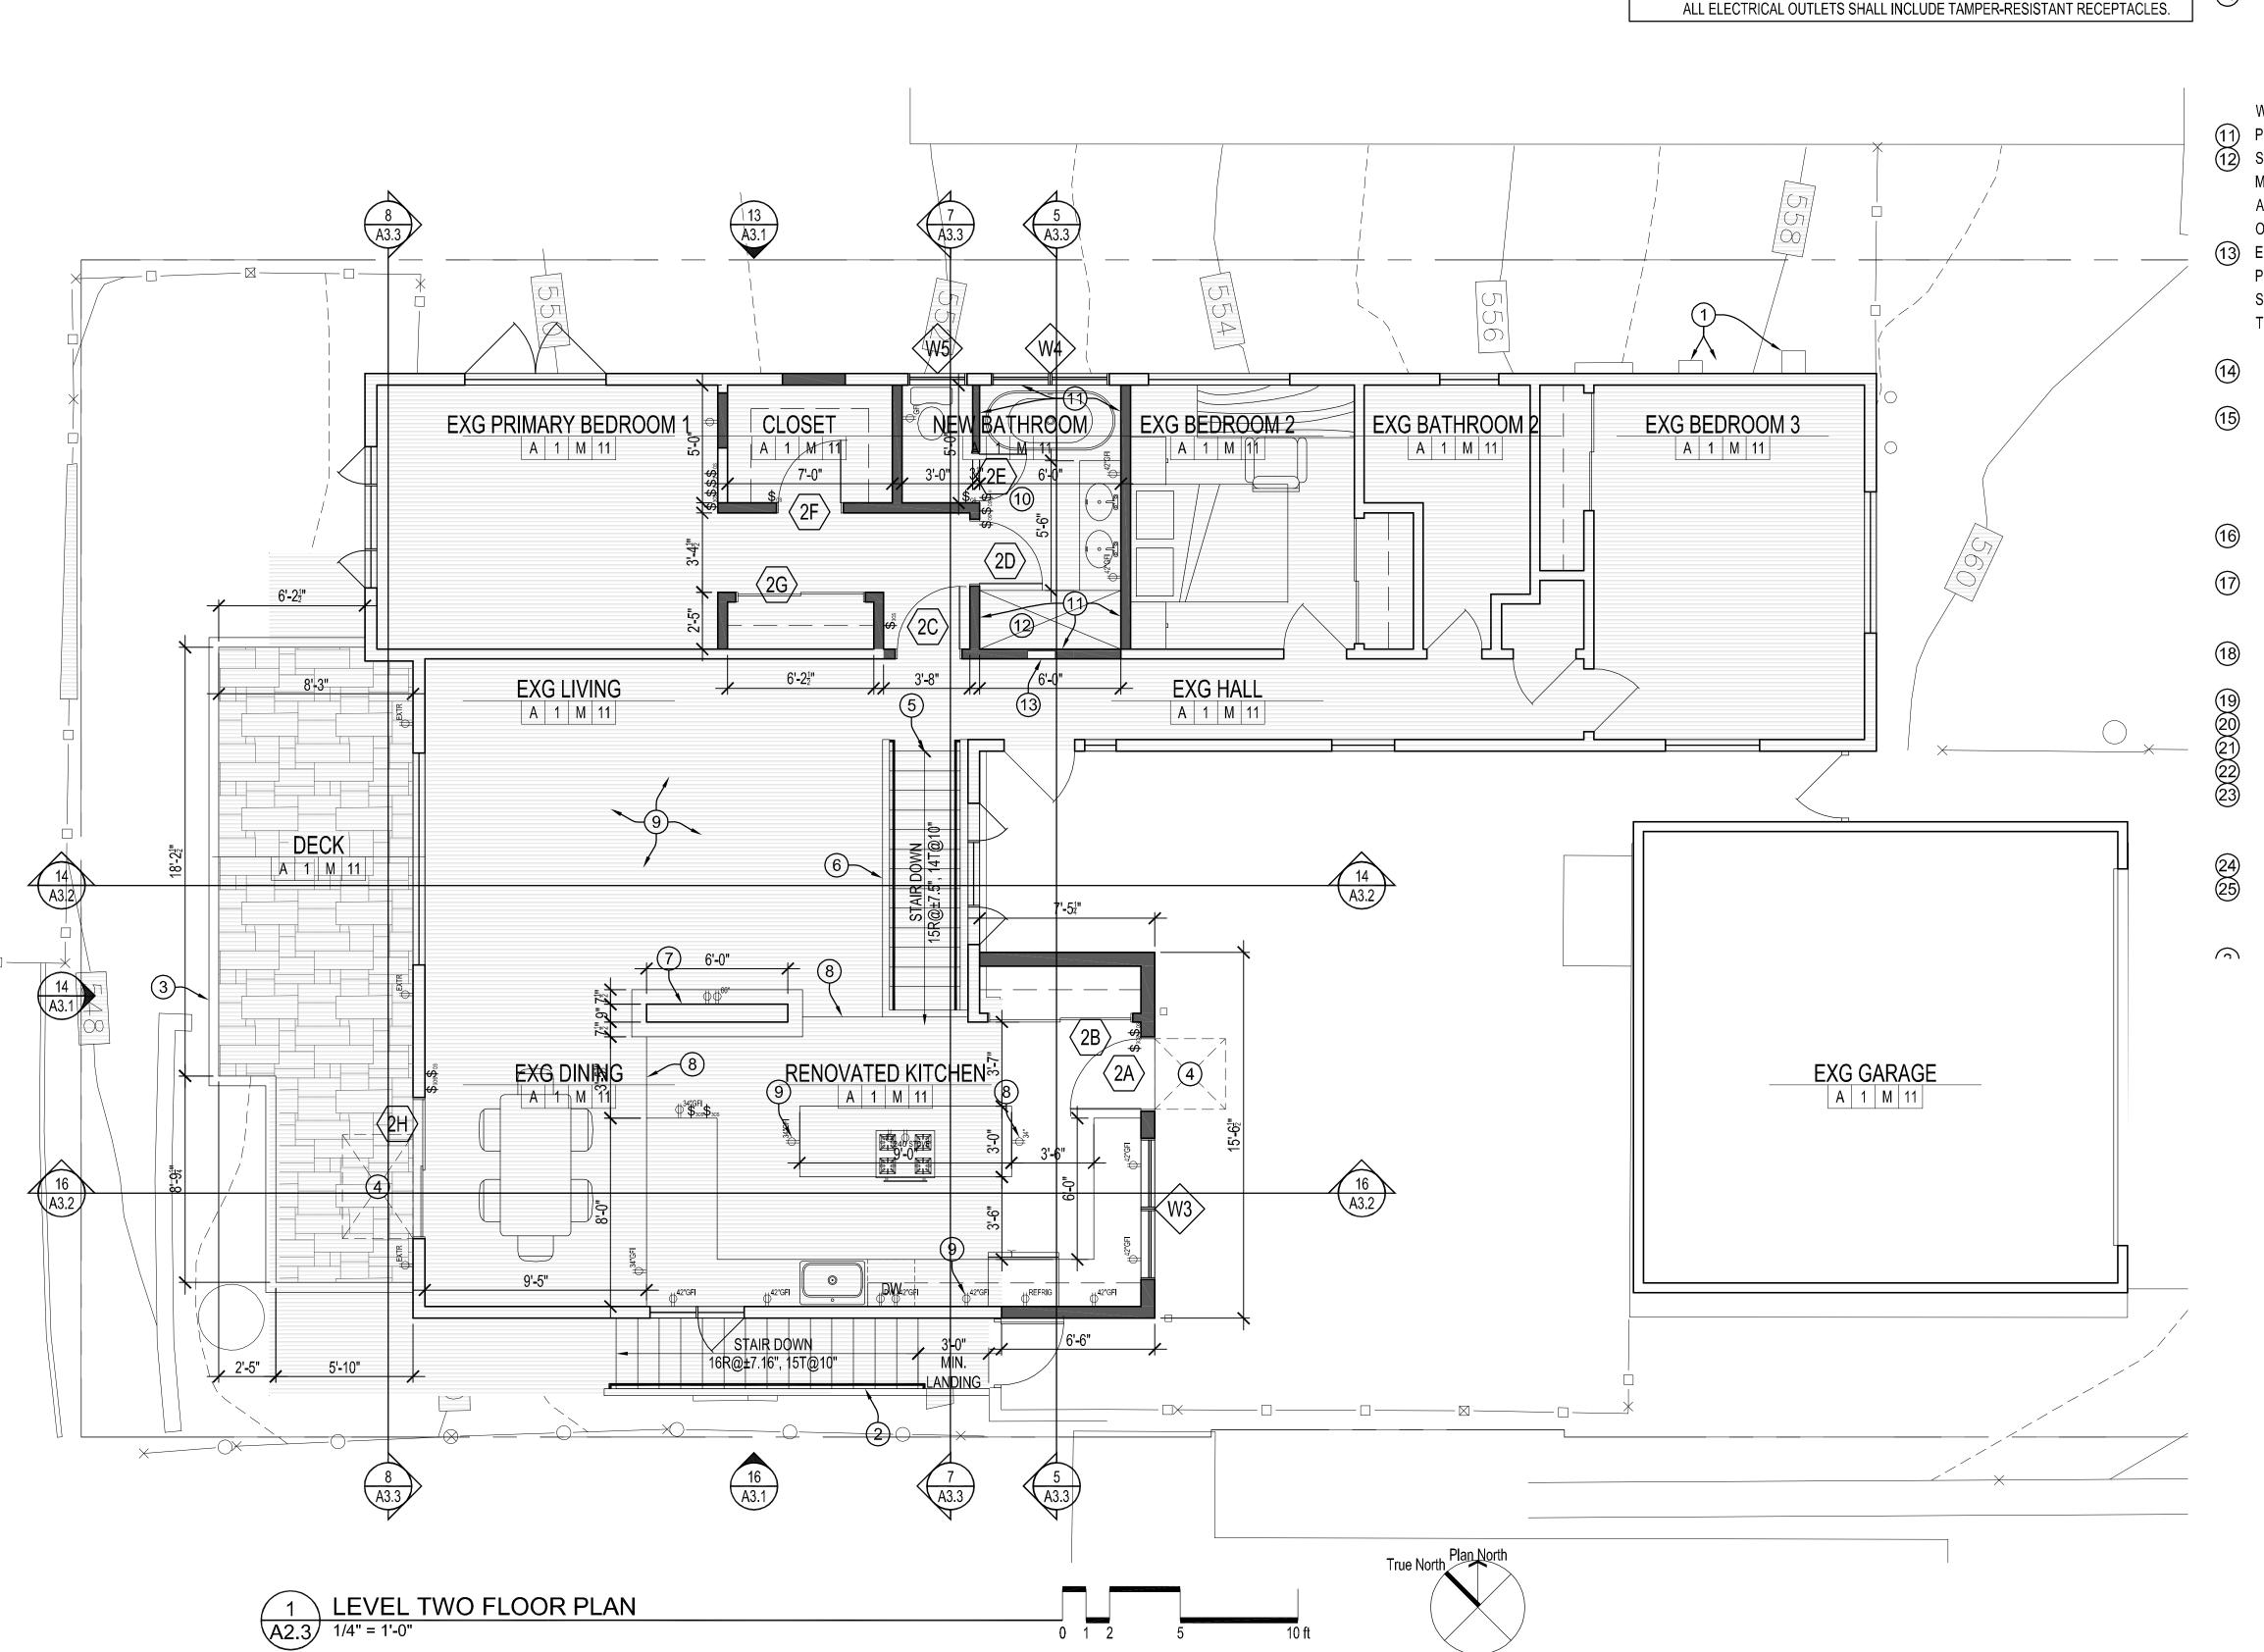
Juli and Ken Kurtzman 210 Amherst Avenue Kensington, CA 94708 APN 570-050-004

LOWER LEVEL CEILING PLAN

Date: 3 November 202 Drawn: Scale:

A2.2





LEVEL TWO PLAN NOTES

- ALL DIMENSIONS ARE TO FACE OF FINISH, UNLESS OTHERWISE NOTED.
- (1) GAS AND ELECTRIC METERS SEE SITE PLAN
- EXTERIOR STAIRS, SEE LEVEL ONE PLAN NOTE #4, SHEET A2.1
- NEW EXTERIOR DECK ±200 SF. PROVIDE WOOD GUARDRAIL, MINIMUM 3'-6" HIGH, WITH
- OPENINGS THAT DO NOT ALLOW PASSAGE OF 4" Ø SPHERE. SEE SECTION AT 12/A4.2 PROVIDE MIN. 36" DEEP LANDING AT EXTERIOR DOORS, MAX 7.75" BELOW DOOR
- \bigcirc INTERIOR STAIRS WITH MAX 7.75" RISERS, MIN. 10" TREAD. PROVIDE $1\frac{1}{2}$ "Ø WOOD HANDRAIL

THRESHOLD WHERE DOOR DOES NOT SWING OVER STEP, SLOPE MAX. 2% SLOPE.

- MIN 1 SIDE, 34" ABOVE TREAD NOSINGS, $1\frac{1}{2}$ " CLEAR FROM WALL, RETURN AT ENDS. (6) PROVIDE GUARDRAIL MIN. 34" HIGH WITH NO OPENING ALLOWING PASSAGE OF 4" Ø
- SPHERE. SEE SECTION AT 12/A4.2
- (7) NEW GAS OR ELECTRIC FIREPLACE, SEE DETAIL --/A-
- JOINT BETWEEN WOOD AND TILE OR RESILIENT FLOORING
- PROVIDE GFI ELECTRICAL OUTLETS ON COUNTER SIDE SO THAT NO COUNTER SPACE IS NO MORE THAN 2'-0" FROM AN OUTLET. PROVIDE MIN. (2) 20 AMP CIRCUITS TO COUNTERTOP OUTLETS FOR SMALL APPLIANCES, AND PROVIDE SEPARATE CIRCUIT FOR REFRIGERATOR OUTLET. PROVIDE OUTLETS AT END OF PENINSULA AND AT BOTH ENDS OF ISLAND
- (10) NEW PLUMBING FIXTURES SHALL HAVE THE FOLLOWING FLOW RATES:
 - TOILETS: EFFECTIVE FLUSH VOLUME SHALL NOT EXCEED 1.28 GALLONS SHOWERHEADS: MAX 1.8 GPM @ 80 PSI
 - LAVATORY FAUCETS: MAX 1.2 GPM @ 60 PSI (0.8 GPM AT 20 PSI MIN) KITCHEN FAUCETS: MAX 1.8 GPM @ 60 PSI
 - WRAP ALL EXPOSED HOT WATER PIPES WITH MIN. R-4 INSULATION
 - PROVIDE NONABSORBENT WALL SURFACE TO MIN. 6' ABOVE FLOOR AT TUB/ SHOWER.
- SHOWER SHALL HAVE A MIN. 1024 SQ IN OF INTERIOR AREA, AND PROVIDE SPACE FOR A MIN. 30"Ø CIRCLE. GLASS IN SHOWER ENCLOSURES SHALL BE APPROVED SAFETY GLASS, AND SHOWER DOORS, IF PROVIDED SHALL BE MIN. 24" CLEAR WIDTH AND SHALL OPEN OUTWARD FROM THE SHOWER COMPARTMENT.
- ELECTRICAL SUB-PANEL, MIN. 30" W X 36" DEEP X 78" H WORKSPACE IN FRONT. PROVIDE EGRESS/ RESCUE WINDOW AT BEDROOMS. SEE DOOR AND WINDOW SCHEDULE SHEET A2.5 FOR SPECIFIC DIMENSIONS AND REQUIREMENTS. TEMPERED SAFETY GLAZING

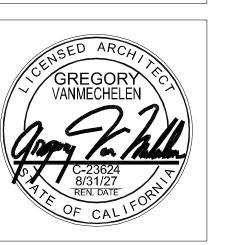
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IISSION for

UPPER LEVEL FLOOR PLAN

Revision

Drawn:

Scale:

FINISH SCHEDULE			
FLOOR	BASE	WALLS	CEILINGS
A. WOOD	1. PAINTED WOOD OR MDF	M. GYPSUM BOARD TYPE 1	11. GYPSUM BOARD
B. CERAMIC TILE	2. CERAMIC TILE	N. CEMENT BOARD OR SHOWER BACKER BOARD	12. PAINTED GYPSUM BOARD
C. CONCRETE	3. RUBBER	O. MIN. ½" GYPSUM BOARD WITH TAPE AND MUD	13. MIN. 5/8 " GYPSUM BOARD WITH TAPE AND MUD

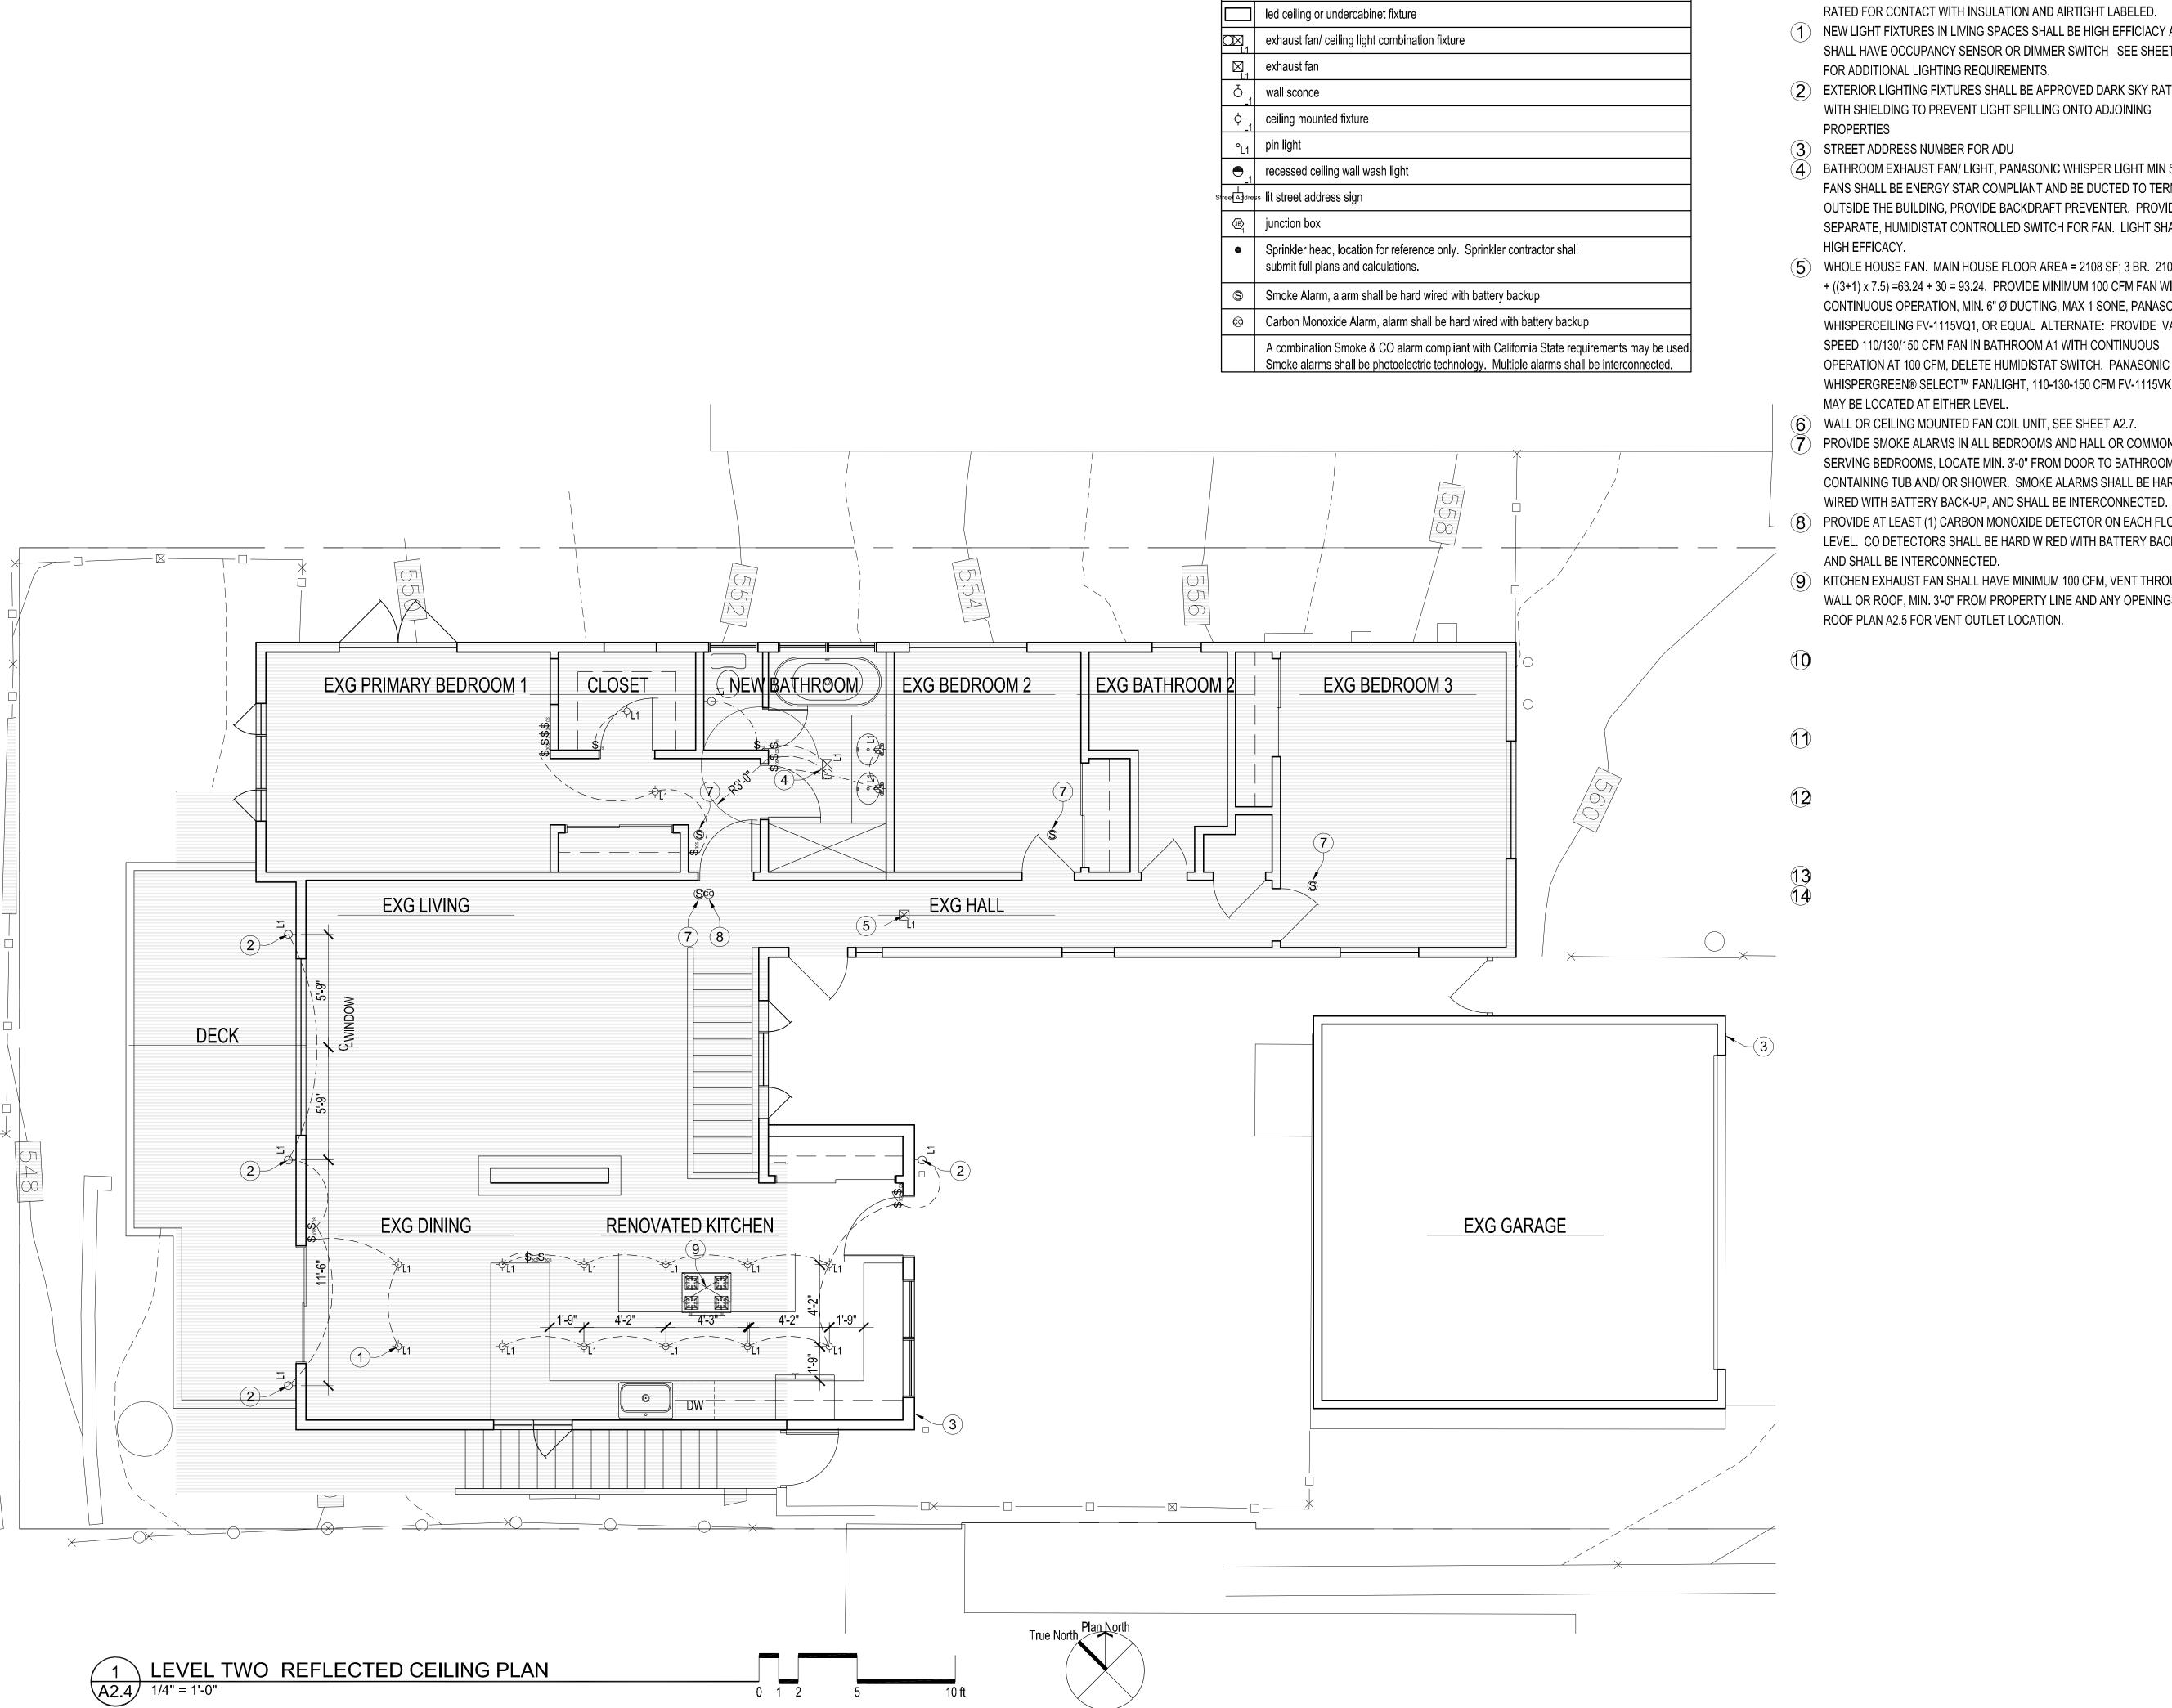
EXISTING WALL REMOVED

A2.3

6 of 10 Sheets

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WALL LEGEND



LIGHTING FIXTURE SYMBOLS

LEVEL TWO REFLECTED CEILING PLAN NOTES

ALL RECESSED CEILING FIXTURES IN INSULATED CEILINGS SHALL BE IC

- 1 NEW LIGHT FIXTURES IN LIVING SPACES SHALL BE HIGH EFFICIACY AND SHALL HAVE OCCUPANCY SENSOR OR DIMMER SWITCH SEE SHEET T24-3 FOR ADDITIONAL LIGHTING REQUIREMENTS.
- 2 EXTERIOR LIGHTING FIXTURES SHALL BE APPROVED DARK SKY RATED, WITH SHIELDING TO PREVENT LIGHT SPILLING ONTO ADJOINING
- 3 STREET ADDRESS NUMBER FOR ADU
- **4** BATHROOM EXHAUST FAN/ LIGHT, PANASONIC WHISPER LIGHT MIN 50 CFM. FANS SHALL BE ENERGY STAR COMPLIANT AND BE DUCTED TO TERMINATE OUTSIDE THE BUILDING, PROVIDE BACKDRAFT PREVENTER. PROVIDE SEPARATE, HUMIDISTAT CONTROLLED SWITCH FOR FAN. LIGHT SHALL BE HIGH EFFICACY.
- (5) WHOLE HOUSE FAN. MAIN HOUSE FLOOR AREA = 2108 SF; 3 BR. 2108 X 0.03 $+((3+1) \times 7.5) = 63.24 + 30 = 93.24$. PROVIDE MINIMUM 100 CFM FAN WITH CONTINUOUS OPERATION, MIN. 6" Ø DUCTING, MAX 1 SONE, PANASONIC WHISPERCEILING FV-1115VQ1, OR EQUAL ALTERNATE: PROVIDE VARIABLE SPEED 110/130/150 CFM FAN IN BATHROOM A1 WITH CONTINUOUS OPERATION AT 100 CFM, DELETE HUMIDISTAT SWITCH. PANASONIC WHISPERGREEN® SELECT™ FAN/LIGHT, 110-130-150 CFM FV-1115VKL2. FAN MAY BE LOCATED AT EITHER LEVEL.
- (6) WALL OR CEILING MOUNTED FAN COIL UNIT, SEE SHEET A2.7. PROVIDE SMOKE ALARMS IN ALL BEDROOMS AND HALL OR COMMON SPACE SERVING BEDROOMS, LOCATE MIN. 3'-0" FROM DOOR TO BATHROOMS CONTAINING TUB AND/ OR SHOWER. SMOKE ALARMS SHALL BE HARD
- (8) PROVIDE AT LEAST (1) CARBON MONOXIDE DETECTOR ON EACH FLOOR LEVEL. CO DETECTORS SHALL BE HARD WIRED WITH BATTERY BACK-UP, AND SHALL BE INTERCONNECTED.
- (9) KITCHEN EXHAUST FAN SHALL HAVE MINIMUM 100 CFM, VENT THROUGH WALL OR ROOF, MIN. 3'-0" FROM PROPERTY LINE AND ANY OPENINGS. SEE ROOF PLAN A2.5 FOR VENT OUTLET LOCATION.

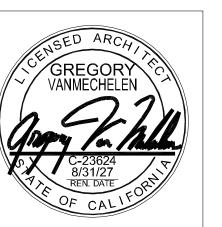
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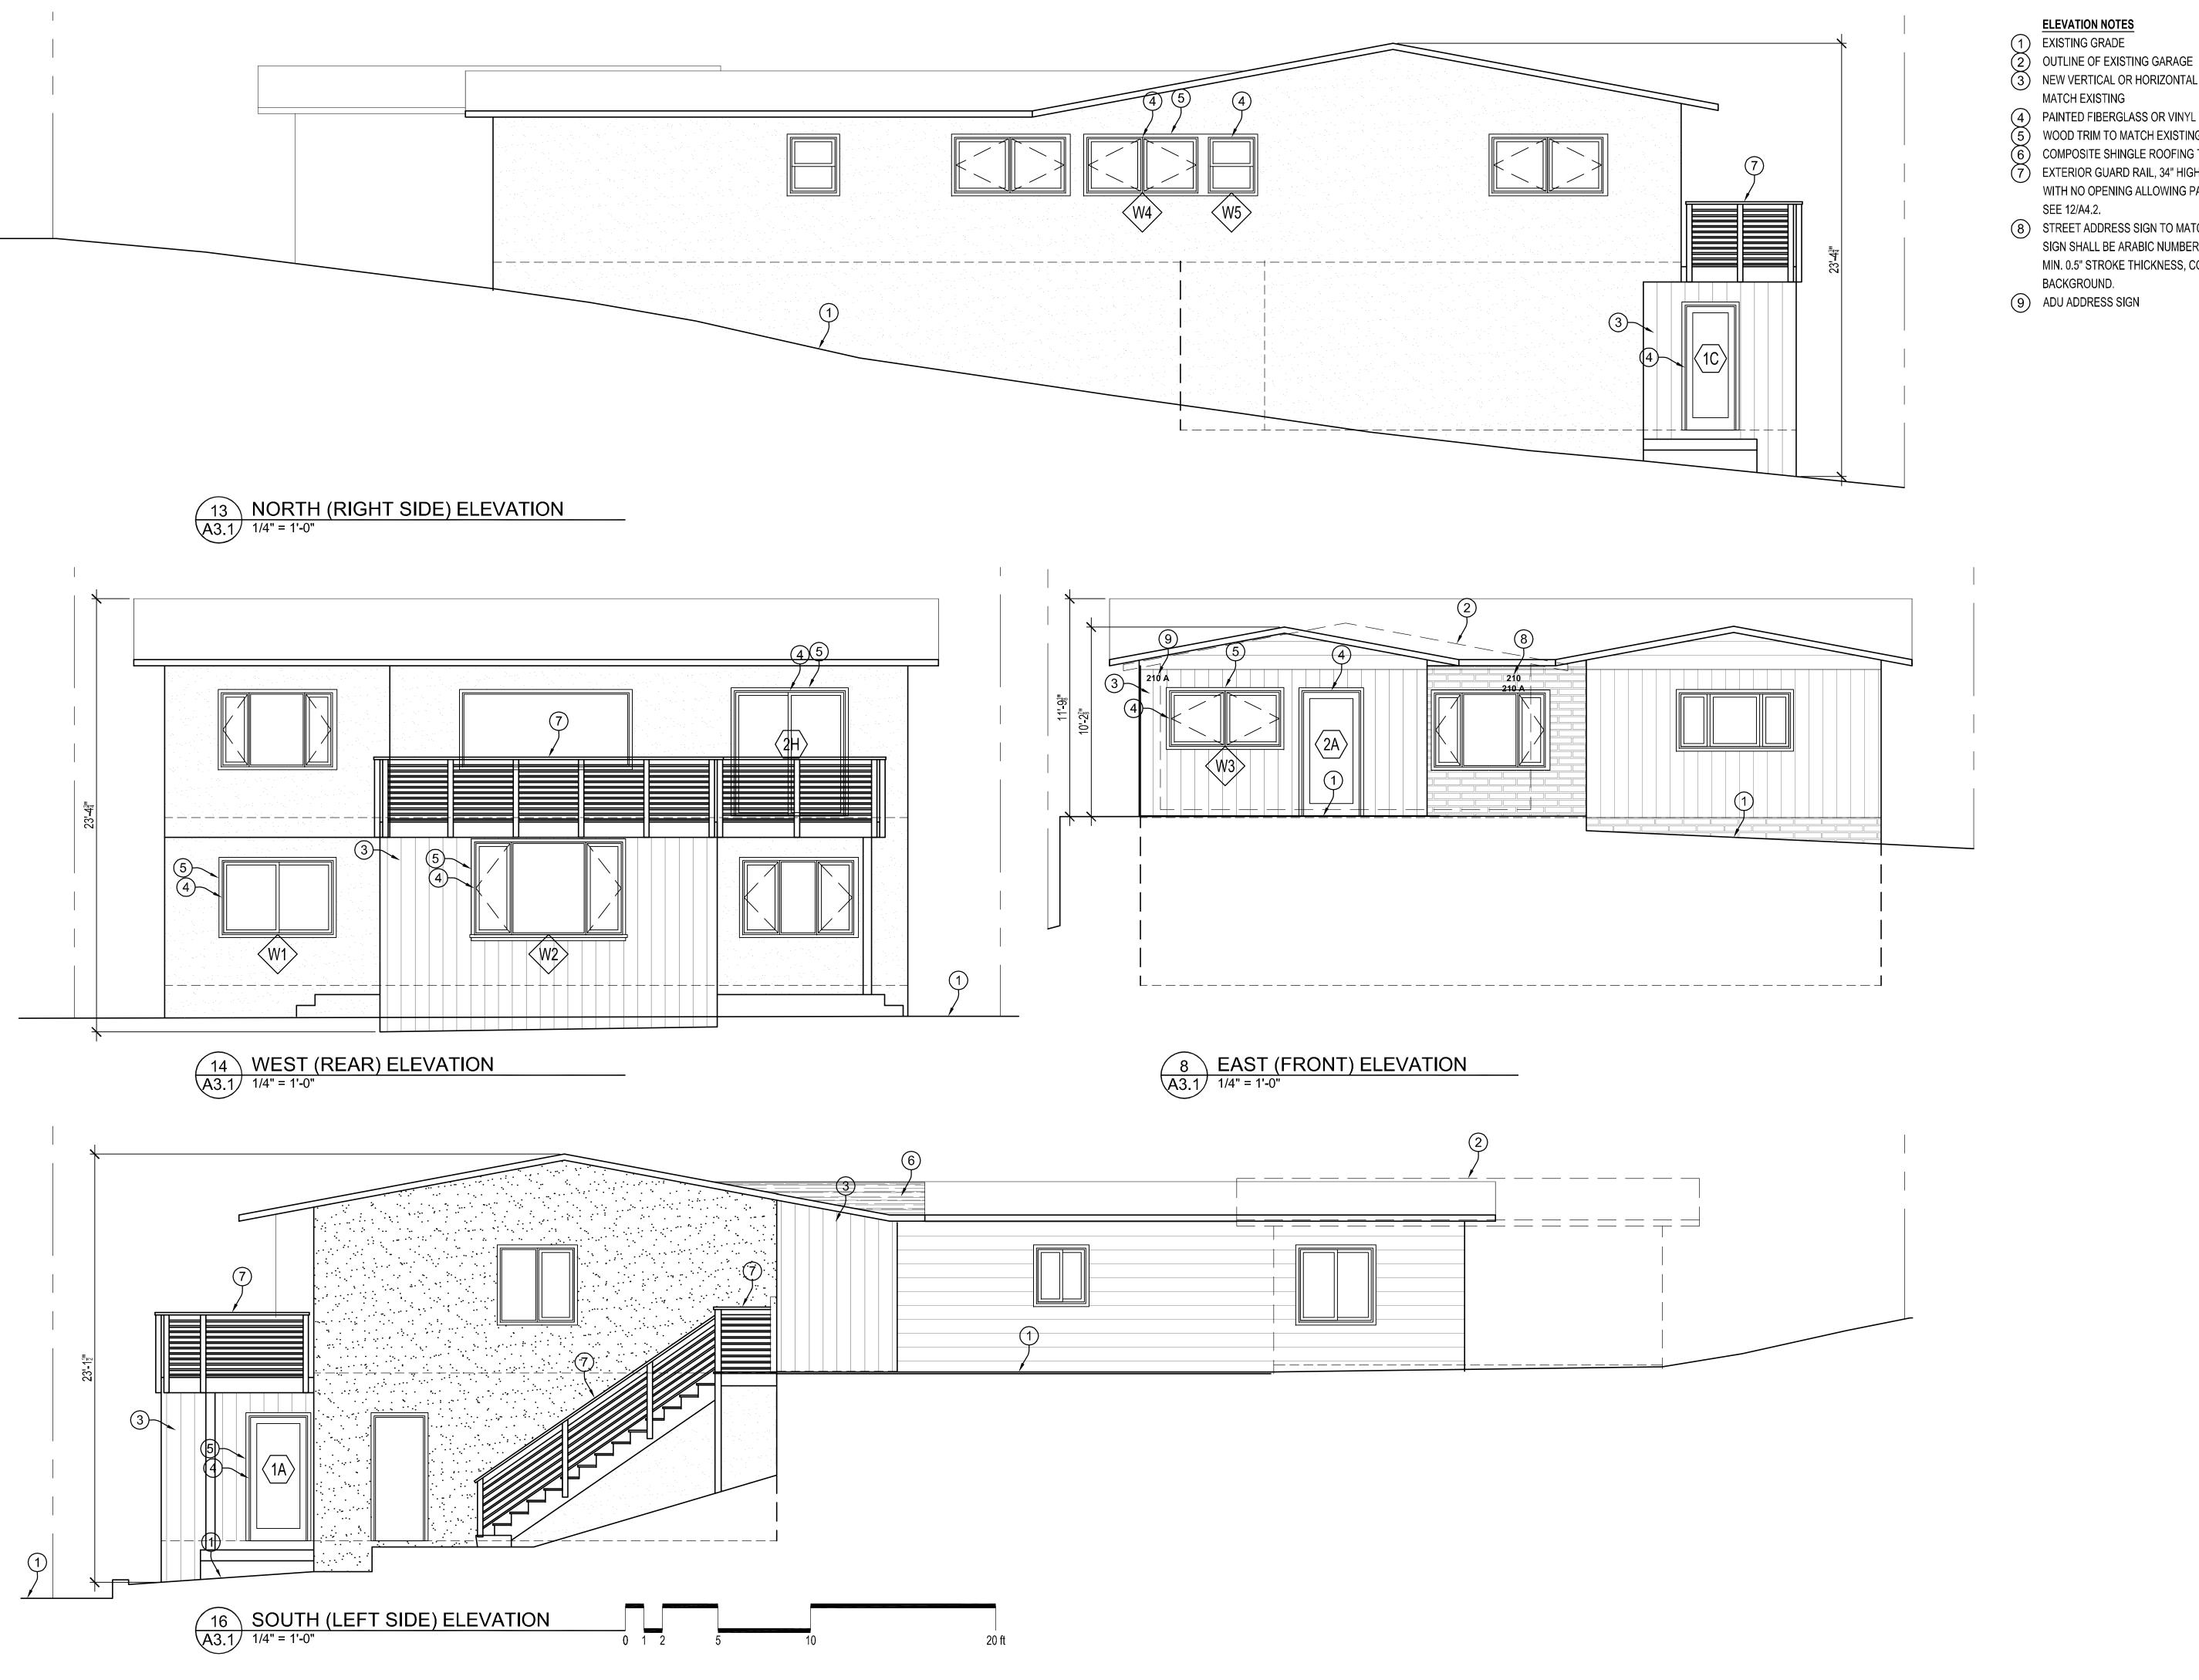
Sprinkler and Fire Alarm



IISSION

UPPER LEVEL CEILING PLAN

Revision Drawn:



ELEVATION NOTES

3 NEW VERTICAL OR HORIZONTAL FIBER CEMENT SIDING TO

(4) PAINTED FIBERGLASS OR VINYL WINDOWS AND DOORS, TYP.

(5) WOOD TRIM TO MATCH EXISTING, TYPICAL. 6 COMPOSITE SHINGLE ROOFING TO MATCH EXISTING

(7) EXTERIOR GUARD RAIL, 34" HIGH AT STAIRS, 42" AT DECKS WITH NO OPENING ALLOWING PASSAGE OF 4" Ø SPHERE,

8 STREET ADDRESS SIGN TO MATCH EXISTING ON GARAGE -SIGN SHALL BE ARABIC NUMBERS MIN. 4" IN HEIGHT WITH MIN. 0.5" STROKE THICKNESS, COLOR TO CONTRAST

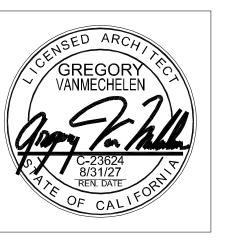
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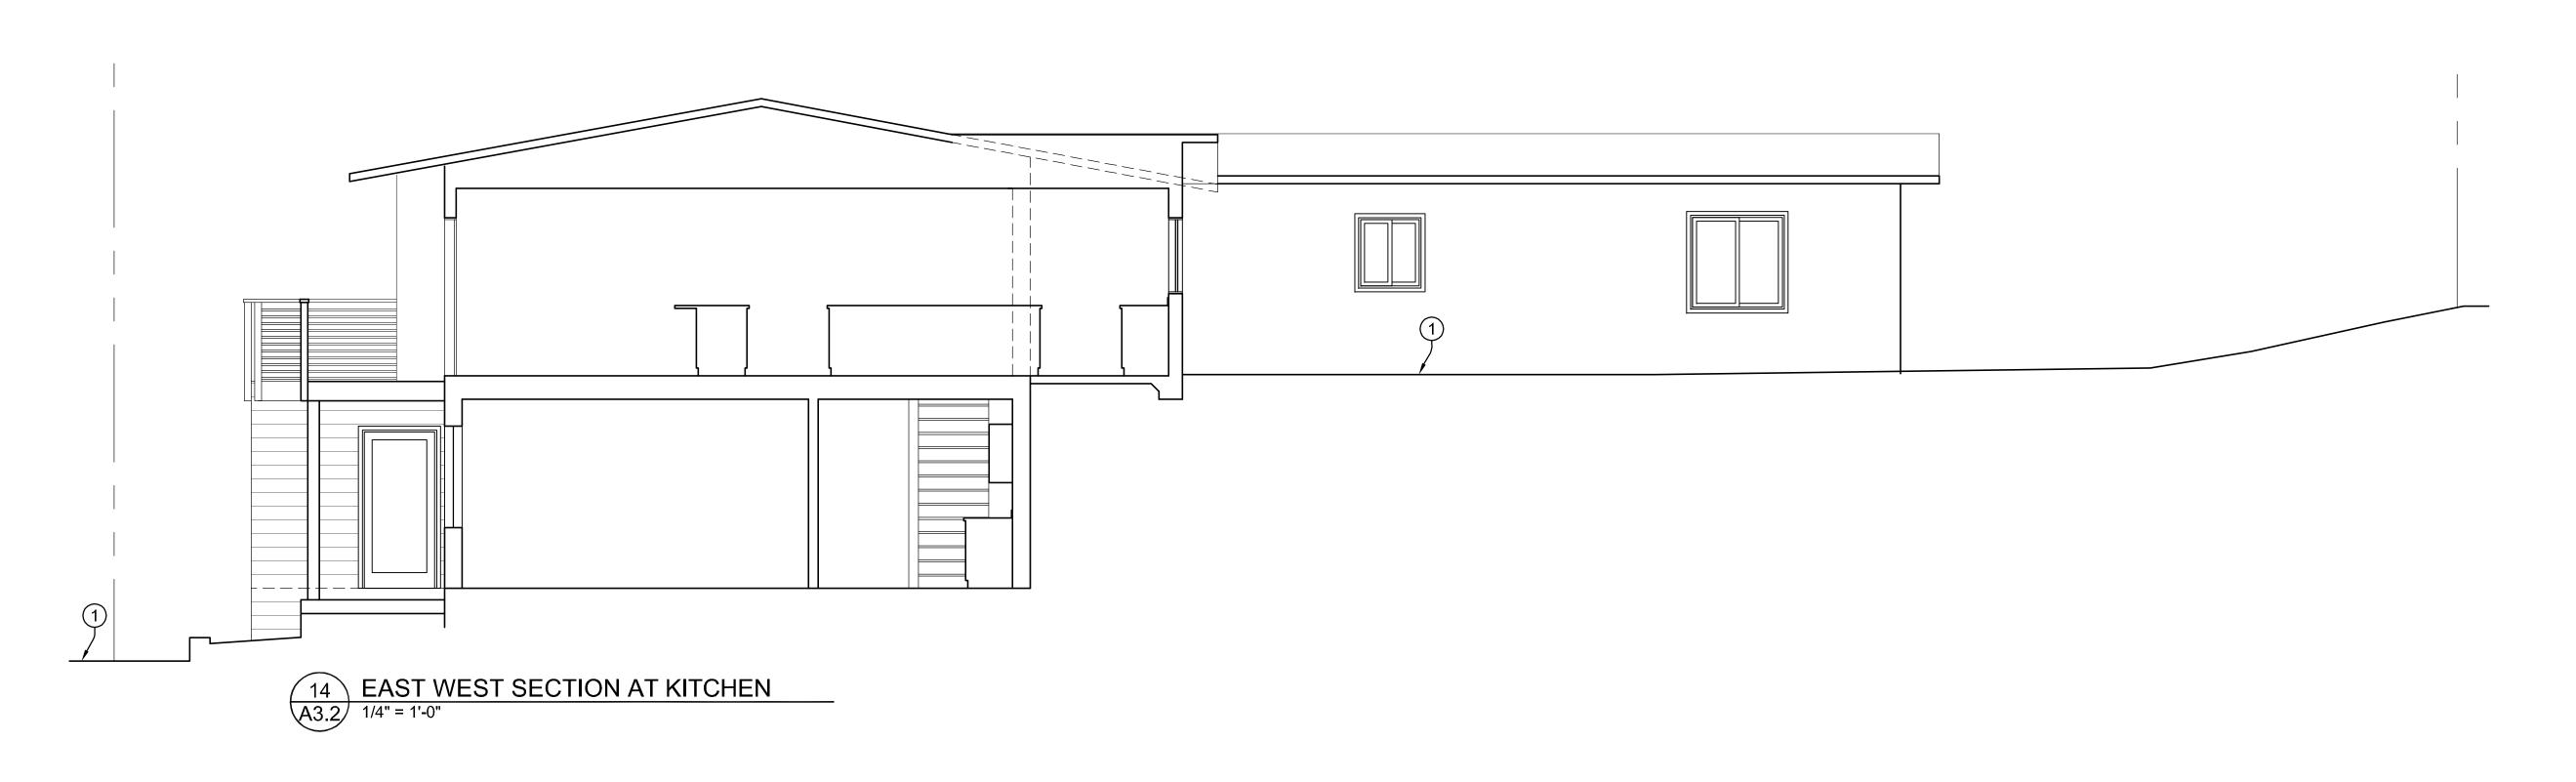
Sprinkler and Fire Alarm

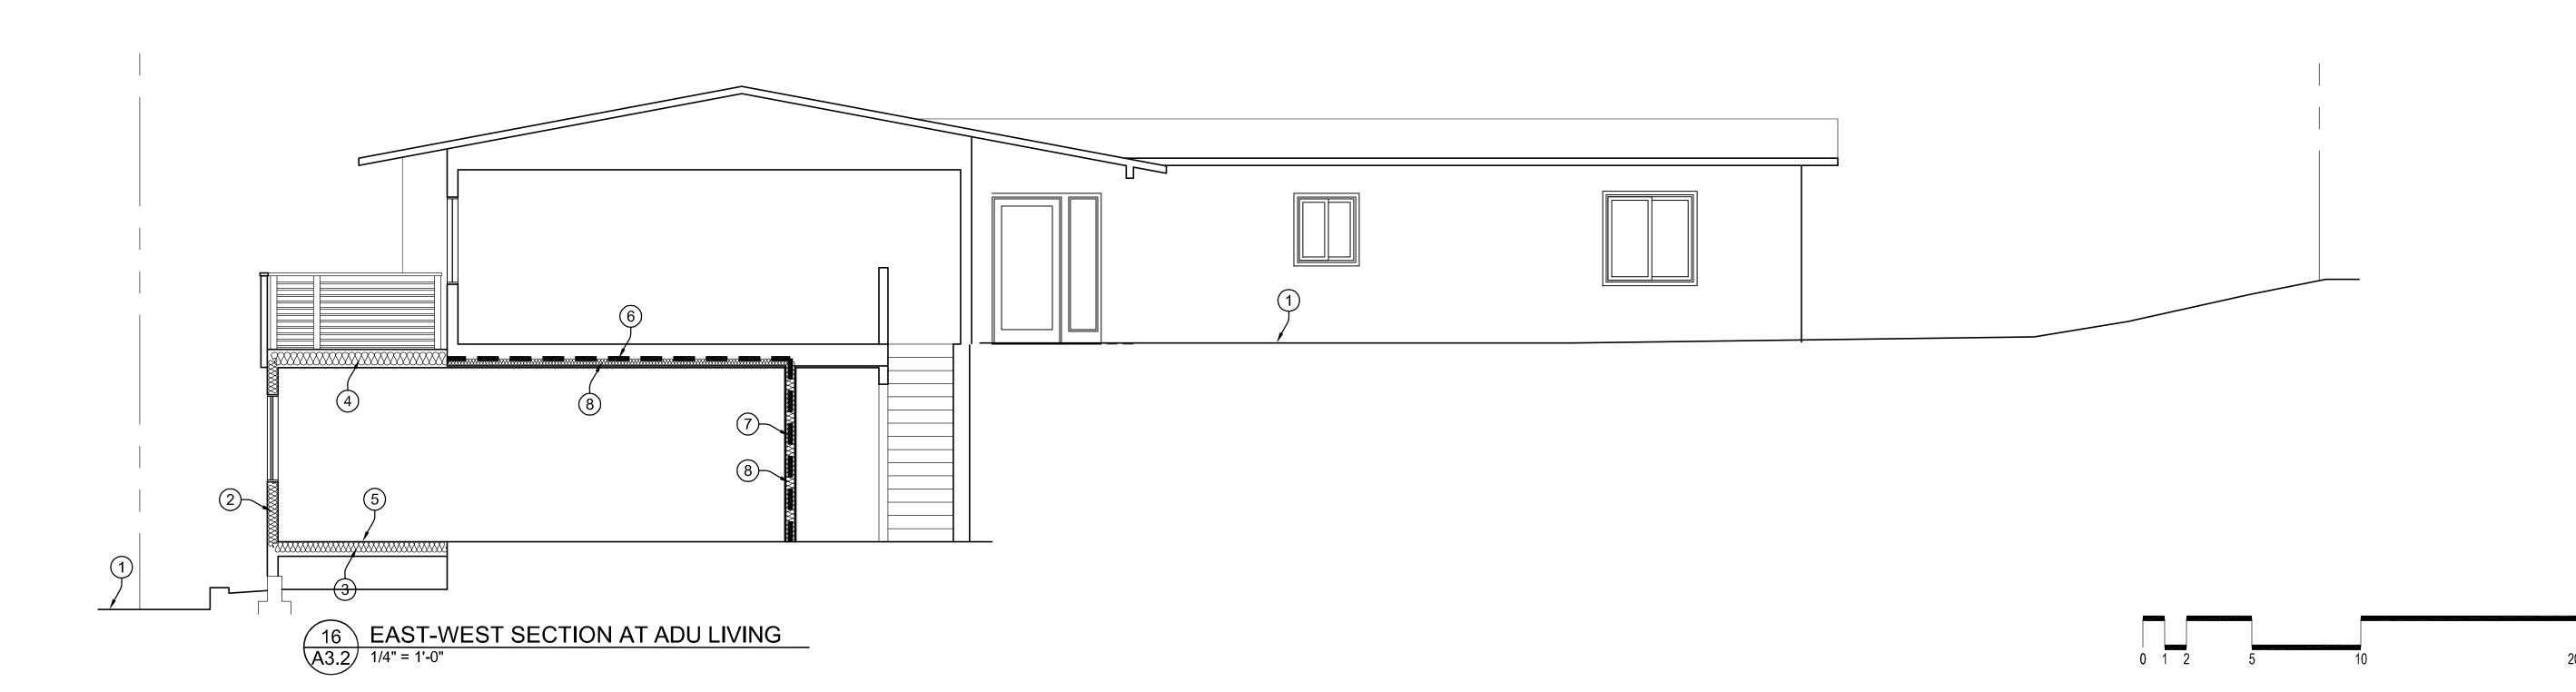


EXTERIOR ELEVATIONS

Revisio	n
1.	•
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△.	•
Date:	3 November 2025
Drawn:	
Scale:	

A3.1





SECTION NOTES

(1) EXISTING GRADE

2) PROVIDE R-15 IN EXTERIOR WALLS

PROVIDE R-21 INSULATION IN RAISED FLOORS AND SPACES
ABOVE UNCONDITIONED LOCATIONS.

4 PROVIDE MIN R-30 ROOF INSULATION

PROVIDE MIN R-30 ROOF INSULATION

RAISED FLOOR AT ADU EXPANSION, EXCAVATE AS REQUIRED

FOR 18" HIGH CRAWL SPACE. ALTERNATE: PROVIDE 4" MIN.

SLAB ON GRADE WITH PERIMETER FOOTING. PROVIDE 4"

RIGID INSULATION BELOW THE SLAB, THOUGH THIS NOT REQUIRED.

6 1 HOUR FIRE RATED FLOOR CEILING, SEE DETAIL 1/A4.2

1 HOUR FIRE RATED WALL, SEE DETAIL 2/A4.2

PROVIDE MIN 3.5" INSULATION FOR ACOUSTIC SEPARATION BETWEEN DWELLING UNITS. SEE DETAIL 1/A4.2.

9 ATTIC ACCESS DOOR/ LADDER, MIN. 22" X 30" FOR ANY ATTIC WITH A CLEAR HEIGHT OF 2'-6" FOR AN AREA >30 SF.

SEE ROOF PLAN NOTES SHEET A2.4 FOR ATTIC VENTILATION.
 PROVIDE MIN. 5" GYP BOARD AT ACCESSIBLE AREAS

UNDERNEATH STAIRS

12

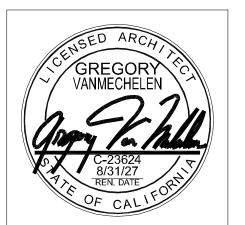
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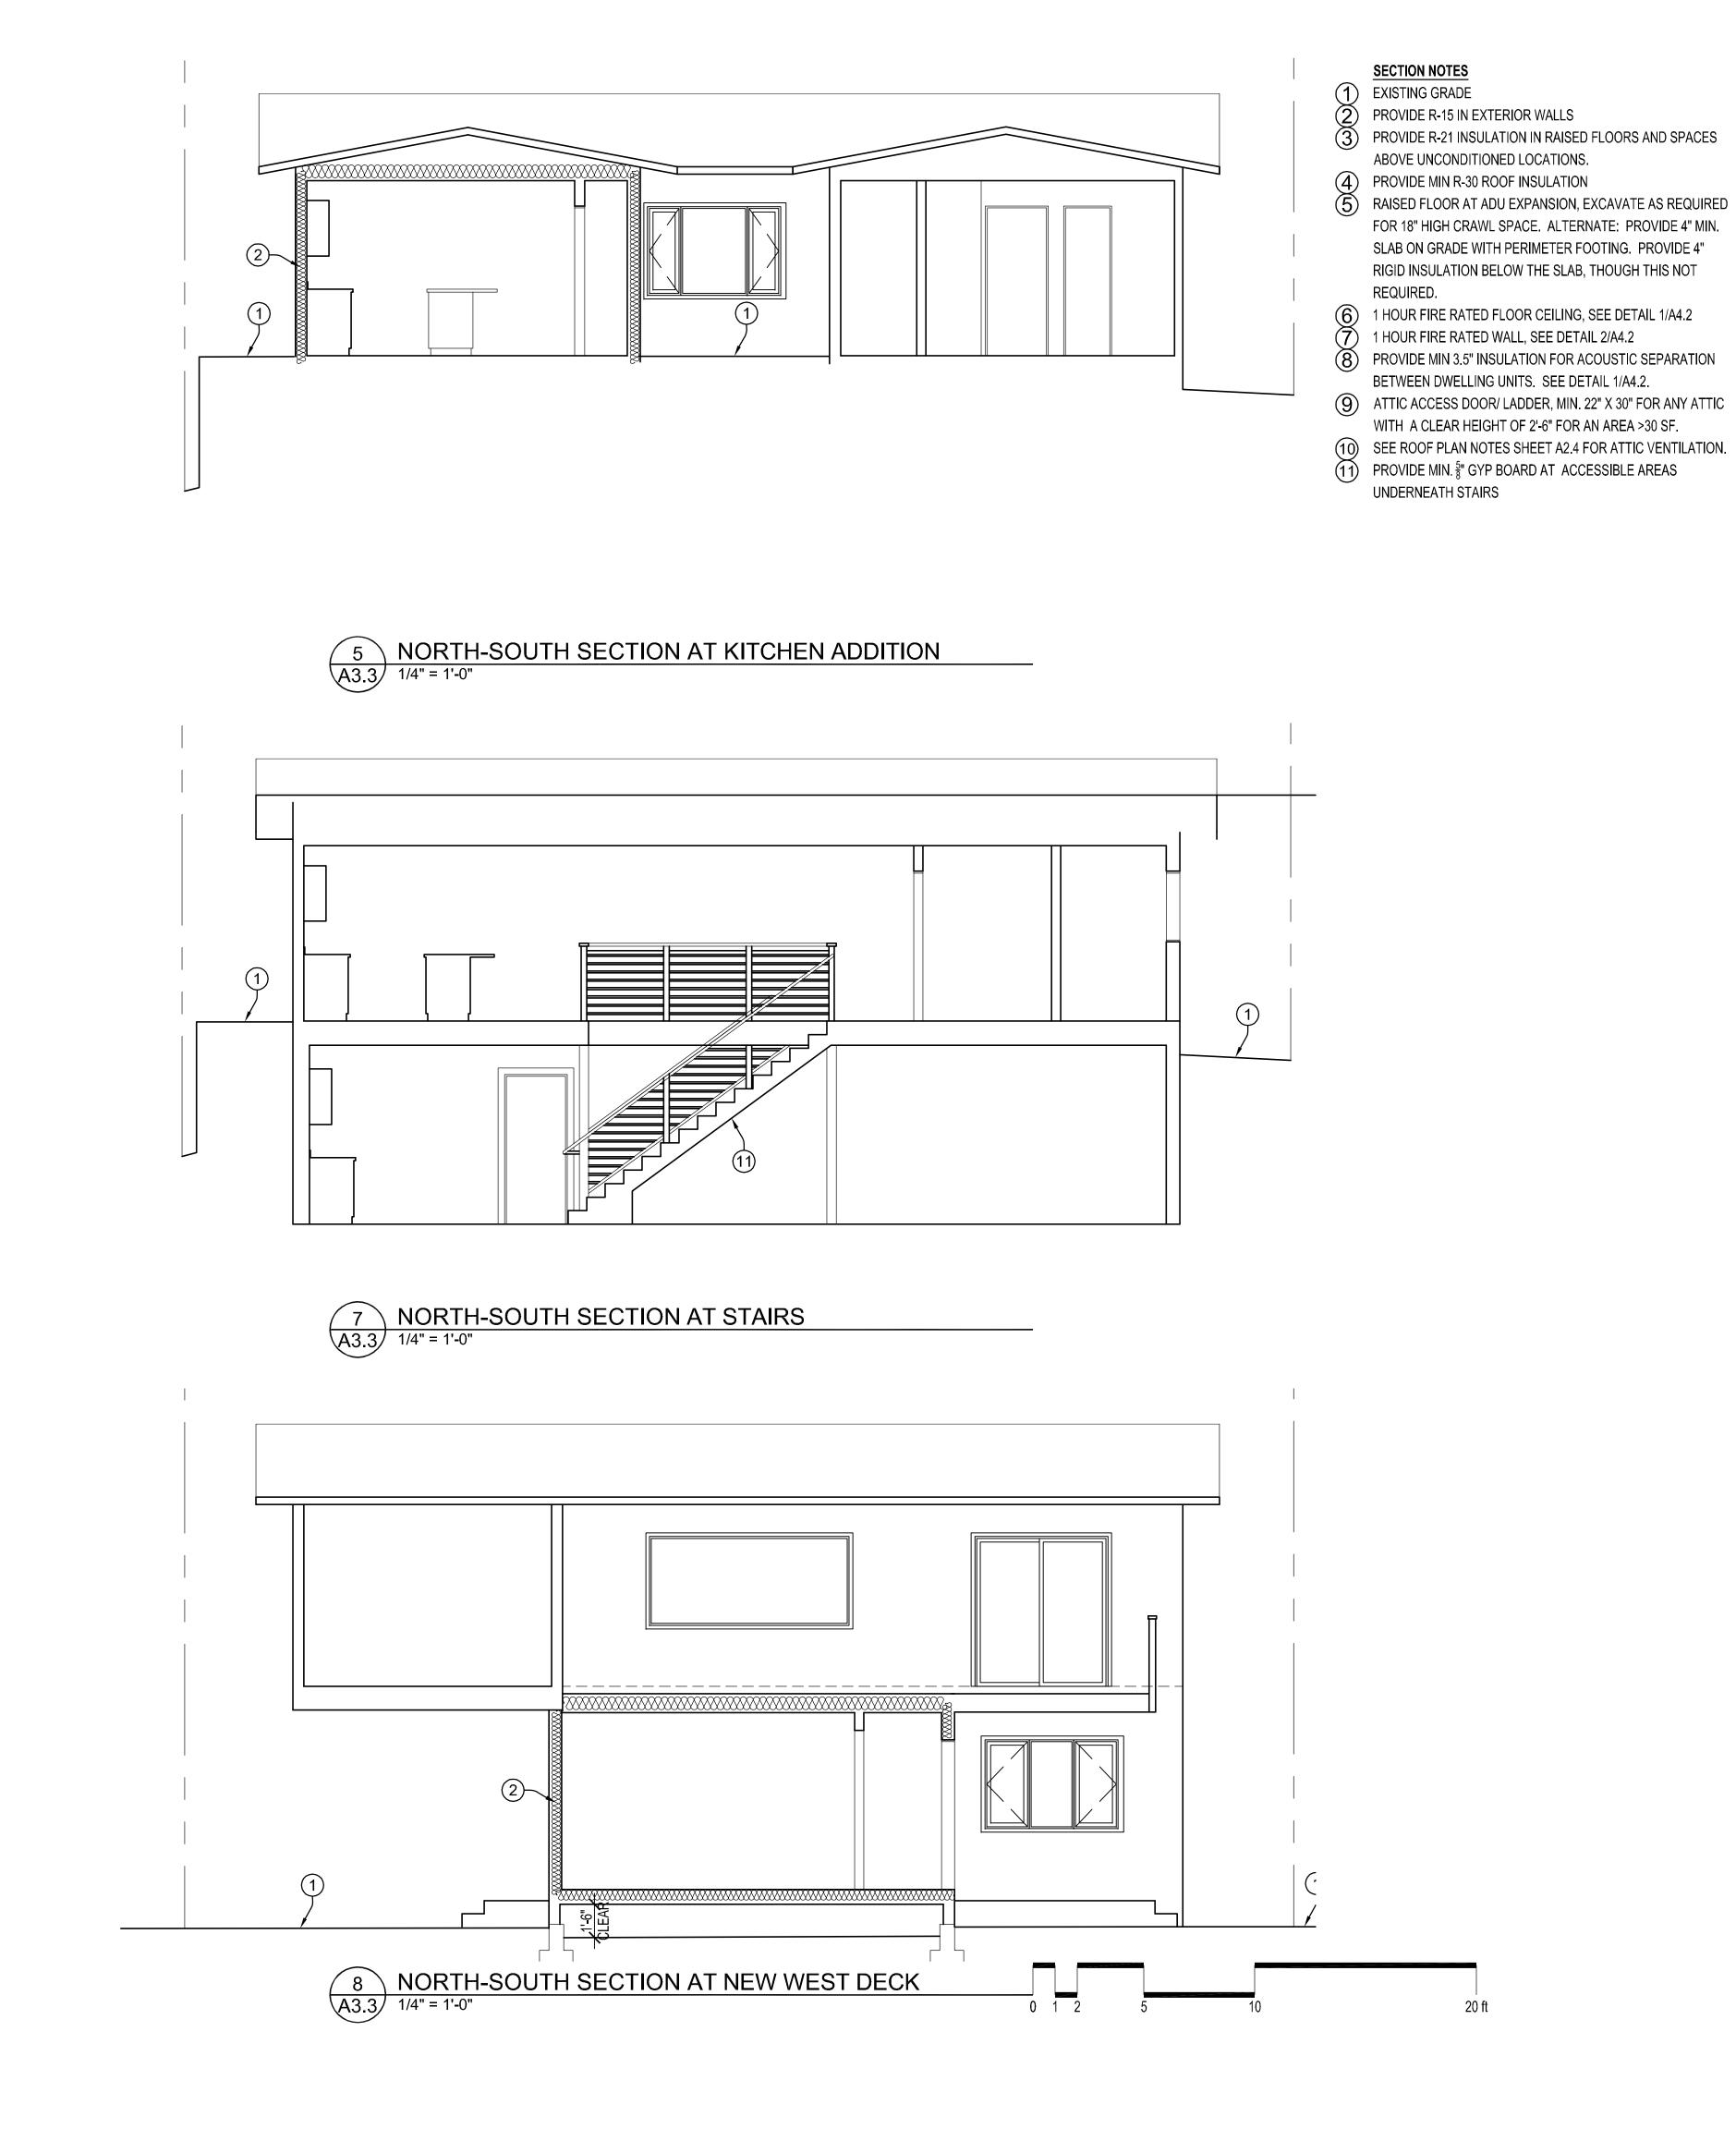
Sprinkler and Fire Alarm



PLANNING SUBMISSION
Residential Renovations for:
Juli and Ken Kurtzman
210 Amherst Avenue
Kensington, CA 94708
APN 570-050-004

BUILDING SECTIONS

A3.2



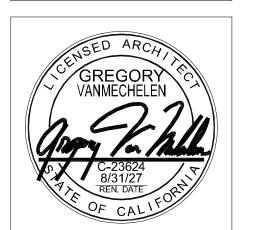
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IISSION for:

BUILDING SECTIONS

Revision Date: 3 November 2025

Drawn:

A3.3