

CONTRA COSTA COUNTY

AGENDA

El Sobrante Municipal Advisory Council

Wednesday, October 8, 2025

7:00 PM

El Sobrante Library (4300 Garden Rd. El Sobrante), Zoom: https://cccounty-us.zoom.us/j/875691450

41

Thomas Lang (Chair), George Cleveland (Vice-Chair), Tom Owens, Dr. Melinda V. Mclain, Jim Hermann, Randy Loyd, Mikki Norris, Teri Edlinger, Jedd Hart

Agenda Items: Items may be taken out of order based on the business of the day and preference of the Committee

- 1. Roll Call and Introductions
- 2. Treasurer's Report
- 3. Approval of Minutes

APPROVE the September 10, 2025 esMAC Minutes

25-4041

Attachments: 9.10.25 esMAC Minutes

- 4. Presentations
- P.1. County Update, Supervisor John Gioia
- P.2. Sheriff's Office Bay Station Update, Lt. Fitzgerald
- P.3. Contra Costa County Fire Protection District Update, Michelle Rinehart
- P.4. California Highway Patrol (tentative)
- P.5 San Pablo Dam Road Safety Improvements, Contra Costa County Traffic Engineering
- P.6 Center for Elders' Independence-West County PACE Healthcare Center, Uche Uwahemu
- 5. Discussion Items: DI. Development plan applications, variance reports, building modification requests, appeals etc., received in the previous month from the Contra Costa County Conservation and Development Department and Notices of Public Hearing

DI.1 - (Update) Countywide Noise Ordinance

D.I.2 - County File Number: CDVR25-01044 (41 HELTSLEY PL, EL SOBRANTE, CA 94803) The applicant requests approval of a variance to allow a 12-foot secondary front setback (where 15 feet is the minimum required) to replace an existing deck.

County File Number: CDVR25-01044

25-4039

Attachments: CDVR25-01044 Agency Comment Packet

- 6. Public comment on any item under the jurisdiction of the Council and not on this agenda (speakers may be limited to two minutes).
- 7. Information Items
- 8. Subcommittee Reports Next Clean Up, October 18, 2025
- 9. Agenda Items / Speakers for Upcoming ESMAC Meetings

The next meeting is currently scheduled for November 12

Adjourn

The Council will provide reasonable accommodations for persons with disabilities planning to attend the Council meetings. Contact the staff person listed below at least 72 hours before the meeting. Any disclosable public records related to an open session item on a regular meeting agenda and distributed by the County to a majority of members of the Council less than 96 hours prior to that meeting are available for public inspection at El Sobrante Library (4191 Appian Way, El Sobrante, CA 94803) during normal business hours. Staff reports related to items on the agenda are also accessible online at www.contracosta.ca.gov. If the Zoom connection malfunctions for any reason, the meeting may be paused while a fix is attempted. If the connection is not reestablished, the Council will continue the meeting in person without remote access. Public comment may be submitted via electronic mail on agenda items at least one full work day prior to the published meeting time.

For Additional Information Contact: Ronnie Mills, ronnie.mills@bos.cccounty.us, 510-942-2222



CONTRA COSTA COUNTY

1025 ESCOBAR STREET MARTINEZ, CA 94553

Staff Report

File #: 25-4041 **Agenda Date**: 10/8/2025 **Agenda #**:

Advisory Board: El Sobrante Municipal Advisory Council Subject: approve the September 10, 2025 esMAC Minutes

Information: approve the September 10, 2025 esMAC Minutes

SEAL OF THE SEAL O

Meeting Minutes

CONTRA COSTA COUNTY El Sobrante Municipal Advisory Council

Wednesday, September 10, 2025

7:00 PM

El Sobrante Library (4300 Garden Rd. El Sobrante)

Thomas Lang (Chair), George Cleveland (Vice-Chair), Tom Owens, Dr. Melinda V. Mclain, Jim Hermann, Randy Loyd, Mikki Norris, Teri Edlinger, Jedd Hart

Agenda Items: Items may be taken out of order based on the business of the day and preference of the Committee

1. Roll Call and Introductions

00:00:32

Present George Cleveland, Teri Edlinger, Jedd Hart, Thomas Lang, Randy

Loyd, Mikki Norris, and Tom Owens

Absent James Hermann
Late Melinda McLain

2. Treasurer's Report

00:01:07

The Treasurer's Report was presented, showing a current balance of \$3,000.

3. Approval of Minutes

25-3508

Attachments: 8.13.25 esMAC Minutes

00:02:01

The minutes from the previous meeting were reviewed and approved.

This Discussion Item was approved.

Motion: Cleveland Second: Lovd

Aye: Cleveland, Edlinger, Lang, Loyd, Norris, and Owens

Absent: Hermann
Late: McLain
Result: Passed

4. Presentations

00:03:10

P.1. County Update, Supervisor John Gioia

00:09:26

Supervisor Gioia presented a comprehensive update on Contra Costa County's immigrant protection efforts, highlighting the County's commitment to immigrant rights and public health. He shared information about recent settlements, including \$20 million dedicated to air quality improvements and \$16 million allocated for broader initiatives.

Concerns were raised about the impact of proposed federal budget cuts on programs such as Head Start and Section 8 rental assistance, with an estimated 70,000 residents potentially losing healthcare. Supervisor Gioia also provided updates on the County's policies regarding cooperation with ICE, emphasizing a commitment to non-cooperation. The Council expressed strong support for the Supervisor's efforts and discussed the importance of additional measures, including legislative advocacy, business training, and community education.

Supervisor Gioia outlined current and upcoming homelessness response strategies, including the expansion of shelter beds and modular housing units in North Richmond. The County has also invested in constructing a 45-bed mental health rehabilitation center to address gaps in care. He emphasized a focus on transitional and permanent housing models as long-term solutions to reduce homelessness and encampments.

P.2. Sheriff's Office Bay Station Update, Lt. Fitzgerald

00:04:09

Lieutenant Fitzgerald of the Contra Costa County Sheriff's Office provided an update on public safety. For the month of August, there were 676 service calls, including incidents involving theft, domestic violence, and other serious crimes. The Council briefly discussed differences between petty and grand theft and touched on issues involving uninsured food vendors and code enforcement challenges. Lieutenant Fitzgerald also noted ongoing difficulties with vendors who were cited for violations and became aggressive toward county staff.

P.3. Contra Costa County Fire Protection District Update, Michelle Rinehart

00:41:17

Michelle Reinhart from the Contra Costa County Fire Protection District shared information on upcoming events, including an open house and pancake breakfast. She also provided an update on the East Richmond Heights shaded fuel break project, which includes prescribed burning, mechanical, and manual treatments. Michelle stressed the importance of resident participation in maintaining fuel break zones and preparing for evacuation routes.

P.4. California Highway Patrol (tentative)

P.5 Re-introduction Presentation, Contra Costa County Public Works, Monish Sen

5. Discussion Items: DI. Development plan applications, variance reports, building modification requests, appeals etc., received in the previous month from the Contra Costa County Conservation and Development Department and Notices of Public Hearing

DI.1 - County File Number: CDLP25-02031 (435 VALLEY VIEW RD, EL SOBRANTE, CA 94803) The applicant requests approval of a land use permit to allow for the renewal of an existing T-Mobile Wireless telecommunications facility previously approved under the currently valid (County File CDLP15-

02052 expires: 4/1/2026). No modifications or changes are proposed with this application.

01:03:12

25-3509

Attachments: CDLP25-02031 ACR

DI.2 - (Update) Countywide Noise Ordinance

01:05:46

Ronnie Mills shared that Grant Farrington spoke with the Director of the Department of Conservation and Development at the beginning of the month. According to the update, the department is working on a proposed plan that is expected to be brought before the Board of Supervisors in the coming months, with a tentative timeline targeting October. While the update was brief, it confirmed that progress is ongoing and the process is moving forward.

DI.3 - MAC Recommendation on County Policy for Resident Protection from ICE Cooperation

01:06:43

The Council engaged in a broader conversation about federal ICE policies and their local impacts. Members suggested writing a letter to Supervisor Gioia commending his leadership and recommending additional actions, including support for state legislation requiring ICE officers to display identification and remove face coverings, as well as increasing training and outreach to businesses and immigrant communities. The Council also discussed expanding the "Stand Together Contra Costa" initiative to further assist West County residents.

DI. 4 - Impact of SOS Richmond Service Loss and Potential MAC Response

01:31:35

The Council received an update on the Warm Hands Wellness and Resource Center located at the San Pablo Library. Over the past year, the center has provided 896 showers and 564 loads of laundry, serving approximately 100 individuals per month. The center will soon relocate to the Church of Christ parking lot and continues to take a person-centered approach to support services. Additionally, 8.135 tons of trash have been collected from encampments in the past month, highlighting the significant need for continued sanitation efforts. Challenges with funding were discussed, particularly the City of Richmond's reduction in financial support.

An update was provided on the Pinole Creek Restoration Project, which is offering participants hands-on training in environmental stewardship. The program also supports workforce development by equipping individuals with transferable skills while promoting creek health. The Council discussed funding gaps and the need for sustained investment, recommending that a letter be sent to Supervisor Gioia outlining the unique services offered and the importance of continued financial support.

6. Public comment on any item under the jurisdiction of the Committee and not on this agenda (speakers may be limited to two minutes).

01:54:51

Concerns were raised about a proposed bike trail in Wildcat Canyon, citing potential environmental impacts and increased traffic. There was general concern regarding the lack of transparency and public engagement in the project's planning phase. The Council recommended setting up a meeting with East Bay Regional Park District staff to better understand the environmental review process and provide public input.

Concerns about speeding on Dam Road were raised, with residents describing unsafe driving conditions. The effectiveness of California Highway Patrol (CHP) patrols was noted, though it was acknowledged that staffing limitations may hinder regular enforcement. The Council agreed on the importance of pursuing affordable traffic calming solutions and suggested inviting CHP representatives to future meetings.

Attendees reiterated support for wellness services and housing initiatives. Council members agreed to draft a formal letter to Supervisor Gioia based on the meeting's discussions.

An update was provided on The Good Table, a new community-serving space. Power has been connected, and gas service is expected soon. The project is on track for an October opening. The Council expressed support for continued investment to ensure the space can meet the community's needs for gatherings, events, and meetings.

7. Information Items

Updates were shared on several upcoming community events. The El Sobrante Pride event was announced, with encouragement for local organizations to host informational booths and volunteer. The El Sobrante Stroll was also discussed, featuring vendors, music, and family-friendly activities.

8. Subcommittee Reports – Next Clean Up, September 20, 2025

02:15:04

The Green Team provided updates on cleanup events, including a Coastal Cleanup Day and plans for a themed parade float. Councilmembers emphasized the importance of volunteer participation in making these events successful.

9. Agenda Items / Speakers for Upcoming ESMAC Meetings

02:19:42

The next meeting is currently scheduled for October 8, 2025

Adjourn

The Council will provide reasonable accommodations for persons with disabilities planning to attend the Council meetings. Contact the staff person listed below at least 72 hours before the meeting. Any disclosable public records related to an open session item on a regular meeting agenda and distributed by the County to a majority of members of the Council less than 96 hours prior to that meeting are available for public inspection at El Sobrante Library (4191 Appian Way, El Sobrante, CA 94803) during normal business hours. Staff reports related to items on the agenda are also accessible online at www.contracosta.ca.gov. If the Zoom connection malfunctions for any reason, the meeting may be paused while a fix is attempted. If the connection is not reestablished, the Council will continue the meeting in person without remote access. Public comment may be submitted via electronic mail on agenda items at least one full work day prior to the published meeting time.

For Additional Information Contact: Ronnie Mills, ronnie.mills@bos.cccounty.us, 510-942-2222



CONTRA COSTA COUNTY

1025 ESCOBAR STREET MARTINEZ, CA 94553

Staff Report

File #: 25-4039 Agenda Date: 10/8/2025 Agenda #:

Advisory Board: El Sobrante Municipal Advisory Council

Subject: County File Number: CDVR25-01044

Information:

County File Number: CDVR25-01044

CONTRA COSTA COUNTY DEPARTMENT OF CONSERVATION AND DEVELOPMENT

COMMUNITY DEVELOPMENT DIVISION

30 Muir Road

Martinez, CA 94553-4601 Phone: 925-655-2700 Fax: 925-655-2758



AGENCY COMMENT REQUEST

We request your comments regarding the attached applic	Date 09/05/25cation currently under review.
DISTRIBUTION INTERNAL ✓ Building Inspection Grading Inspection ✓ Advance Planning Housing Programs Trans. Planning Telecom Planner ALUC Staff HCP/NCCP Staff County Geologist HEALTH SERVICES DEPARTMENT ✓ Environmental Health Hazardous Materials PUBLIC WORKS DEPARTMENT Engineering Services Special Districts Traffic Flood Control (Full-size) LOCAL ✓ Fire District San Ramon Valley – (email) nvendel@srvfire.ca.gov ✓ Consolidated – (email) fire@cccfpd.org ✓ Sanitary District West County Wastewater ✓ Water District EBMUD ✓ City of Richmond School District(s) LAFCO Reclamation District # East Bay Regional Park District Diablo/Discovery Bay/Crockett CSD ✓ MAC/TAC El Sobrante MAC Improvement/Community Association ✓ CC Mosquito & Vector Control Dist (email) OTHERS/NON-LOCAL CHRIS (email only: nwic@sonoma.edu)	
CA Fish and Wildlife, Region 3 – Bay Delta Native American Tribes ADDITIONAL RECIPIENTS	Signature DATE
El Sobrante Planning and Zoning	Agency phone #



Planning Application Summary

County File Number: CDVR25-01044 File Date: 9/3/2025

Applicant:

moji hakimi mhakimi@mac.com 2 tunnel rd (925) 683-3072 berkeley, CA 94705

Property Owner:

ADAM MORGENTHALER adam.morgenthaler@gmail.com

41 HELTSLEY PL (408) 891-6012 EL SOBRANTE, CA 94803 165

Project Description:

The applicant requests approval of a variance to allow a 12-foot secondary front setback (where 15 feet is the minimum required) to replace an existing deck.

Project Location: (Address: 41 HELTSLEY PL, EL SOBRANTE, CA 94803 165), (APN: 426243037)

Additional APNs:

General Plan Designation(s): RLM Zoning District(s): R-7

Flood Hazard Areas: X AP Fault Zone: NO


60-dBA Noise Control: NO MAC/TAC: El Sobrante MAC

Sphere of Influence: Richmond **Fire District:** CONSOLIDATED FIRE

Sanitary District: WEST CO WASTEWATER Housing Inventory Site: NO

Specific Plan: N/A

Fees:				
Fee Item	Description	Account Code	Total Fee	Paid
052B	Notification Fee (\$30)	002606-9660-REV-000-5B052B	30.00	30.00
HSDR	Environmental Health Fee (\$57)	002606-9660-REV-000-5BHSDR \$5.00	57.00	57.00
VRS0044	Zone Variance - DCD	002606-9660-REV-000-5B0044	3250.00	3250.00
		Total:	3337.00	3337.00

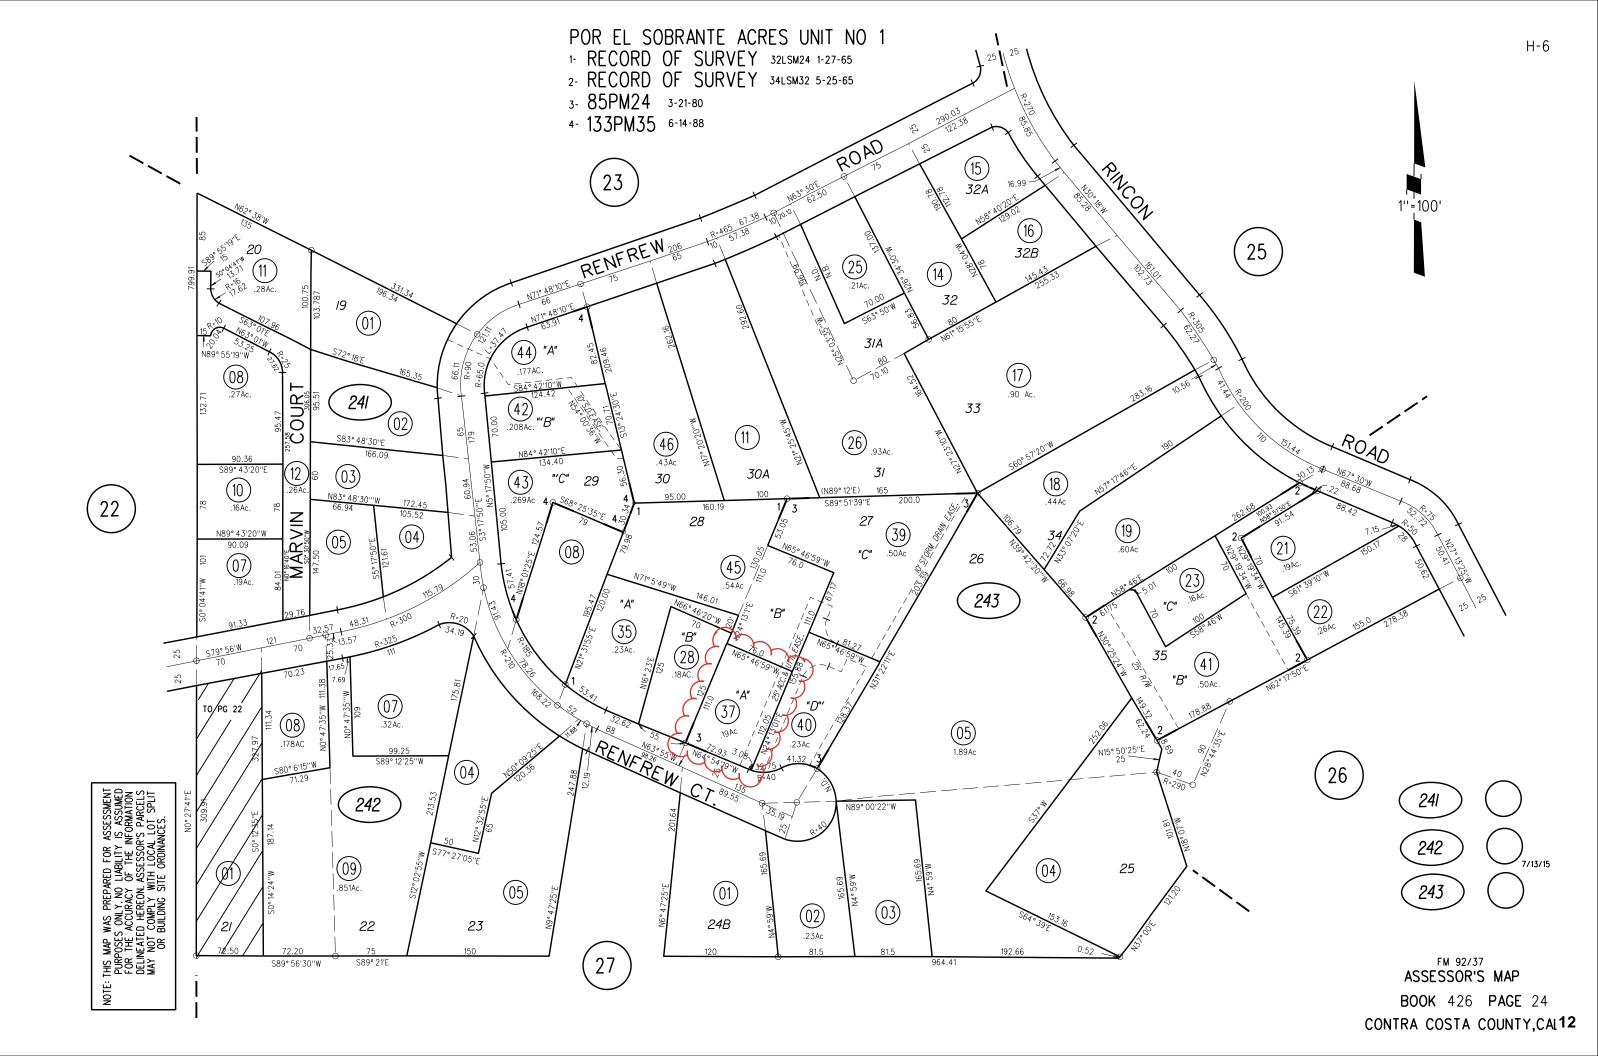

General Plan




Map Legend Assessment Parcels General Plan RLM (Residential Low-Medium Density) (3-7 du/na) Unincorporated Board of Supervisors' Districts

Address Points

is a user generated, static output from an internet mapping application and is intended for reference. Data layers that appear on this map may or may not be accurate, current, or otherwise reliable. THIS MAP IS NOTTO BE USED FOR NAVIGATION CCMap is maintained by Contra Costa County Department of Information Technology, County GIS. layers contained within the CCMap application are provided by various contra Costa County Department.

Zoning

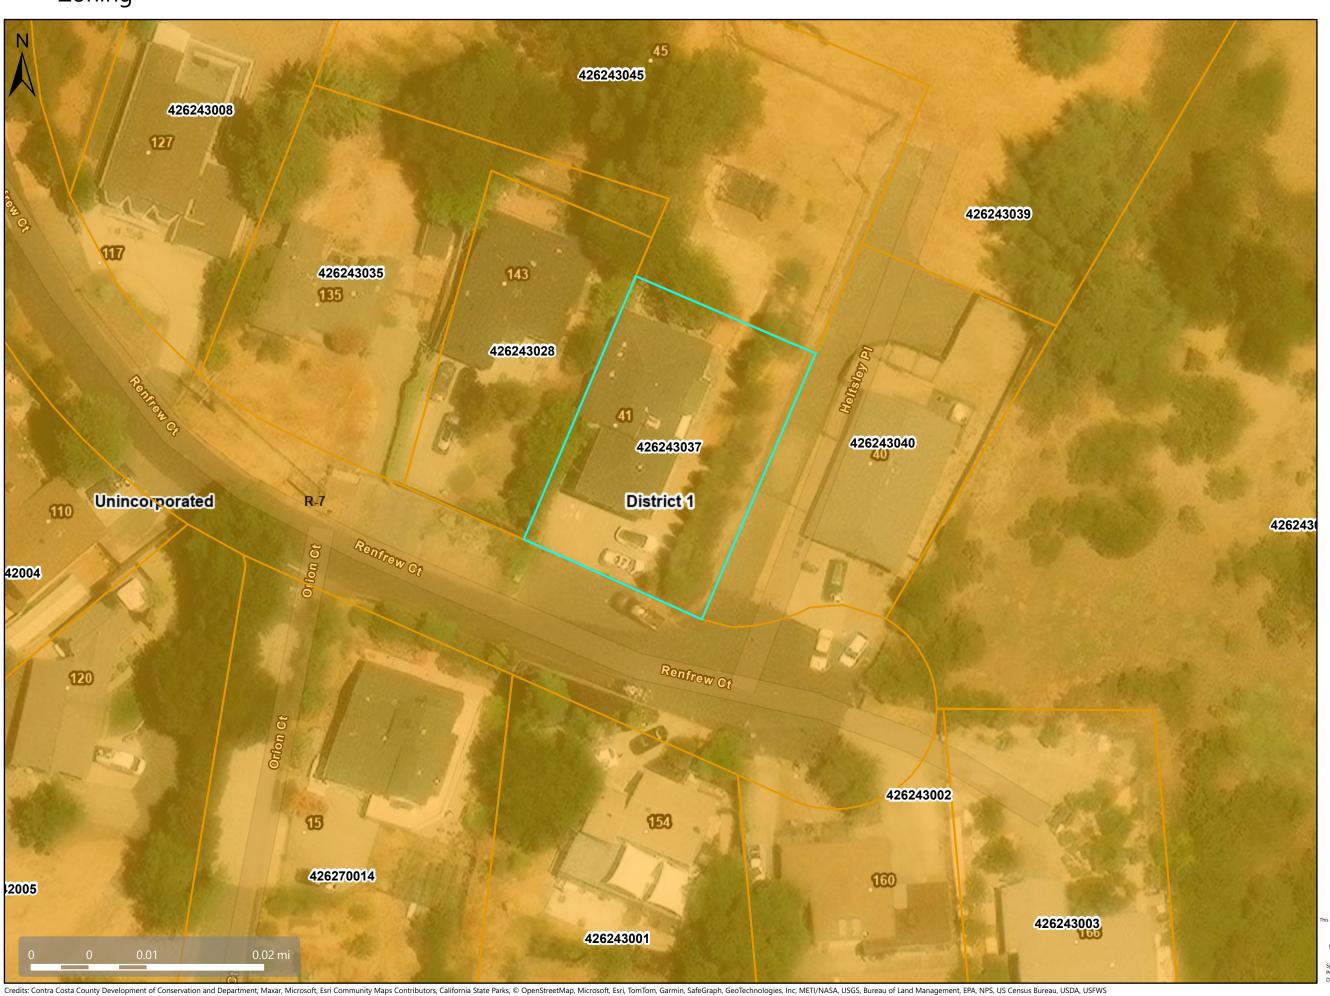

Map Legend Assessment Parcels Zoning ZONE_OVER R-7 (Single Family Residential) Unincorporated Board of Supervisors' Districts

Address Points

is a user generated, static output from an internet mapping application and is intended for reference. Data layers that appear on this map may or may not be accurate, current, or otherwise reliable. THIS MAP IS NOT TO BE USED FOR NAMIGATION. CCMap is maintained by Contra Costa County Department of Information Technology, County GIS layers contained within the CCMap application are provided by various Contra Costa County Department.

Orthophotography



Map Legend Assessment Parcels Unincorporated Board of Supervisors' Districts **Address Points**

er generates, state output from an internet mapping application and is intended for reterence. alleyers that appear on this map may or may not be accurate, current, or otherwise reliable. THIS MAP IS NOT TO BE USED FOR NAVIGATION. pis maintained by Contra Costa Country Department of Information Technology, County GIS. contained within the CCMap application are provided by various Contra Costa Country Department.

64' Long Second-Story Balcony

Repair/Rebuild Project

RECEIVED on 09/03/2025 CDVR25-01044
By Contra Costa County Department of Conservation and Development

41 Heltsey PI, El Sobrante, CA 94803

ASSESSOR'S PARCEL# 426-243-037-6

TYPE R-3 OCCUPANCY:

CONSTRUCTION TYPE: TYPE - V

BUILDING MATERIAL: Framing: Pressure-treated lumber

> Decking: Composite (Trex or equivalent) Footings: Concrete w/ Rock Veneer

Hardware/Fasteners: Corrosion-resistant (HDG Typ.)

Guardrails/Handrails: Aluminum

SQUARE FOOTAGE

OF DECK:

800 SQ. FT.

BUILDING CODE: CALIFORNIA BUILDING CODE 2022 CODE (IBC 2021)

SHEET NO.	SHEET NAME:	SCALE:
AA-01	General notes	N/A
AA-02	Site (Plot) Plan	N/A
AA-03	Topographic Contours Map	1/8" = 1'-0"
AA-04	Context Photo Page	1" =10'-0"
AA-05	Site Plan - Existing	N/A
AR-01	Deck Demolition Plan	3/16" = 1'
AR-02	Site Plan - Proposed Structures	3/16" = 1'
AR-03	Proposed Deck Plan	3/16" = 1'
AR-04	Proposed deck visualization	N/A
AR-05	Proposed deck visualization	N/A
S-01	Structural Engineer Drawings	As dispayed
S-02	Structural Engineer Drawings	As dispayed
S-03	Structural Engineer Calculations Sheets	N/A
S-04	Structural Engineer Calculations Sheets	N/A
S-05	Structural Engineer Calculations Sheets	N/A
ST-01	Proposed Deck Plan	3/8" = 1'
ST-02	Foundation Layout Plan - Proposed Deck	3/8" = 1'
ST-03	Column Layout Plan - Proposed Deck	3/8" = 1'
ST-04	Beam Framing Plan - Proposed Deck	3/8" = 1'
ST-05	Deck Framing Plan - Joists	3/8" = 1'
ST-06	Deck Framing Plan - Diagonal Bracing	3/8" = 1'
ST-07	Deck Boards Plan	3/8" = 1'
ST-08	Front Elevation	3/8" = 1'
ST-09	Side Elevation 1 - Railing Structural Details	3/8" = 1'
ST-10	Side Elevation 2	3/8" = 1'
EL-01	Lighting Layout Plan	3/8" = 1'
EL-02	Lighting Detail	N/A
EL-03	Lighting Layout Elevation	3/8" = 1'

VICINITY MAP Bethel Christian Acader

Project Team Architect

Quinn & Adam Morgenthaler (408) 891-6012 Adam.Morgenthaler@gmail.com

Owner


Zen Life Design +57 (314) 503-6394 Notyuriy@gmail.com

Structural Engineer

Andersen Engineering (415) 250-8473 erik@andersen-engineering.com Allcurrents@gmail.com

Electrical Engineer

AC3 LLC Electric (510) 390-6002

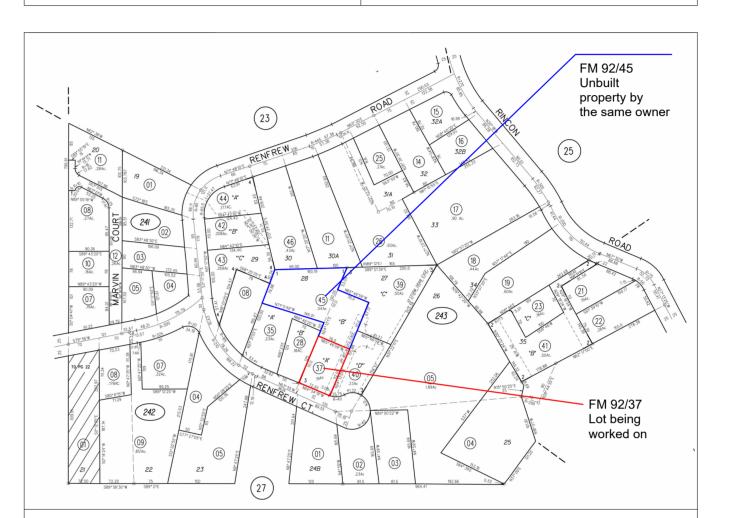

FM 92/37 **ASSESSOR'S MAP BOOK 426 PAGE 24** CONTRA COSTA COUNTY, CALIFORNIA

DATE & APPROVAL

IS RE DATE

Project Name

64' Long Second-Story Balcony Repair/Rebuild Project

Project Address

41 Heltsey Pl, El Sobrante, CA 94803

Existing balcony is a cantilevered structure extending 4' beyond the outside wall. The existing balcony has become weathered/rotted due to elements and is in need of repair

Repair of the existing deck as built is not possible due to the extent of rotting joists which precludes re-use or sistering. Instead it is proposed that the existing balcony will be demolished. Joists will be cut flush with side of house and damage repaired as needed prior to start of rebuild. The new structure will be attached via ledger board, extend 10' from the existing structure and be supported by new posts placed in existing yard.

Sheet Title

Cover Sheet



VALUE ENGINEERING REVISIONS ISSUED FOR ISSUANCE OF PERMIT Project number **ISSUED FOR PRICING ISSUED FOR PERMIT** Drawn by 3 C 2025-08-18 ISSUED FOR OWNER REVIEW 1 A 2025-07-21 ISSUED FOR OWNER REVIEW

DESCRIPTION

Adam Morgenthaler

Scale

AA-01

2025-08-18

Zen Life Design

General Notes:

- 1. The Contract for construction shall generally follow the general conditions of AIA contract A201, 2017 version.
- 2. The Contractor shall keep the jobsite clean and safe at all times and shall leave the premises clean and orderly, and ready for occupancy.
- 3. Contractor shall provide work completely and in accordance with current applicable codes.
- 4.Contractor shall be responsible for any damage incurred through any errors or omissions within their work to this property or to the adjacent private and/or publicly owned properties.
- 5.Contractor shall not perform any work that will result in a change order without prior written approval from owner. Change orders must be provided in writing and shall be for either additions or subtractions to the construction contract. Change orders must be signed by the owner before the work proceeds.
- 6.Contractor to review all design changes or substitutions with the Owner & structural engineer and receive approval for all changes.
- 7. Written dimensions take precedence over scale. Do not scale the drawings.
- 8. Contractor to verify all field conditions and measurements before starting construction. Alert architect of all discrepancies and/or variation before proceeding with work.
- 9. Contractor to report on the progress of work to the owner at a minimum, on a bi-weekly basis or more frequently as conditions warrant. Meetings with the owner shall be scheduled to allow for time required to provide appropriate response to any questions or site conditions.
- 10. Contractor shall arrange for a meeting after determining the project dimensional layout for review by the architect and owner.
- 11.Code upgrade work not required by building inspectors is to be reviewed with the architect and owner to determine course of action. If the contractor believes code upgrade is necessary and it has not been required by the building inspector, the architect and owner shall determine whether the work is to be undertaken.
- 12.Install all equipment, fixtures, and materials per manufacturer's recommendations.
- 13. Contractor to coordinate with owner for owner-provided materials and products.
- 14.CRC317.3.1 fasteners for preservative-treated wood: "fasteners, including nuts and washers, for preservative-treated wood shall be of hot-dipped, zinc-coated galvanized steel, stainless steel, silicon bronze or copper. coating types and weights for connectors in contact with preservative-treated wood shall be in accordance with the connector manufacturer's recommendations. in the absence of manufacturer's recommendations, a minimum of ASTM A653 type G185 zinc-coated galvanized steel, or equivalent, shall be used.
- 15.All cuts of pressure treated lumber are to be treated with Copper-Green Wood Preservative prior to installation. Alternatives by owner approval only.
- 16. Joist tape to be used on all horizontal members prior to installation of any other pieces atop. Ensure all joist tops, beams, and ledger boards are clean and dry. Remove dirt, sawdust, and debris for best adhesion. Fold overhangs down each side. If overhang >1cm trim excess
- 17. Alignment of the posts with bases is critical and shall be off by no more than 1 inch from center in any direction.
- 18.Install decking with spacing per manufacturer's recommendations.
- 19.All joist hangers, diagonal braces, blocking/bridging, and structural mounting hardware must be secured using approved, manufacturer-specified structural fasteners (not drywall or generic screws) such as galvanized or stainless steel nails, screws, or bolts, to ensure code compliance and maximum load-bearing safety.
- 20. Seams of decking boards are to be randomly staggered without a evident pattern.
- 21.Miter cuts for decking are to be 90° ± 2° to avoid the appearance of end stepping. End joining of the decking shall be on a shared joist with adequate spacing as defined by the manufacturer to enable thermal expansion and contraction

Project Na

64' Long Second-Story
Balcony
Repair/Rebuild
Project

Project Address

41 Heltsey Pl, El Sobrante, CA 94803

Project Description

Sheet Title


GENERAL NOTES


8			
7			VALUE ENGINEERING REVISIONS
6			ISSUED FOR ISSUANCE OF PERMIT
5			ISSUED FOR PRICING
4			ISSUED FOR PERMIT
3	С	2025-08-18	ISSUED FOR OWNER REVIEW
2	В	2025-08-05	ISSUED FOR OWNER REVIEW
1	Α	2025-07-21	ISSUED FOR OWNER REVIEW
IS	RE	DATE	DESCRIPTION

DATE & APPROVAL

Project number 1
Date 2025-08-18
Drawn by Zen Life Design
Checked by Adam Morgenthaler

AA-02

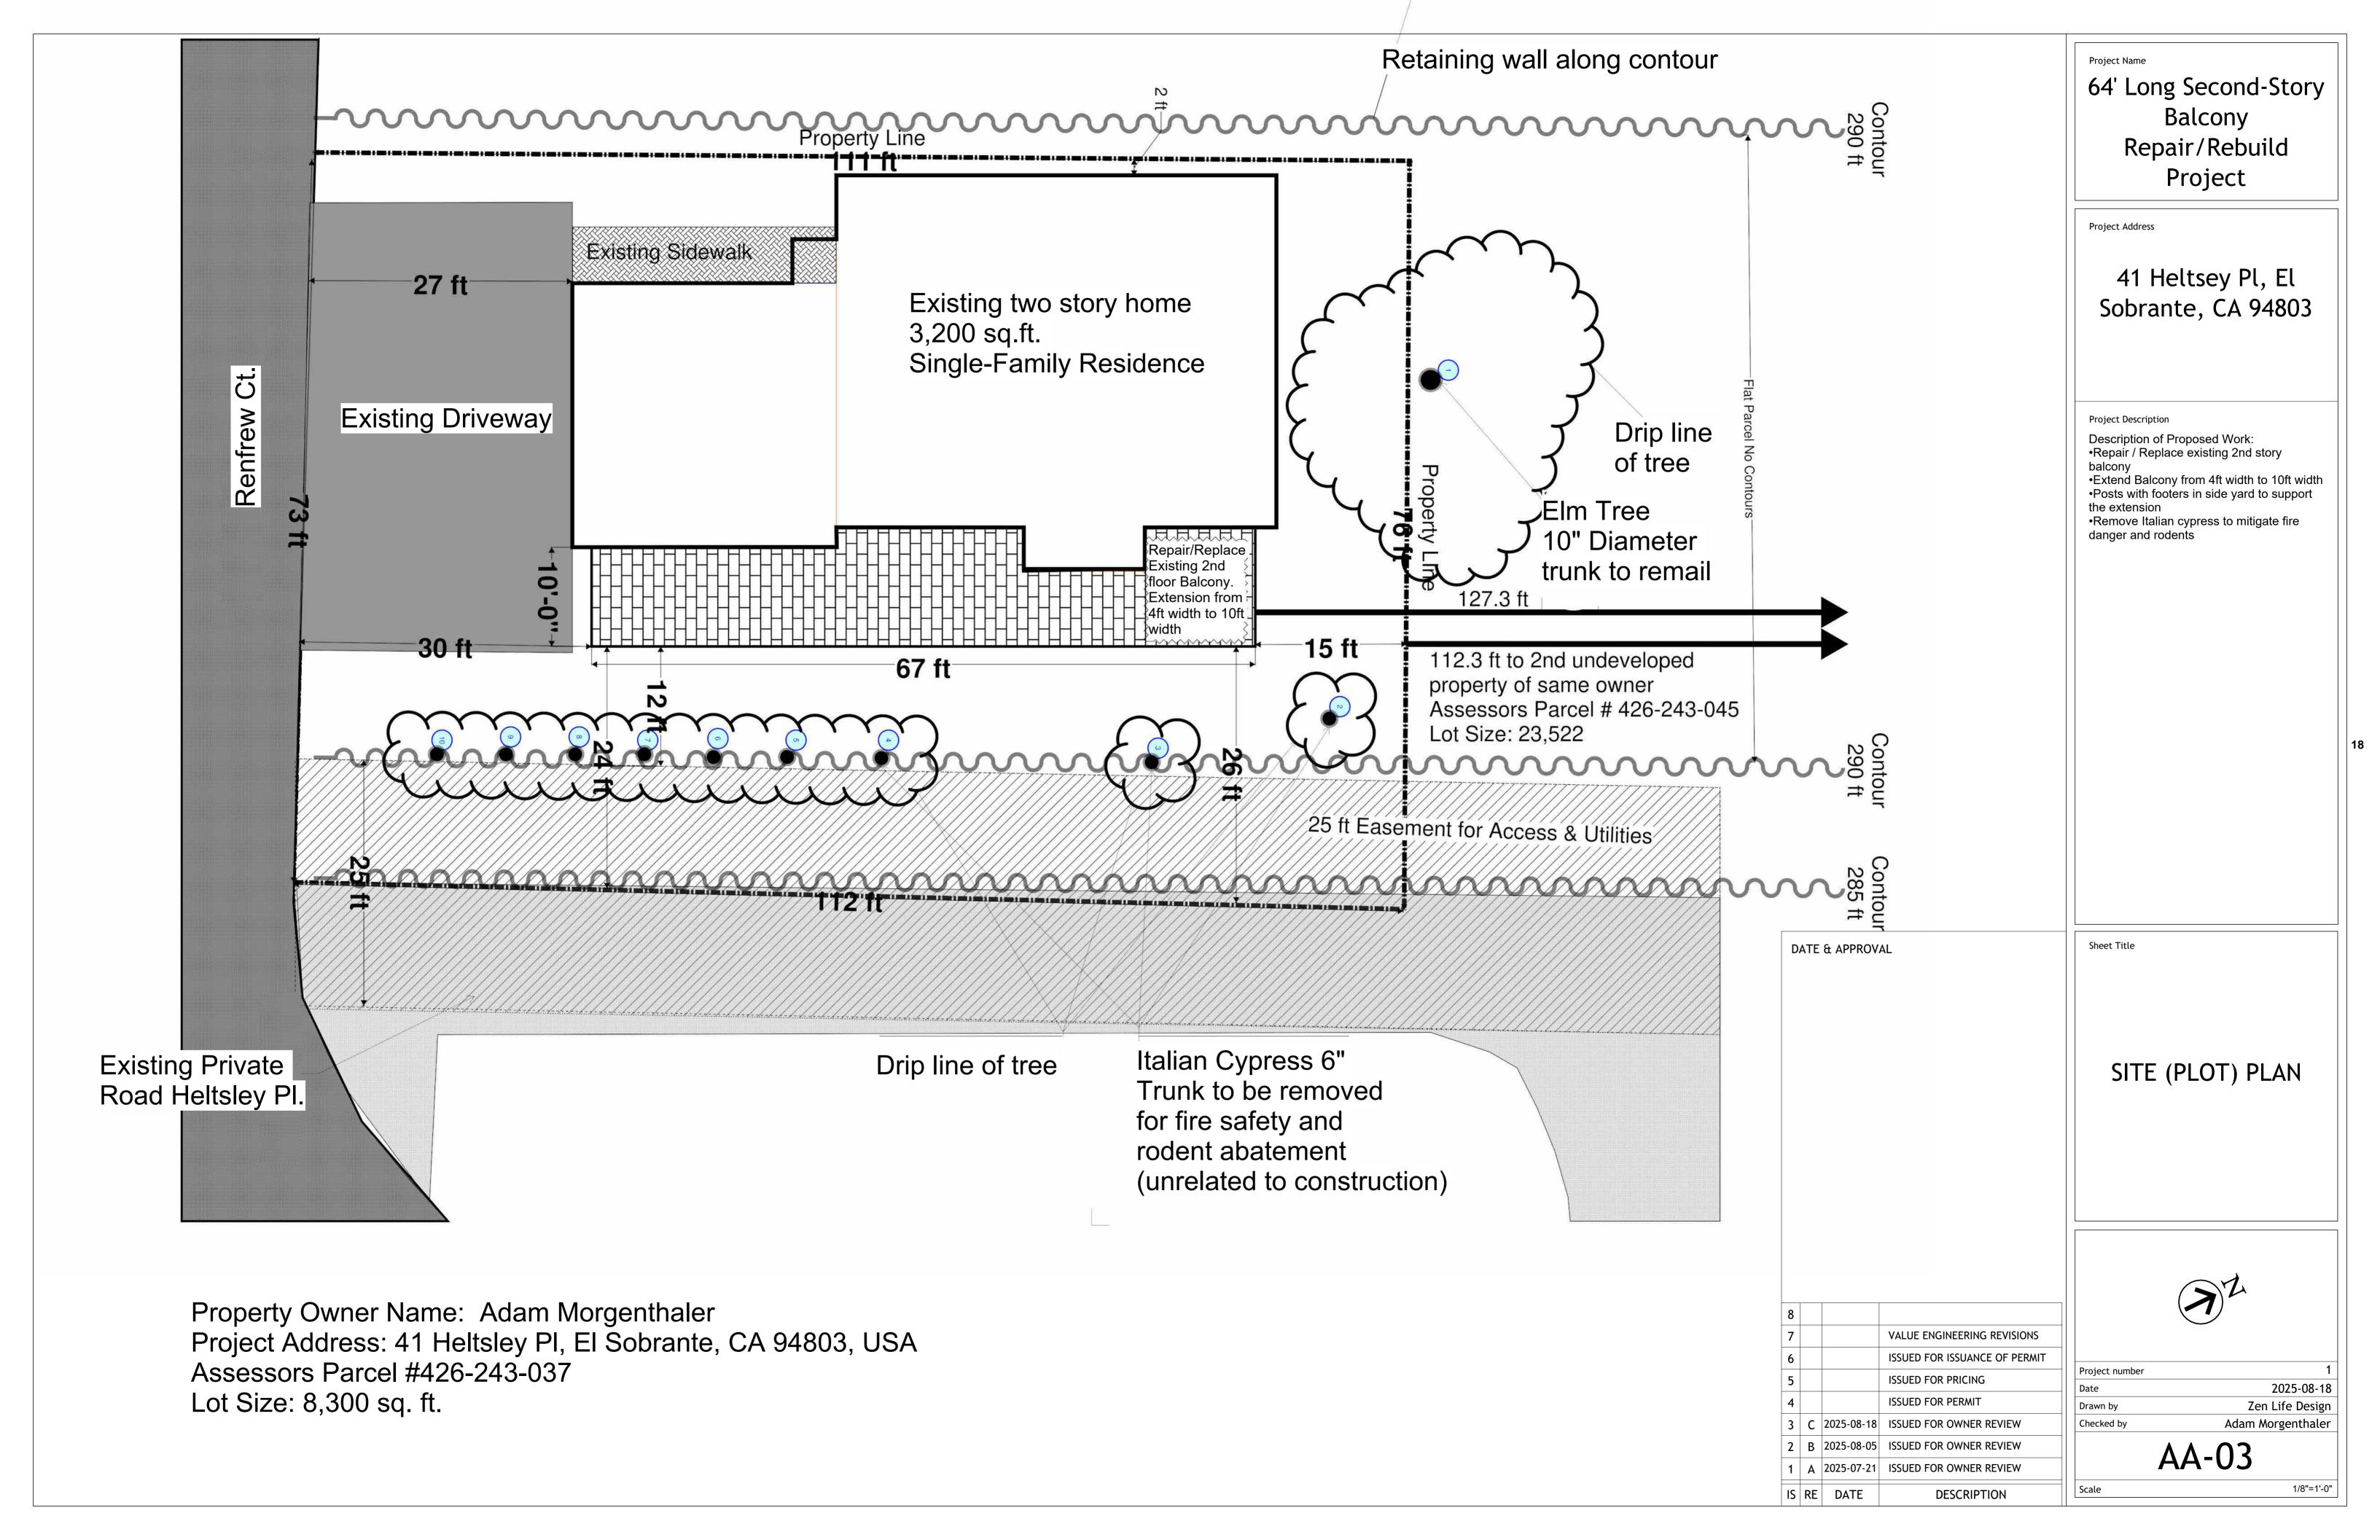

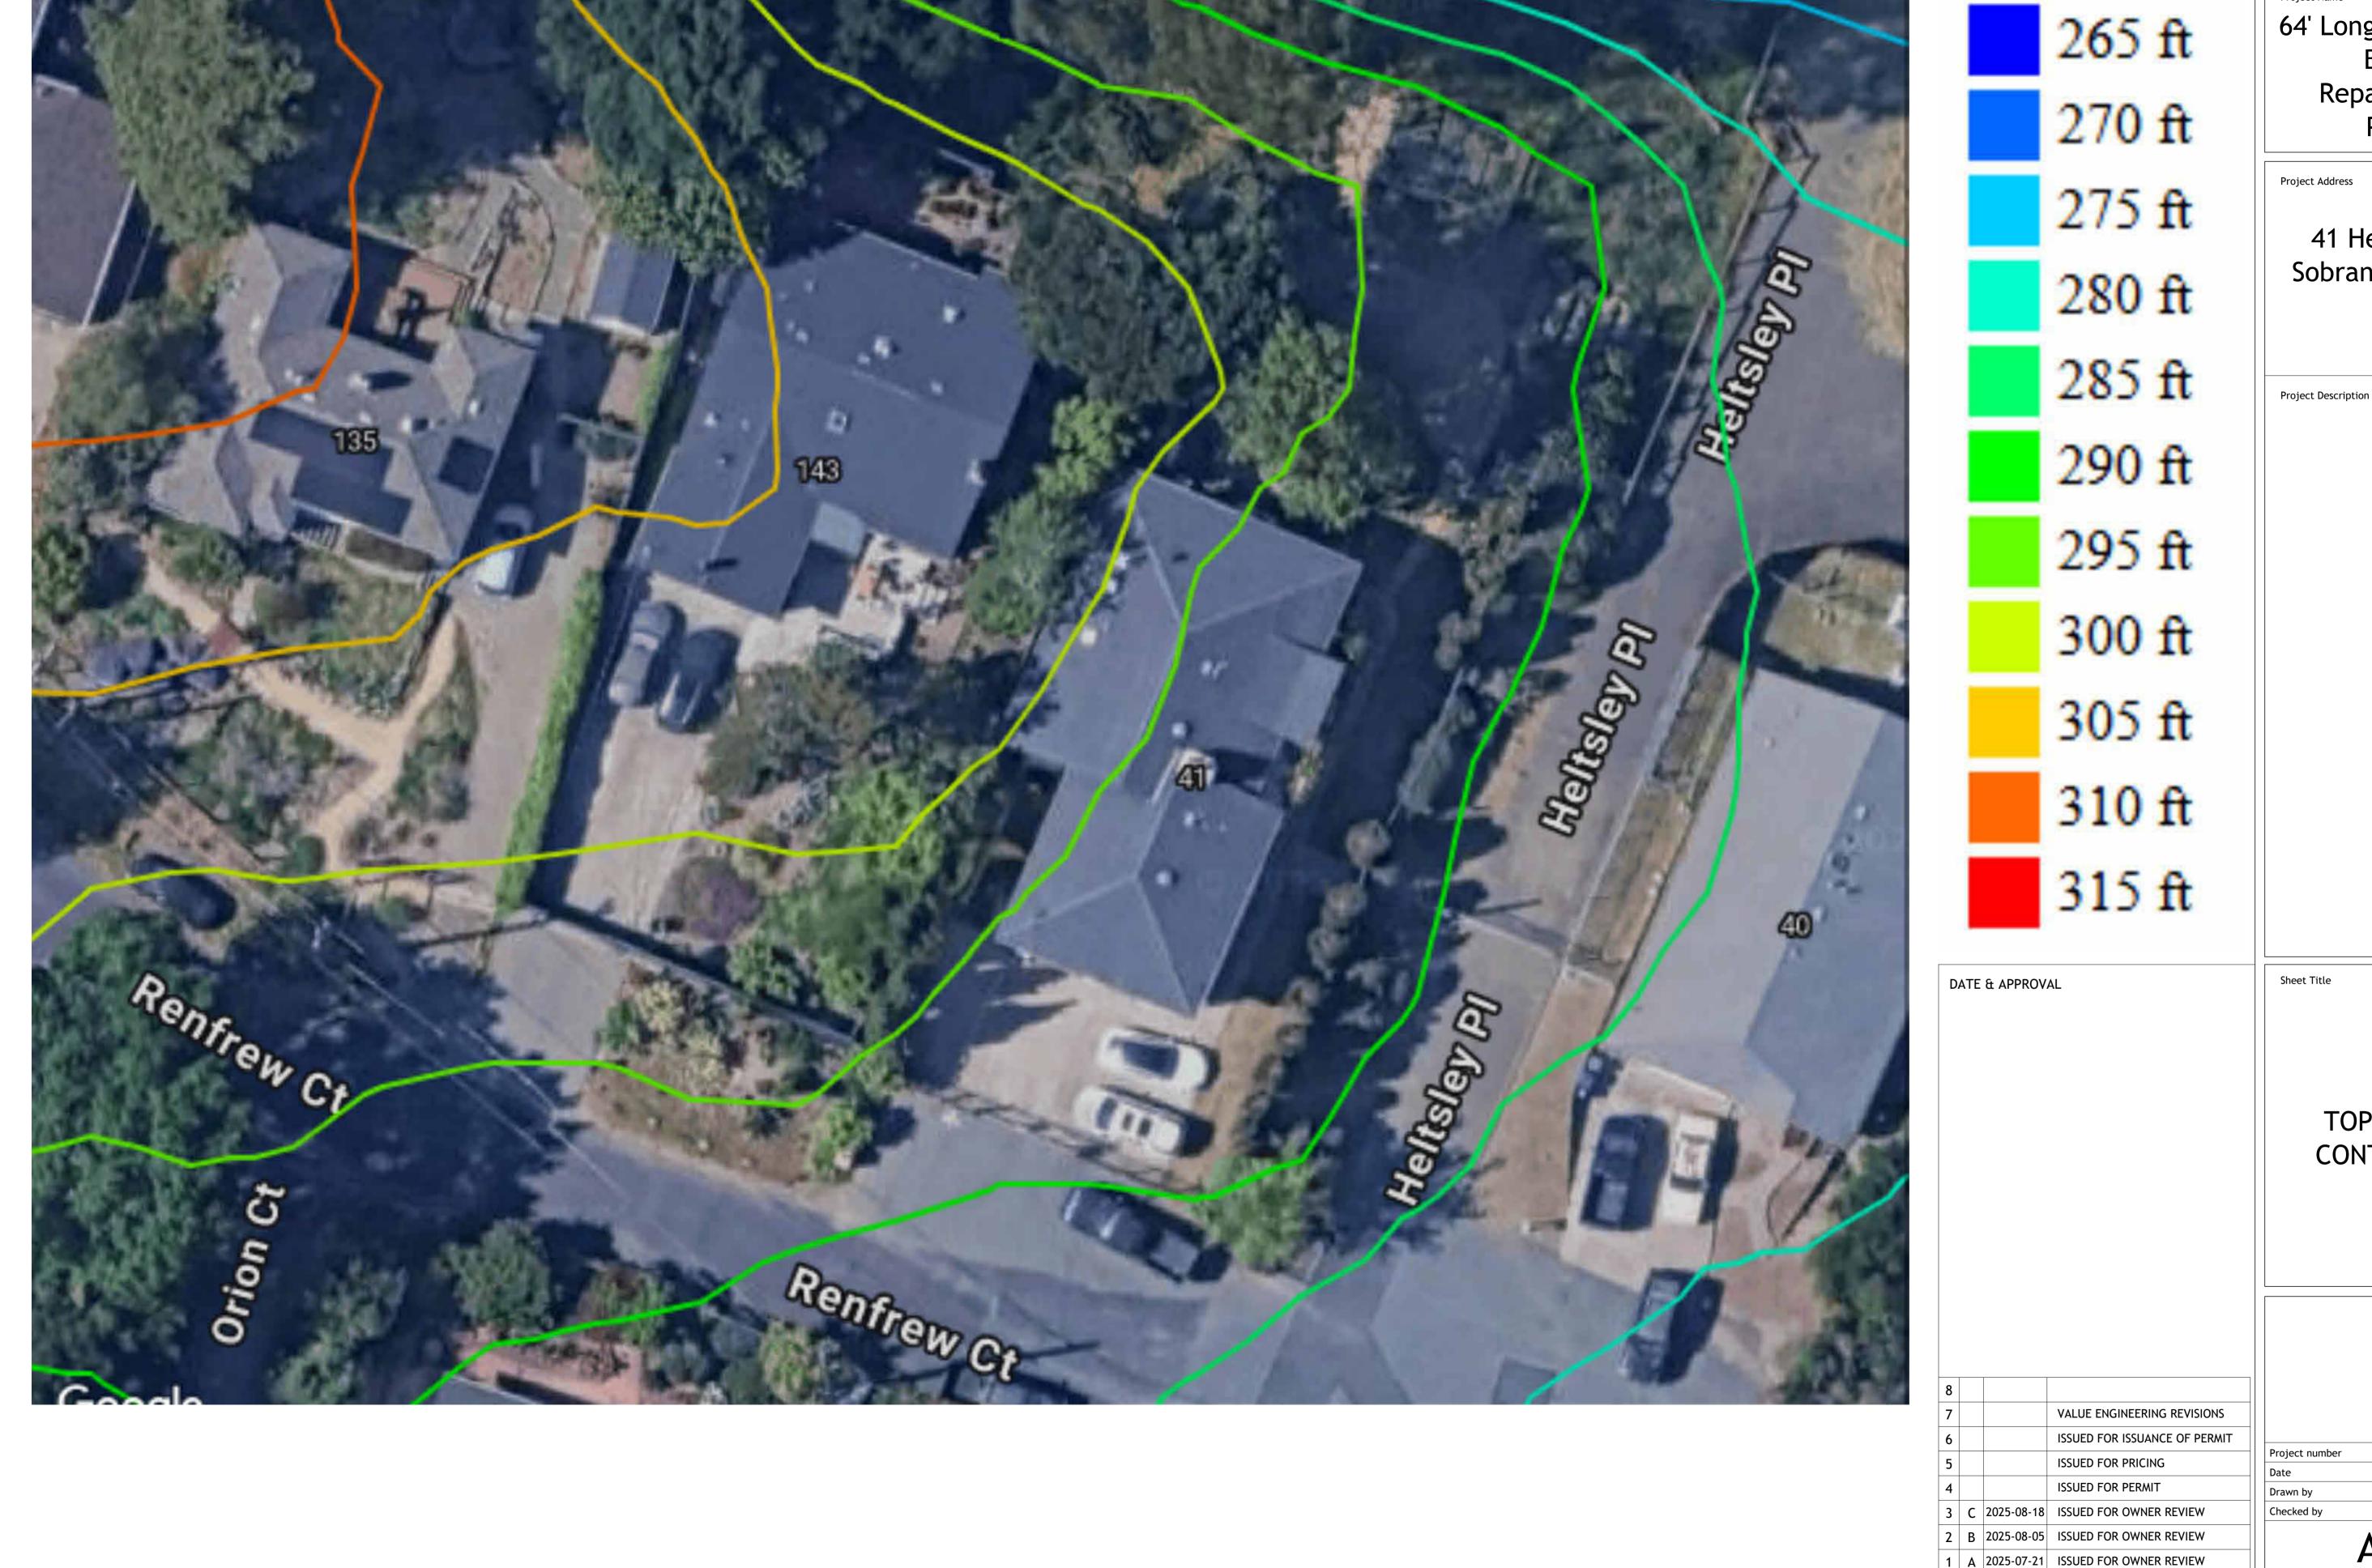

Project Name 64' Long Second-Story

Balcony Repair/Rebuild Project

41 Heltsey Pl, El Sobrante, CA 94803

TOPOGRAPHIC **CONTOURS MAP**

	N

Scale

DESCRIPTION

IS RE DATE

2025-08-18 Zen Life Design Adam Morgenthaler

AA-04

1"=10'-0"

Project Name


64' Long Second-Story
Balcony
Repair/Rebuild
Project


Project Address

41 Heltsey Pl, El Sobrante, CA 94803

Project Description

20

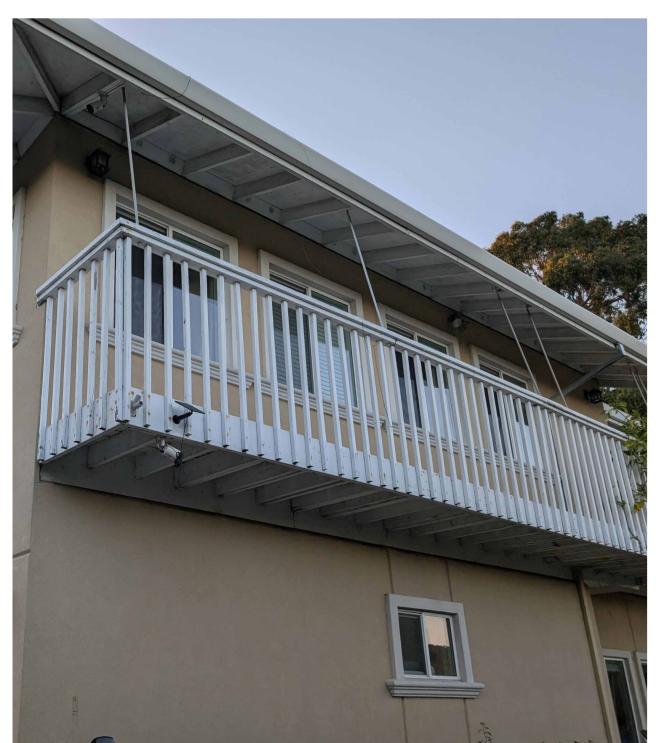

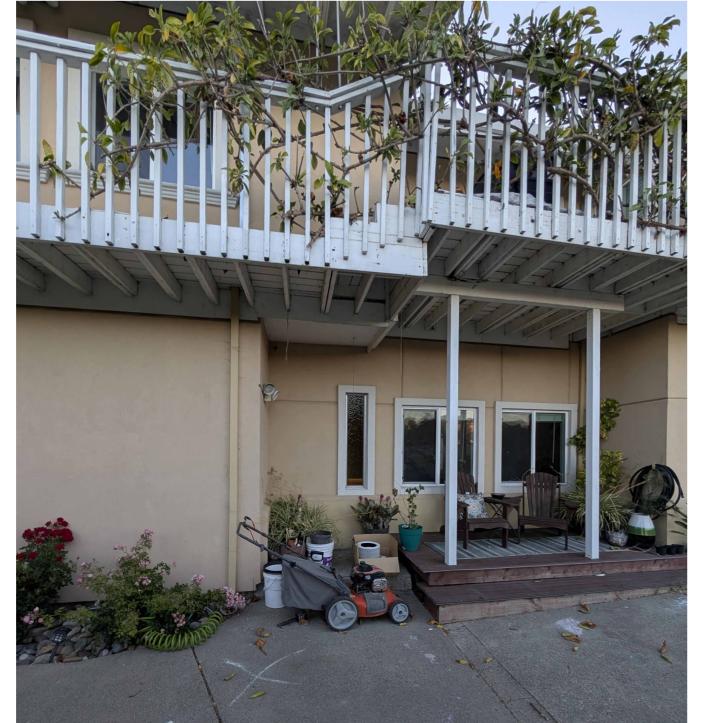



DATE & APPROVAL

CONTEXT PHOTO PAGE

Sheet Title

8			
7			VALUE ENGINEERING REVISIONS
6			ISSUED FOR ISSUANCE OF PERMIT
5			ISSUED FOR PRICING
4			ISSUED FOR PERMIT
3	С	2025-08-18	ISSUED FOR OWNER REVIEW
2	В	2025-08-05	ISSUED FOR OWNER REVIEW
1	Α	2025-07-21	ISSUED FOR OWNER REVIEW
IS	RE	DATE	DESCRIPTION


Project number 1


Date 2025-08-18

Drawn by Zen Life Design

Checked by Adam Morgenthaler


AA-05

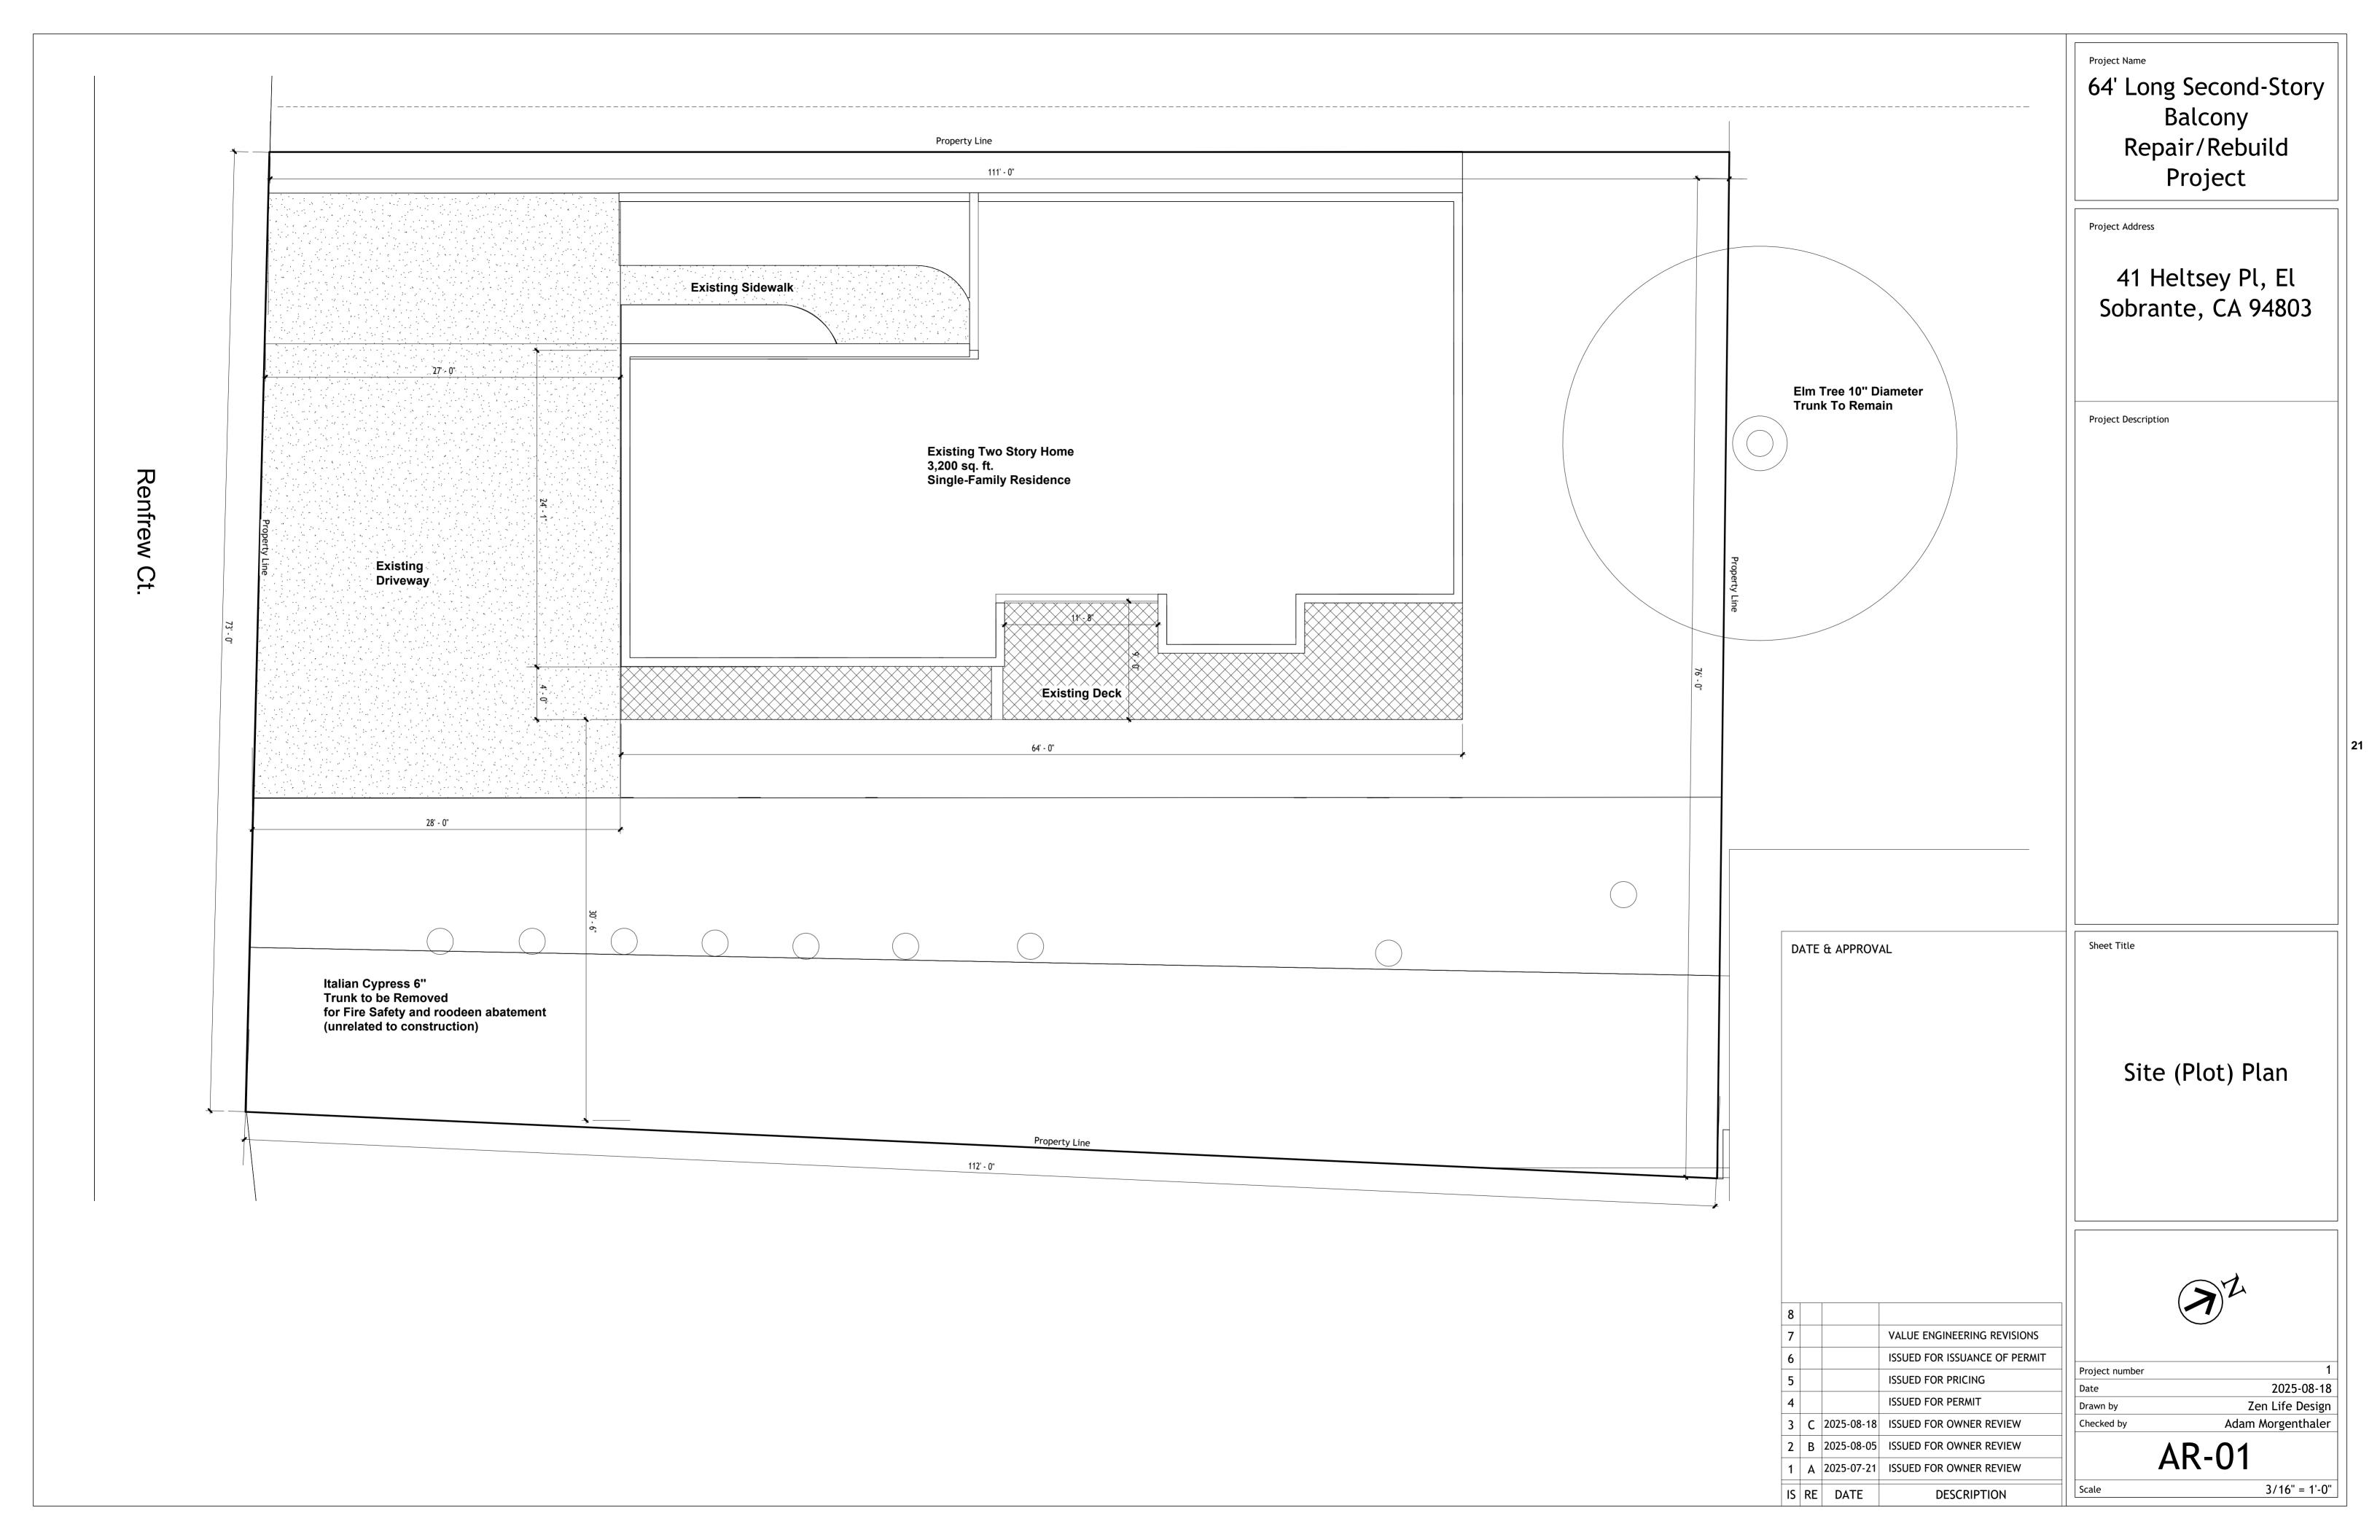

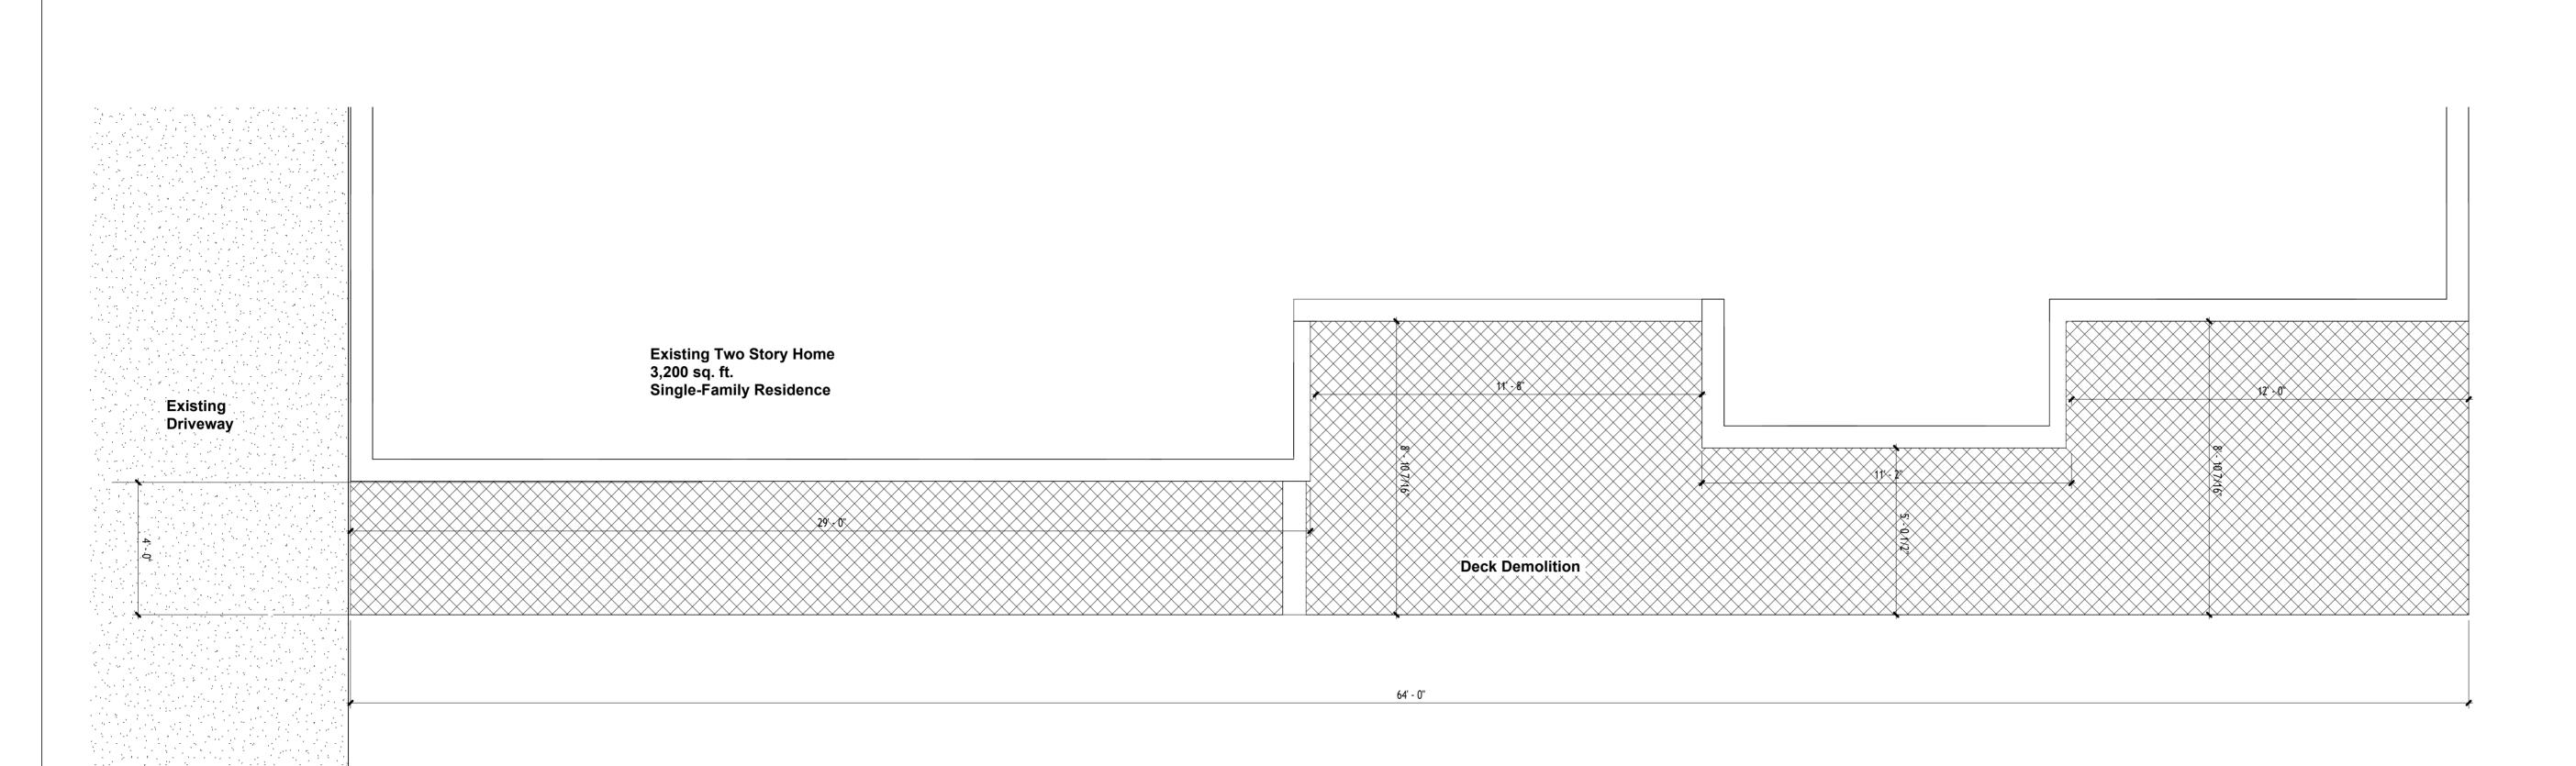

NOTES

- 1) Contractor is responsible for coordinating all demolition with new construction, ensuring all utilities are safe, and restoring disturbed surfaces to original or better condition. Immediately report any unforeseen conditions to the owner/engineer for direction.
- 2) No access through the house for demolition. Use of ladders and scaffolding required for access.
- 3) Do not walk/stand on existing structure. All weight bearing must be independently ground supported.
- 4) Place tarps/canvas on ground in demolition area to catch falling debris.
- 5) Cut existing cantilevered joists flush with inside edge of exterior wall (refer to structural engineering drawings for details)
- 6) To comply with CalGreen's 65% waste diversion requirement, re-useable boards to be provided to homeowner while deteriorated ones will be disposed of as construction debris at approved local landfill or transfer station. Records to be maintained for estimated re-used materials vs disposed materials.
- 7) Remove debris and demolished building materials promptly and store in designated containers or protected staging areas. Segregate wood, metal, and other recyclable construction debris to maximize recycling per state (CalGreen) and county requirements. Salvage materials when feasible.
- 8) Dispose of all pressure treated wood as hazardous waste.

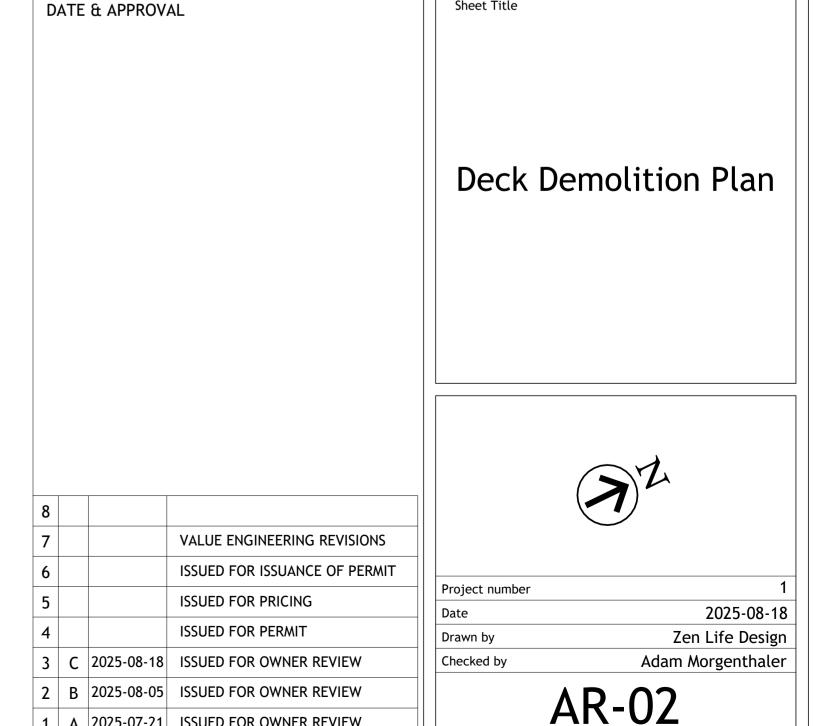

1 A 2025-07-21 ISSUED FOR OWNER REVIEW

DESCRIPTION

IS RE DATE

Project Name 64' Long Second-Story Balcony Repair/Rebuild Project


Project Address


41 Heltsey Pl, El Sobrante, CA 94803

Project Description

3/8" = 1'-0"

Sheet Title

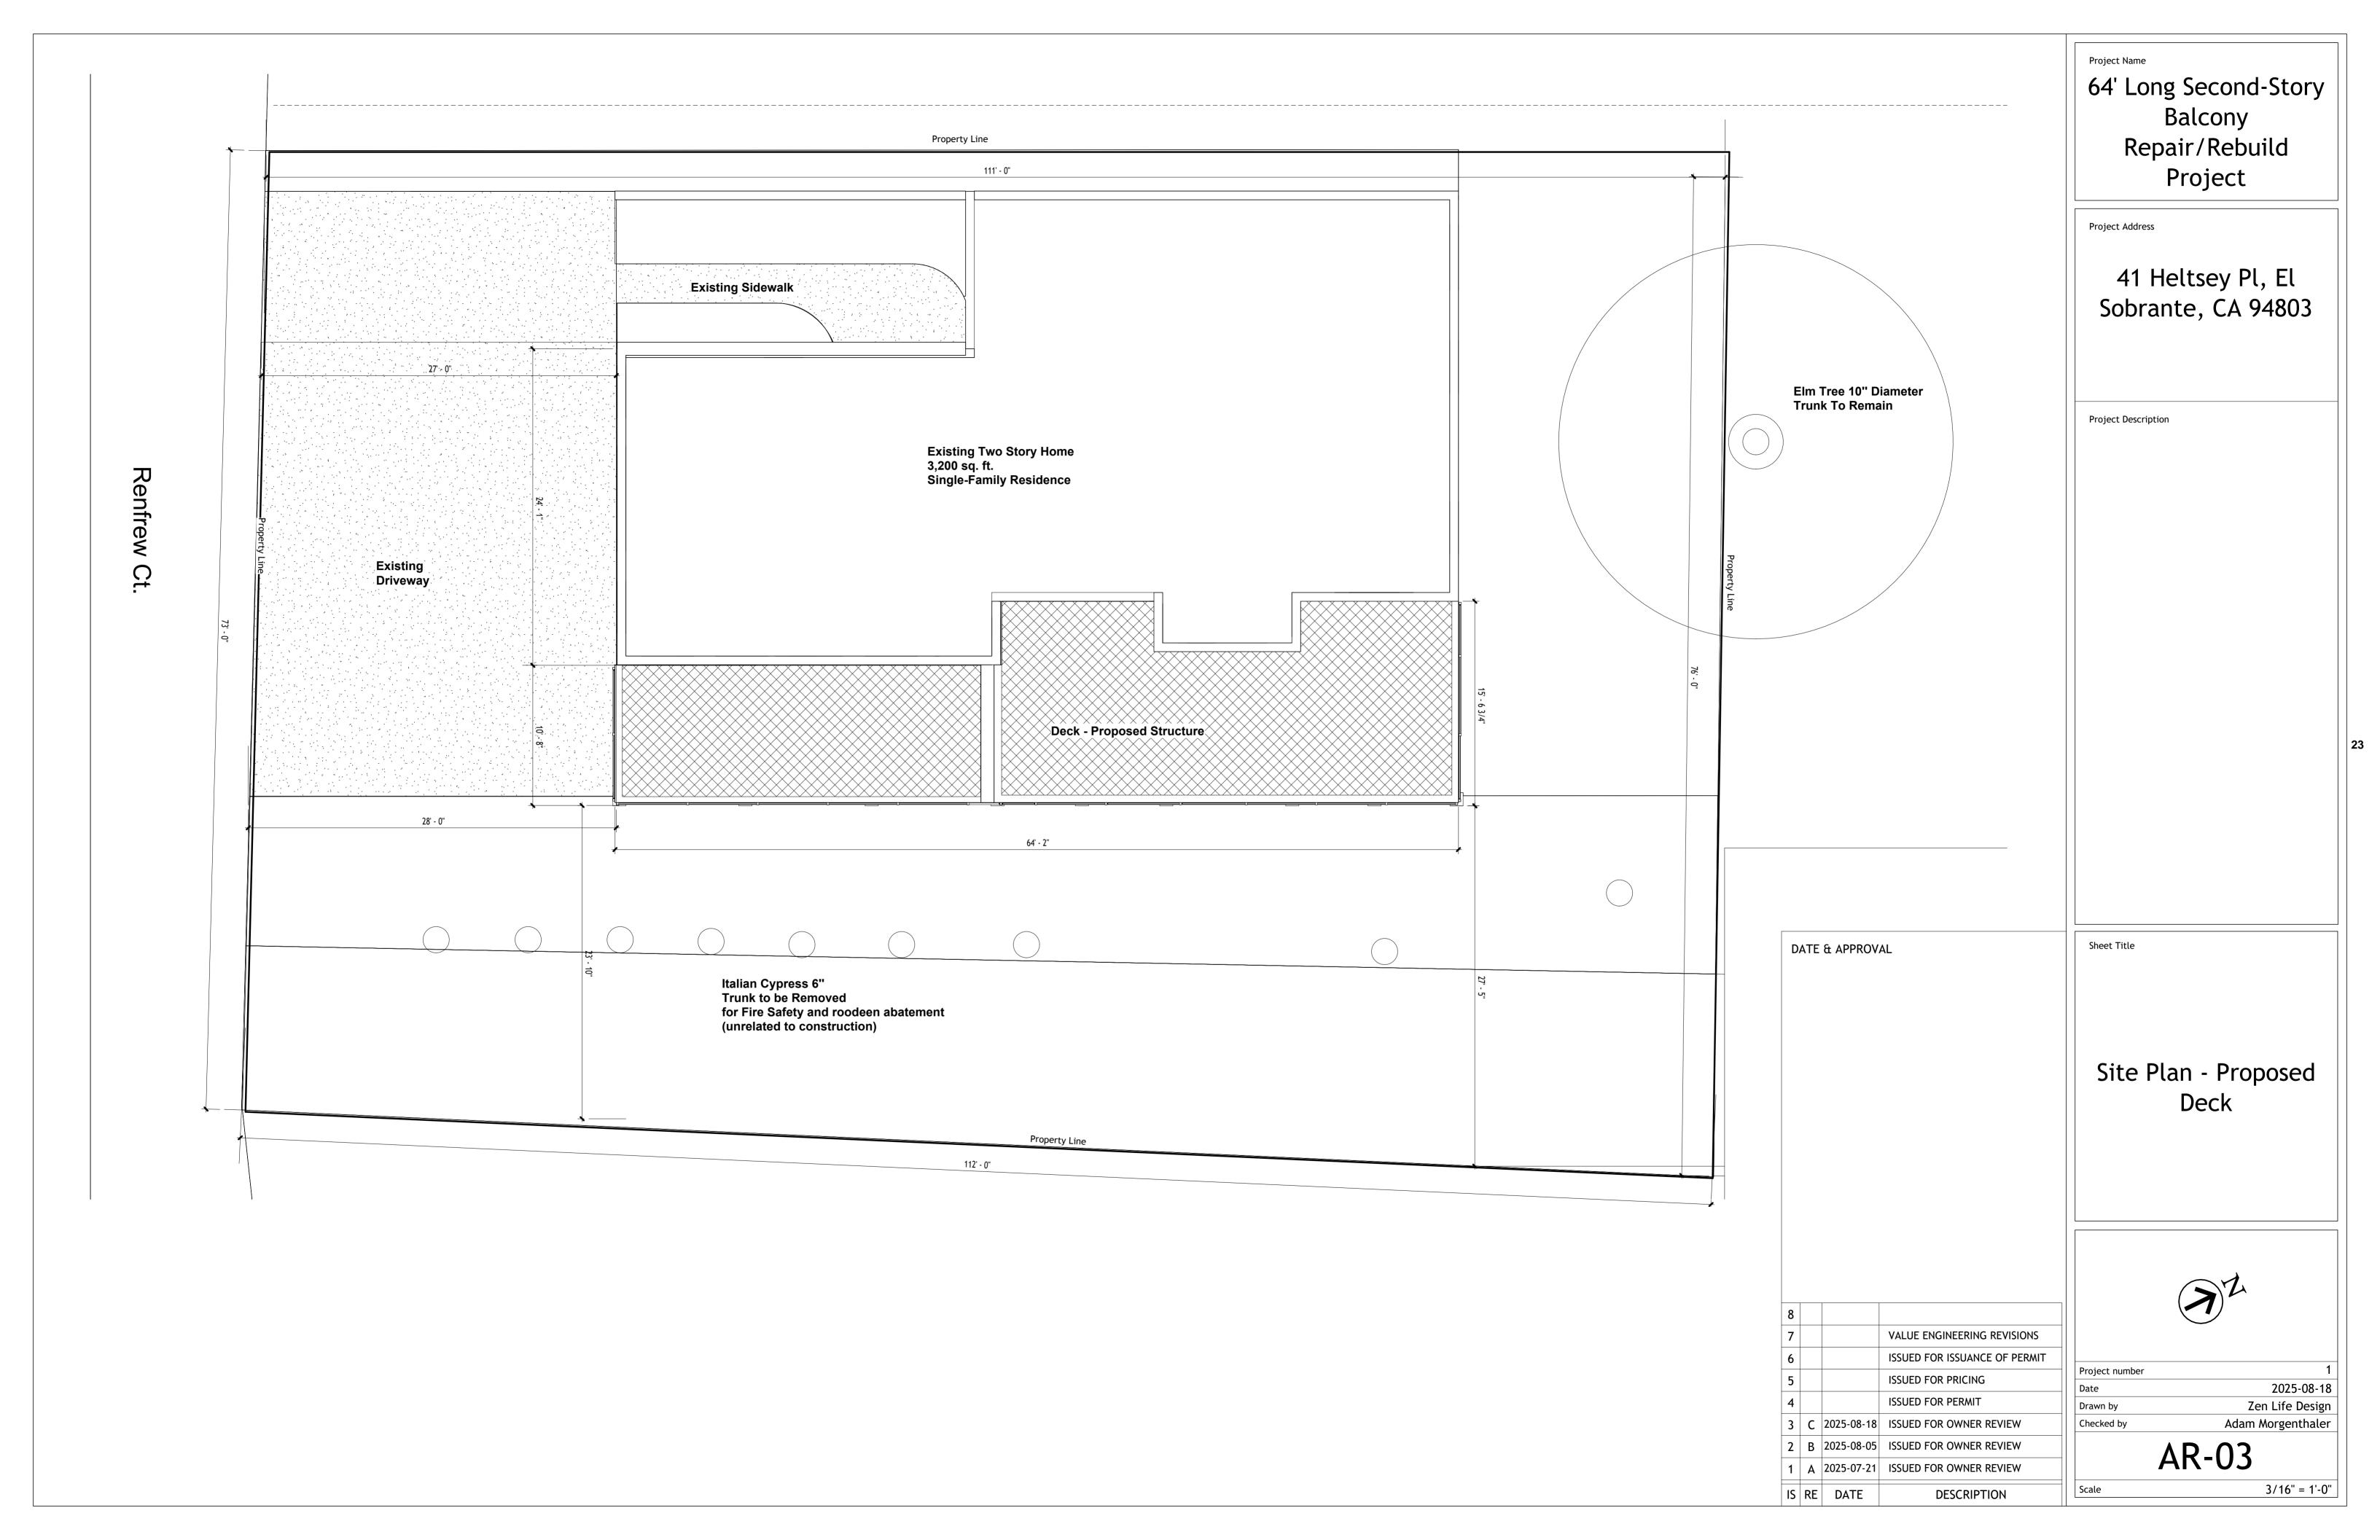

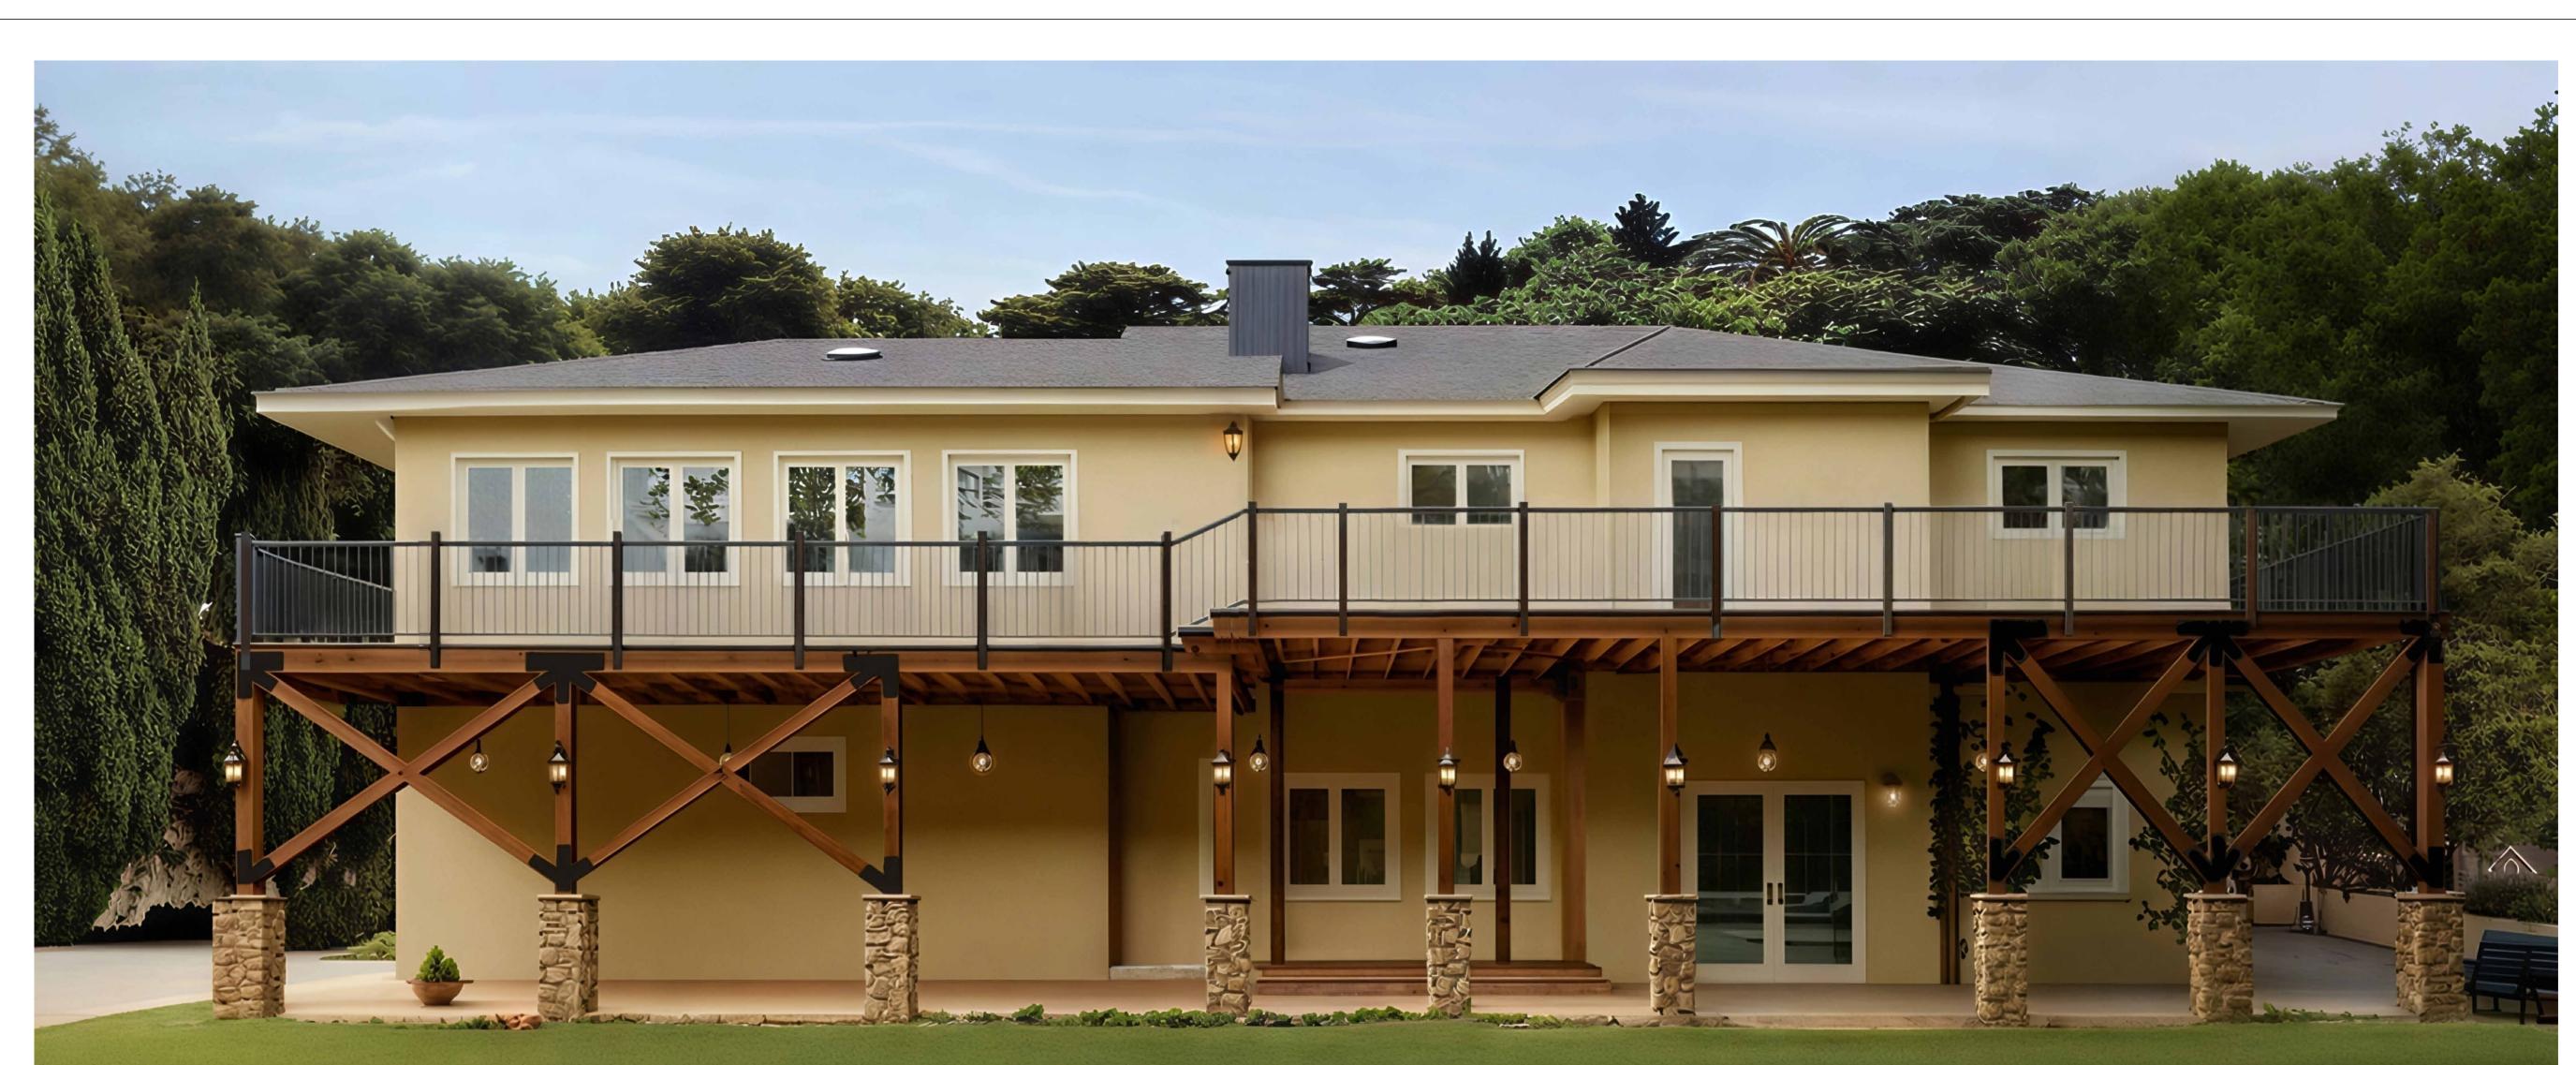


Project Name

64' Long Second-Story
Balcony
Repair/Rebuild
Project

Project Address

41 Heltsey Pl, El Sobrante, CA 94803

Project Description

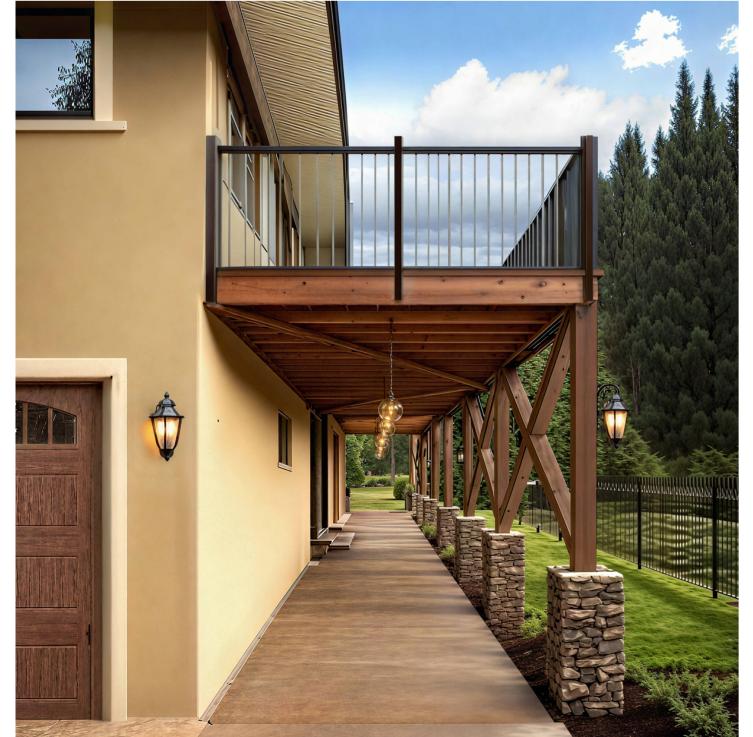



DATE & APPROVAL

3D VISUALIZATION -

Proposed Deck

Sheet Title

8			
7			VALUE ENGINEERING REVISIONS
6			ISSUED FOR ISSUANCE OF PERMIT
5			ISSUED FOR PRICING
4			ISSUED FOR PERMIT
3	С	2025-08-18	ISSUED FOR OWNER REVIEW
2	В	2025-08-05	ISSUED FOR OWNER REVIEW
1	Α	2025-07-21	ISSUED FOR OWNER REVIEW
IS	RE	DATE	DESCRIPTION

Project number 1

Date 2025-08-18

Drawn by Author

Checked by Checker

AR-04



Project Name

64' Long Second-Story
Balcony
Repair/Rebuild
Project

Project Address

41 Heltsey Pl, El Sobrante, CA 94803

Project Description


DATE & APPROVAL

Sheet Title

3D VISUALIZATION -Proposed Deck

3			
7			VALUE ENGINEERING REVISIONS
)			ISSUED FOR ISSUANCE OF PERMIT
5			ISSUED FOR PRICING
1			ISSUED FOR PERMIT
3	С	2025-08-18	ISSUED FOR OWNER REVIEW
<u>-</u>	В	2025-08-05	ISSUED FOR OWNER REVIEW
	Α	2025-07-21	ISSUED FOR OWNER REVIEW
S	RE	DATE	DESCRIPTION

Project number	1
Date	2025-08-18
Drawn by	Author
Checked by	Checker
AR-05	
	Date Drawn by Checked by

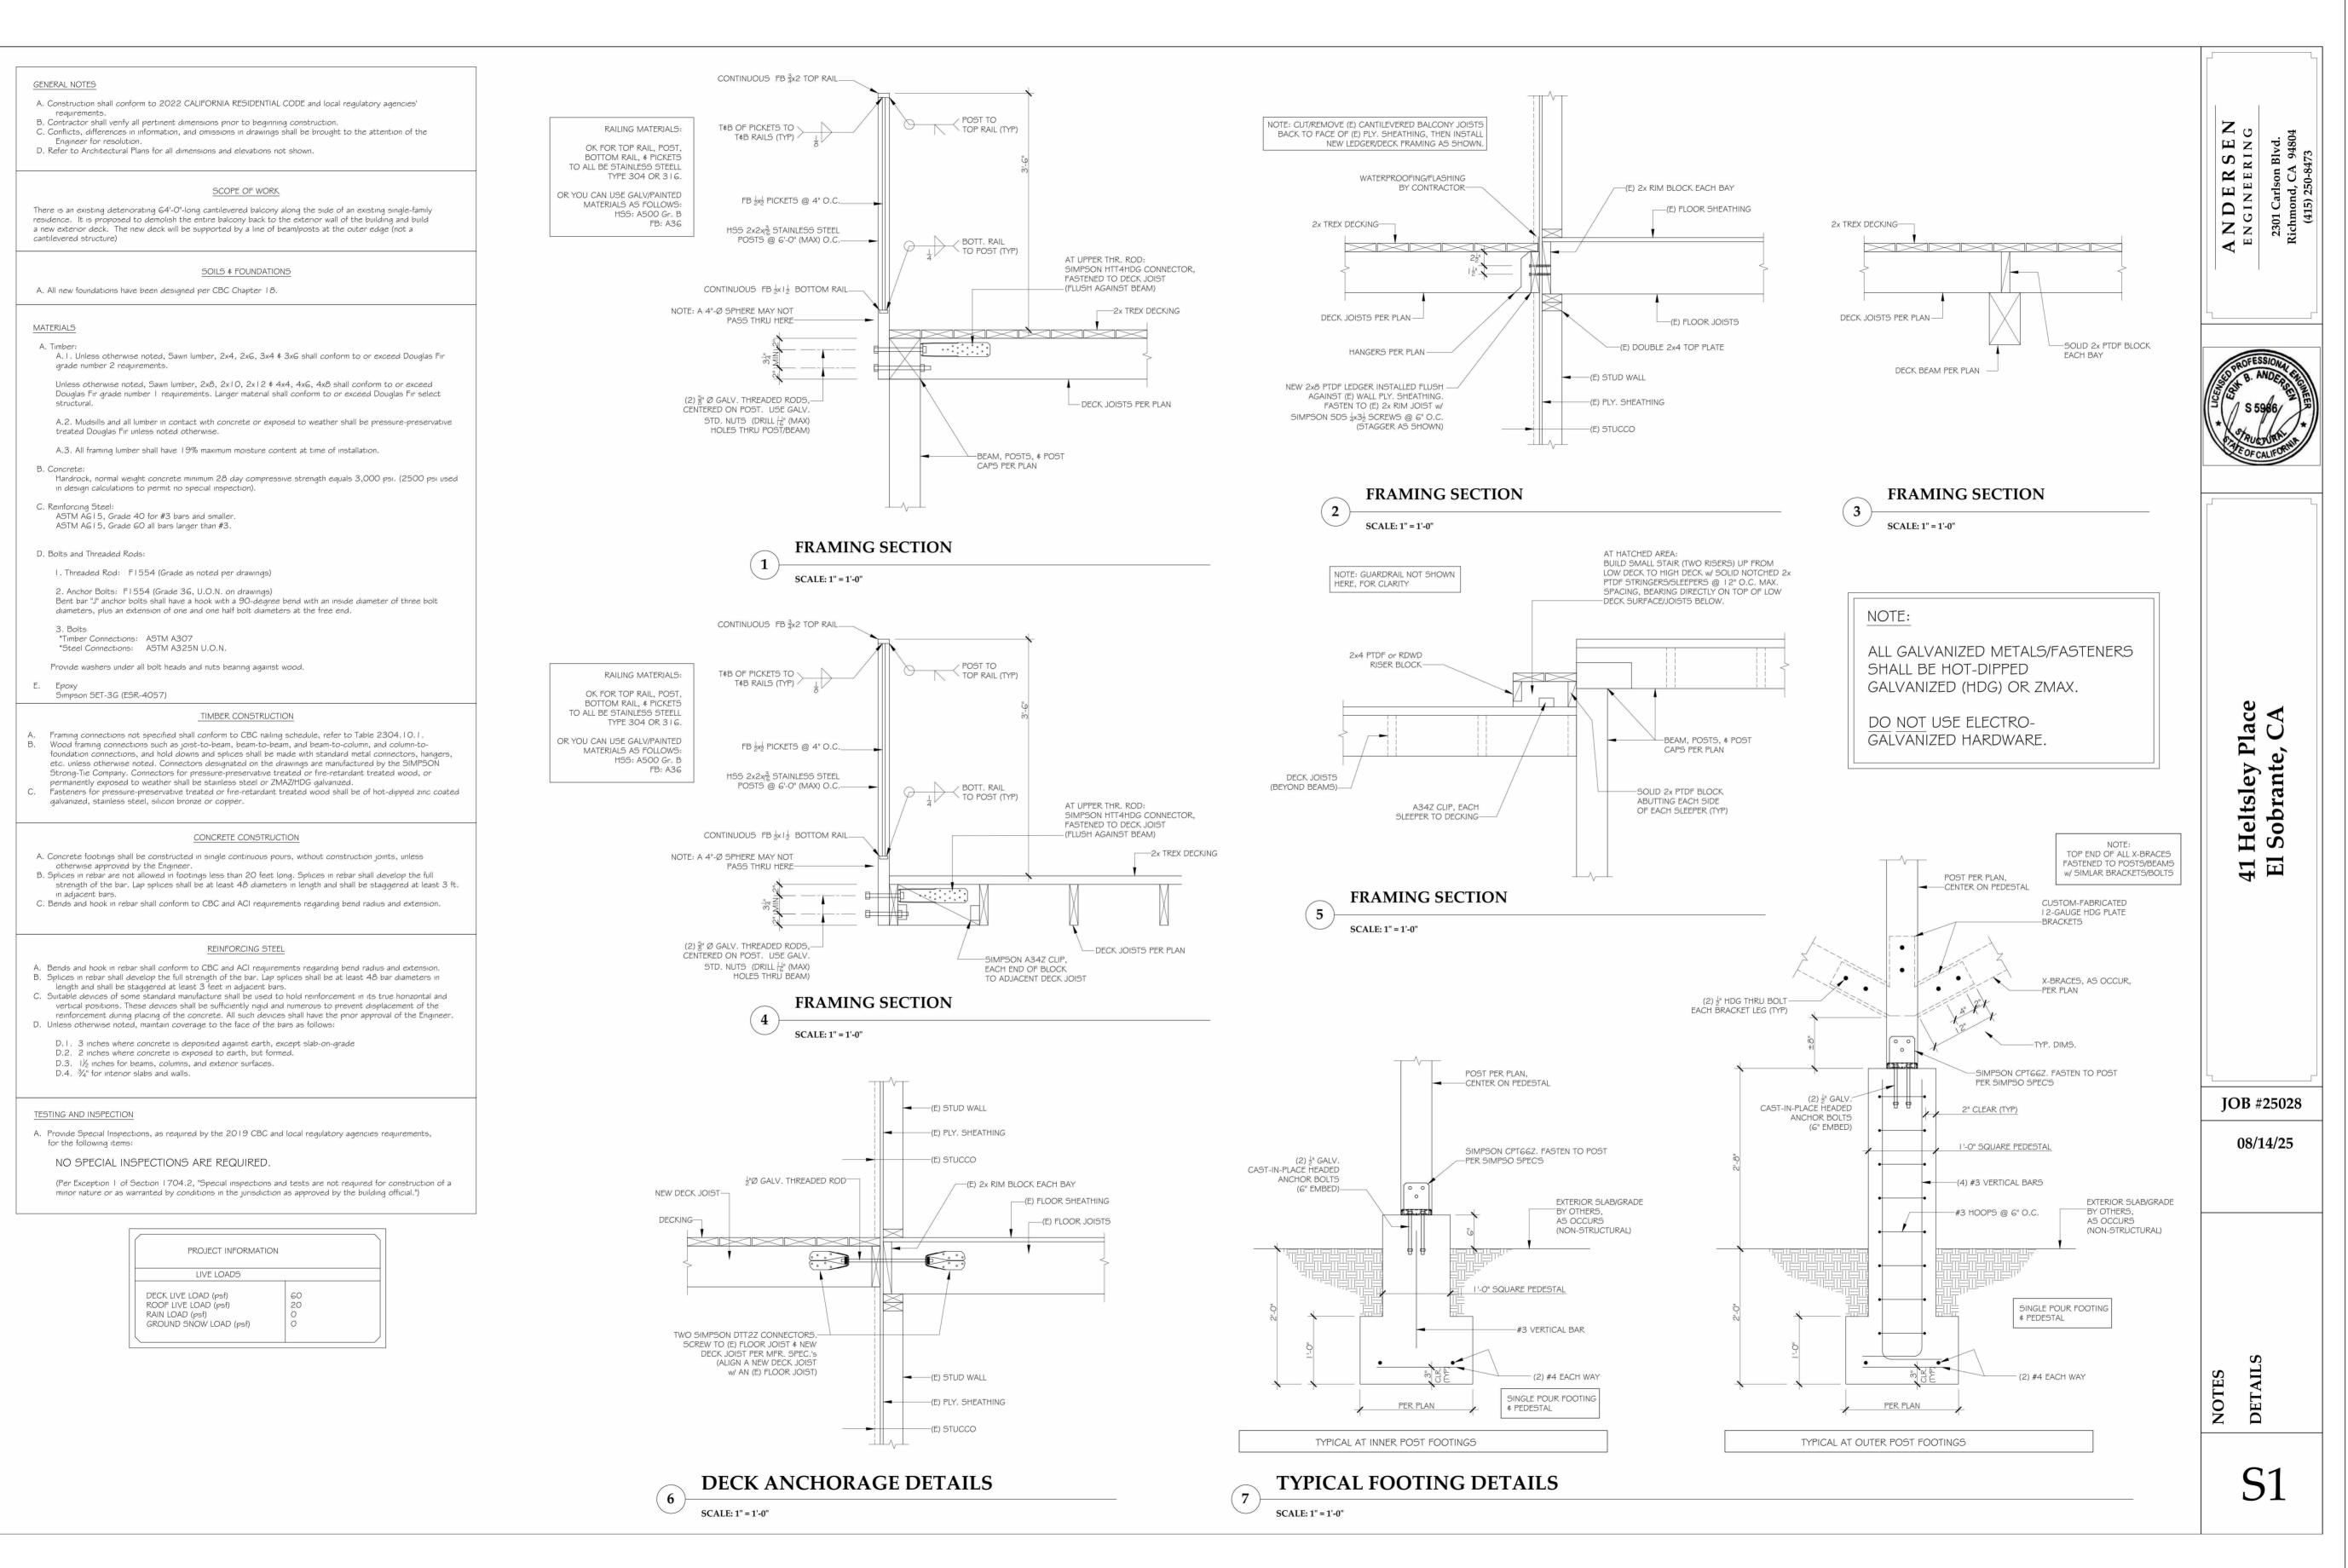

Project Name 64' Long Second-Story Balcony Repair/Rebuild Project

Project Address

41 Heltsey Pl, El Sobrante, CA 94803

Project Description

Sheet Title


Scale

Structural Engineer **Drawings S1**

26

Project number 2025-08-18 Date Drawn by Andersen Engineering Adam Morgenthaler Checked by

S-01

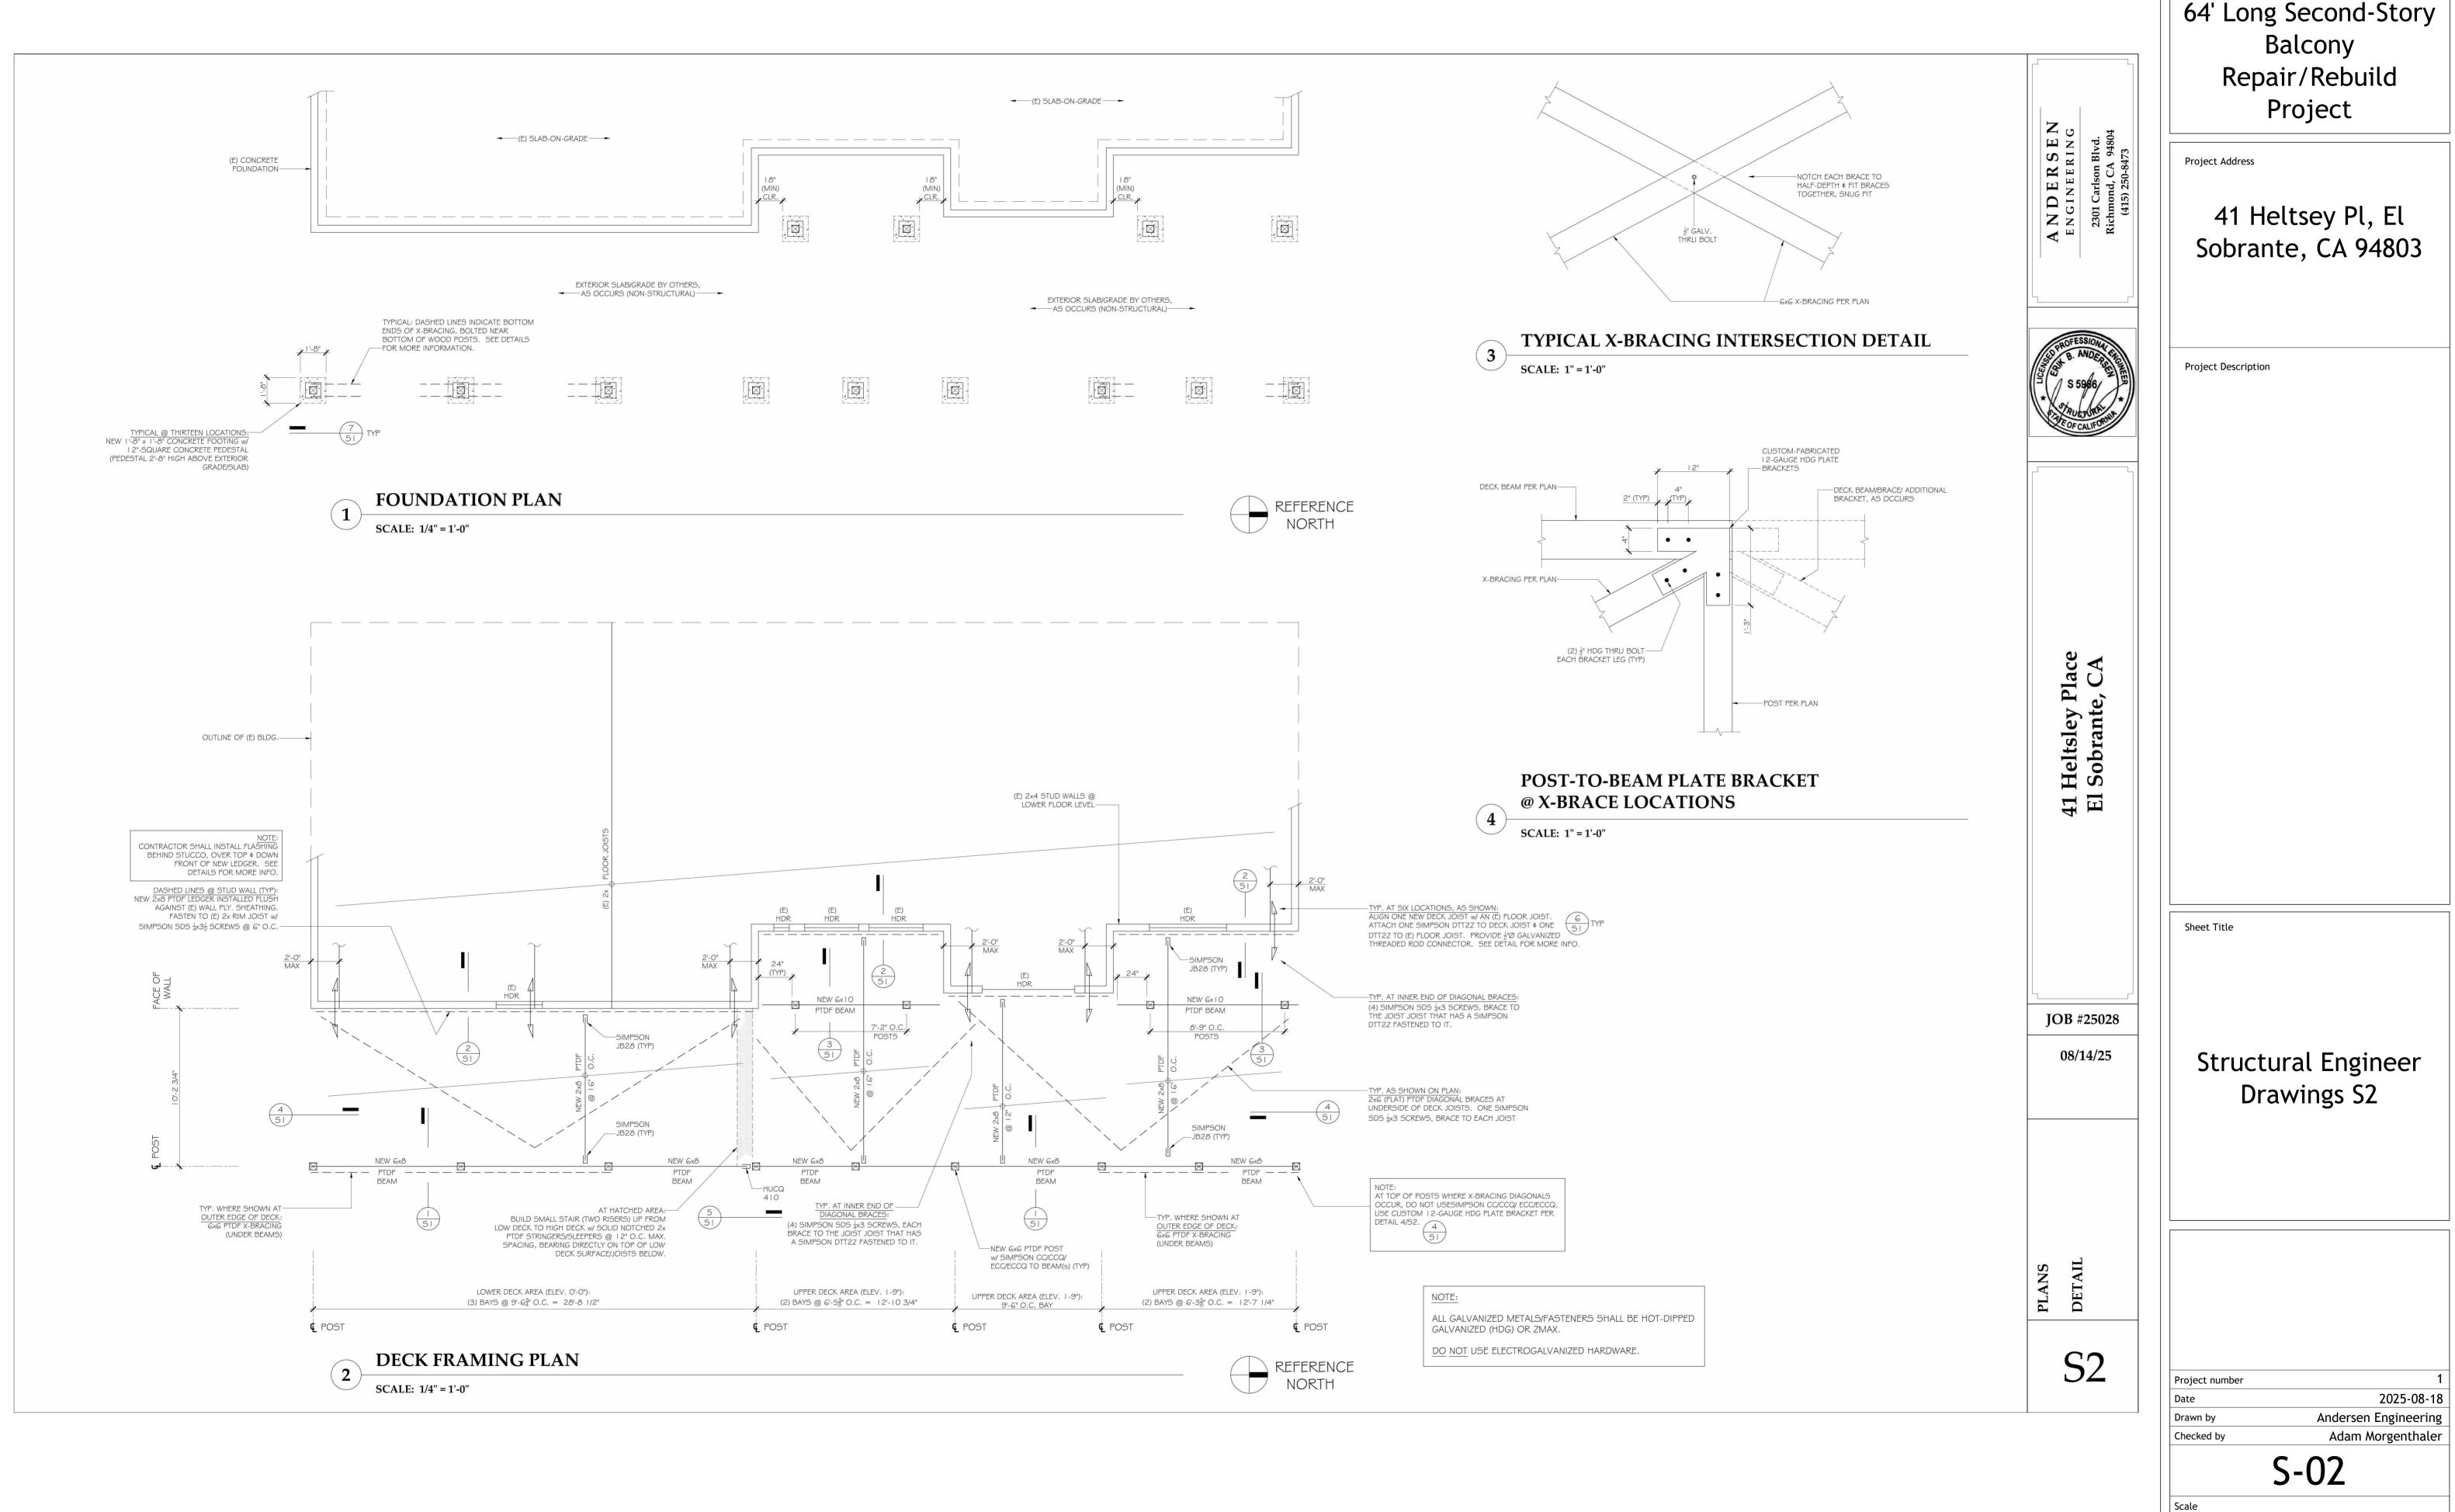

Project Name 64' Long Second-Story Date = Job No. 14-Aug-25 25028


41 Heltsley Place, El Sobrante, CA New/Replacement Exterior Deck

Loads: **Exterior Deck** Dead Loads =

2x Decking framing

5 psf 3 psf

Total (psf) 8.0 psf Live Load (psf) 60 psf

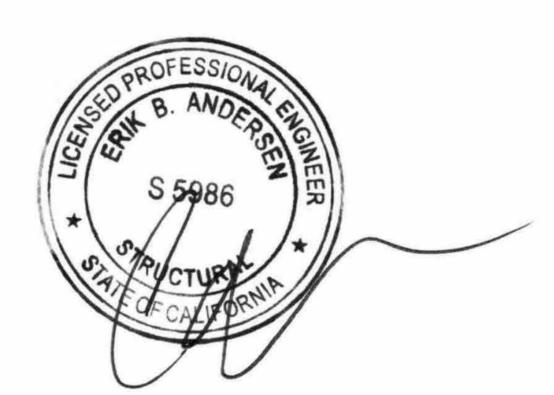

41 Heltsley Place, El Sobrante, CA

							Job No.		25028
Beam Type	Туре		Fb (ksi)	Fv (ksi)	E (ksi)	Fc // (ksi)	Fc (ksi)	EC (ksi)	pcf
Doug Fir #1		1	varies	varies	1700	0.925		1600	36
Doug Fir #2		2	varies	varies	1600	0.925		1600	36
GLULAM (24F-V4)		3	2.40	0.265	1800	1.65		1600	36
PSL Parallam 2.0E		4	2.90	0.29	2000	0.5	0.	75 1000	45
Steel		5	23.76	14.40	29000	22		22000	490
LVL Microllam 1.9E		6	2.6	0.285	1900	2.51	0.7	75	41.5
LSL TimberStrand 1.558	1	7	2.325	0.31	1550	2.05	0	.8	44
TJI		8	varies	varies	varies				
RFPI		9	varies	varies	varies				
Note: Fb values for 2x m	naterial includ	e 1.15 repe	titive member fact	or.					

	Beam No from				Multiple	
Beam Ref on plans	table	Beam Name	Length (ft)	Length (in)	per el	
F1 - deck joist	3	2x08 no1	10	120	1	
LOADS	Uniform loads (plf)				Point Load from	Left (k)
Self Weight	2.7			Distance (ft)		
DL	11.0	=8(1.33')	Ci=	DL		
L	80.0	=60(1.33')	0.80	LL		
Total	93.7			Total	0.0	
PROPERTIES	Beam Type	1	E (ksi)	1700.00	a (in)	0
	lx (in4)	48	Depth (in)	7.25	b (in)	120
	Sx (in3)	13	A (in2)	11	10 10 10 10 10 10 10 10 10 10 10 10 10 1	
REACTIONS (k)		Left	Right			
	DL	0.07	0.07			
	LL	0.40	0.40			
	Total	0.47	0.47	Fv (ksi)	fv (ksi)	
SHEAR (k)	Total (k)	0.41	0.41	0.180	0.057	< Fv pass
MOMENT (in-k)	Uniform	Point Load Max	Total	Fb (ksi)	fb (ksi)	
Moment (in-k)	14.06	0	14.06	1.10	1.07	< Fb pass
DEFLECTION (in)	Δ TL (in)	0.260	L/in TL	461		pass > 240
	Δ LL (in)	0.222	L/in LL	540		pass > 360

Project Name

64' Long Second-Story Balcony Repair/Rebuild Project

Project Address

41 Heltsey Pl, El Sobrante, CA 94803

Project Description

Sheet Title

Structural Engineer Calculations Sheets

Project number

2025-08-18 Andersen Engineering Adam Morgenthaler

S-03

41 Heltsley Place, El Sobrante, CA

Job No.

25028

	Beam No from				Multiple	
Beam Ref on plans	table	Beam Name	Length (ft)	Length (in)	Members	
F2 - deck beam	. 14	6x08 no1	9.5	114		1
LOADS	Uniform loads (plf)				Point Load from	n Left (k)
Self Weight	10.3			Distance (ft)		
DL	40.0	=8(5')	Ci=	DL		
LL	300.0	=60(5')	0.80	LL		
Total	350.3			Total	0.0	
PROPERTIES	Beam Type	1	E (ksi)	1600.00	a (in)	0
	lx (in4)	193	Depth (in)	7.50	b (in)	114
	Sx (in3)	52	A (in2)	41		
REACTIONS (k)		Left	Right			_
	DL	0.24	0.24			
	LL	1.43	1.43			
	Total	1.66	1.66	Fv (ksi)	fv (ksi)	
SHEAR (k)	Total (k)	1.45	1.45	0.170	0.053	< Fv pass
MOMENT (in-k)	Uniform	Point Load Max	Total	Fb (ksi)	fb (ksi)	
Moment (in-k)	47.42	0	47.42	0.96	0.92	< Fb pass
DEFLECTION (in)	ΔTL (in)	0.208	L/in TL	549		pass > 240
	Δ LL (in)	0.178	L/in LL	641		pass > 360

	Beam No from				Multiple	
Beam Ref on plans	table	Beam Name	Length (ft)	Length (in)	Members	
F3 - deck beam	15	6x10 no1	10	120		1
LOADS	Uniform loads (plf)				Point Load from	n Left (k)
Self Weight	13.1			Distance (ft)		
DL	60.0	=8(7.5')	Ci=	DL		
LL	450.0	=60(7.5')	0.80	LL		
Total	523.1			Total	0.0	
PROPERTIES	Beam Type	1	E (ksi)	1600.00	a (in)	0
	1x (in4)	393	Depth (in)	9.50	b (in)	120
	Sx (in3)	83	A (in2)	52	The second district of the second second	
REACTIONS (k)		Left	Right			_
	DL	0.37	0.37			
	LL	2.25	2.25			
	Total	2.62	2.62	Fv (ksi)	fv (ksi)	
SHEAR (k)	Total (k)	2.20	2.20	0.170	0.063	< Fv pass
MOMENT (in-k)	Uniform	Point Load Max	Total	Fb (ksi)	fb (ksi)	
Moment (in-k)	78.46	0	78.46	1.08	0.95	< Fb pass
DEFLECTION (in)	Δ TL (in)	0.187	L/in TL	641		pass > 240
	Δ LL (in)	0.161	L/in LL	745		pass > 360

CONSIDER A 24" (MAX) BEAM CANTILEVER: $M = (44 \#/in)(24'')^2(\frac{1}{2})$ = 12672 #in $F_b = \frac{12672 \#in}{83 in^3}$ = 152 pri = 1080 pri



PROJECT PAGE CLIENT **DESIGN BY** JOB NO. DATE: **REVIEW BY** Wood Post, Wall Stud, or King Stud Design Based on NDS INPUT DATA **DESIGN SUMMARY** USE: 1 - 4" x 4" DOUGLAS FIR-LARCH No. 2 Effective Length (NDS 3.7) Le x-x = 11 ft, (strong axis bending) 1. CHECK VERTICAL LOADS: fc < Fc'? Le y-y = 11 ft, (weak axis bending) 273 psi < [Satisfactory] $P_{DL} = 480$ lbs AXIAL LOAD 2. CHECK BENDING LOADS: fb < Fb' ? P_{LL} = 2860 lbs P = 3,340 lbs 0 psi < [Satisfactory] LATERAL LOAD w = 0 plf $\left(\frac{f_c}{F_c}\right)^2 + \left(\frac{1}{1 - f_c/F_{cEx}}\right) \frac{f_{bx}}{F_{bx}} \le 1$ 3. CHECK INTERACTION lbs, at ft, from bottom Max Section M = 0 ft-lbs, at 11.00 ft from bottom 0.732 [Satisfactory] Max Section V = 0 s, at top end SPECIES (1 = DFL, 2 = SP, 3 = LSL, 4 = PSL) 1 DOUGLAS FIR-LARCH 4. CHECK SHEAR LOADS: f_v < F_v'? GRADE (1, 2, 3, 4, 5, or 6) 4 No. 2 0 psi < 180 psi [Satisfactory] SECTION 1 pcs, b = 4 in 5. MAXIMUM HORIZONTAL DEFLECTION 0.00 WET / DRY ? (1 = DRY, 2 = WET) 1 DRY ANALYSIS COLUMN BASIC DESIGN STRESSES: COMPRESSIVE STRESS $F_c = 1350$ psi MODULUS OF ELASTICITY BENDING STRESS (X-Axis) SHEAR STRESS (X-Axis) $F_V = 180$ psi COLUMN PROPERTIES: STANDARD DRESSED SIZE dy = 3.50 in dx = 3.50 in $A = 12.25 \text{ in}^2$ SECTION PROPERTIES Abt. x-x LENGTH-DEPTH RATIO Le x-x / dy = 37.7Le y-y / dx = 37.7ADJUSTMENT FACTORS: E, DURATION (NDS 2.3.2) MODULUS OF ELASTICITY E'_{min} = 580 ksi MOISTURE FACTOR 1.00 COLUMN PARAMETER c = 0.80TEMPERATURE FACTOR R_B = N/A 1.00 BEAM PARAMETER INCISING FACTOR 1.00 1.00 1.00 SIZE FACTOR 1.15 **BUCKLING VALUES** F_{CE} = 335 psi FLAT USE FACTOR $F_{bE} = N/A$ $F_b = N/A$ **COLUMN STABILITY** 0.205 $F_c^* = 1553$ psi REPETITIVE (1.15 or 1.0) 1.00 BEAM STABILITY ADJUSTED PROPERTIES: F_c' = 319 psi MODULUS OF ELASTICITY E' = 1600 ksi **AXIAL STRESS** F_{bx}' = 1350 psi F_v' = 180 psi BENDING STRESS (X-Axis) SHEAR STRESS ACTUAL STRESSES: **AXIAL STRESS** $f_{\rm C} = 272.7$ psi SHEAR STRESS $f_V = 0$ psi BENDING STRESSES $f_{bx} = 0.0$ psi

Project Name 64' Long Second-Story

Balcony Repair/Rebuild Project

Project Address

41 Heltsey Pl, El Sobrante, CA 94803

Project Description

Sheet Title

Structural Engineer **Calculations Sheets**

Project number

2025-08-18 Andersen Engineering Drawn by Adam Morgenthaler

S-04

Scale

Andersen Engineering

2301 Carlson Blvd. Richmond, CA 94804 (415) 250-8473

JOB # 25028

TYPICAL FOOTING - SOIL BELLEUNG

Andersen Engineering

2301 Carlson Blvd. Richmond, CA 94804 (415) 250-8473

JOB # 25028

TYPICHE DECK LEDGER CONVECTION

NEW WE FIRST LEDGER INSTALLED DIRECTLY AGAINST (=) ZX PUM JOIST. FASTEN W/ SIMPSON 505 4 x 3/2 @ 6" o.c.

$$W_{ALLOW} = (3+60)(5' TELB)$$

$$W_{ALLOW} = (190 \% 505)(\frac{12''}{6''})$$
SOS SCREENS

Andersen Engineering

2301 Carlson Blvd. Richmond, CA 94804 (415) 250-8473

JOB # 25028

STEEL GUATEDRAIL TYP. POST: HSS2×2×1/8 POSTS @ 6-0" (MAK) O.C. M = (0.2k)(42") = 8.4 kin Mn = (0.797 n3)(36 kgi) ACCOUNTS FOR REDUCED SECTION STRENGTH

Fy = 36 kgi (STAINLESS OPTION - TYPE 304 OF 316)

DUE TO BOLT HOLES

TOP RAIL: FB 4x2 M= (0.2 k X72" X4)

ANCHORAGE TO DECK: (2) 1/8" THEU BOLTS C 34" (MIN)
SPACING, THEU POST & PIM TO DECK FRAMING.

Project Name Balcony

64' Long Second-Story Repair/Rebuild Project

Project Address

41 Heltsey Pl, El Sobrante, CA 94803

Project Description

OK


SK-


Structural Engineer **Calculations Sheets** Copy 1


Project number

2025-08-18

Andersen Engineering Adam Morgenthale S-05

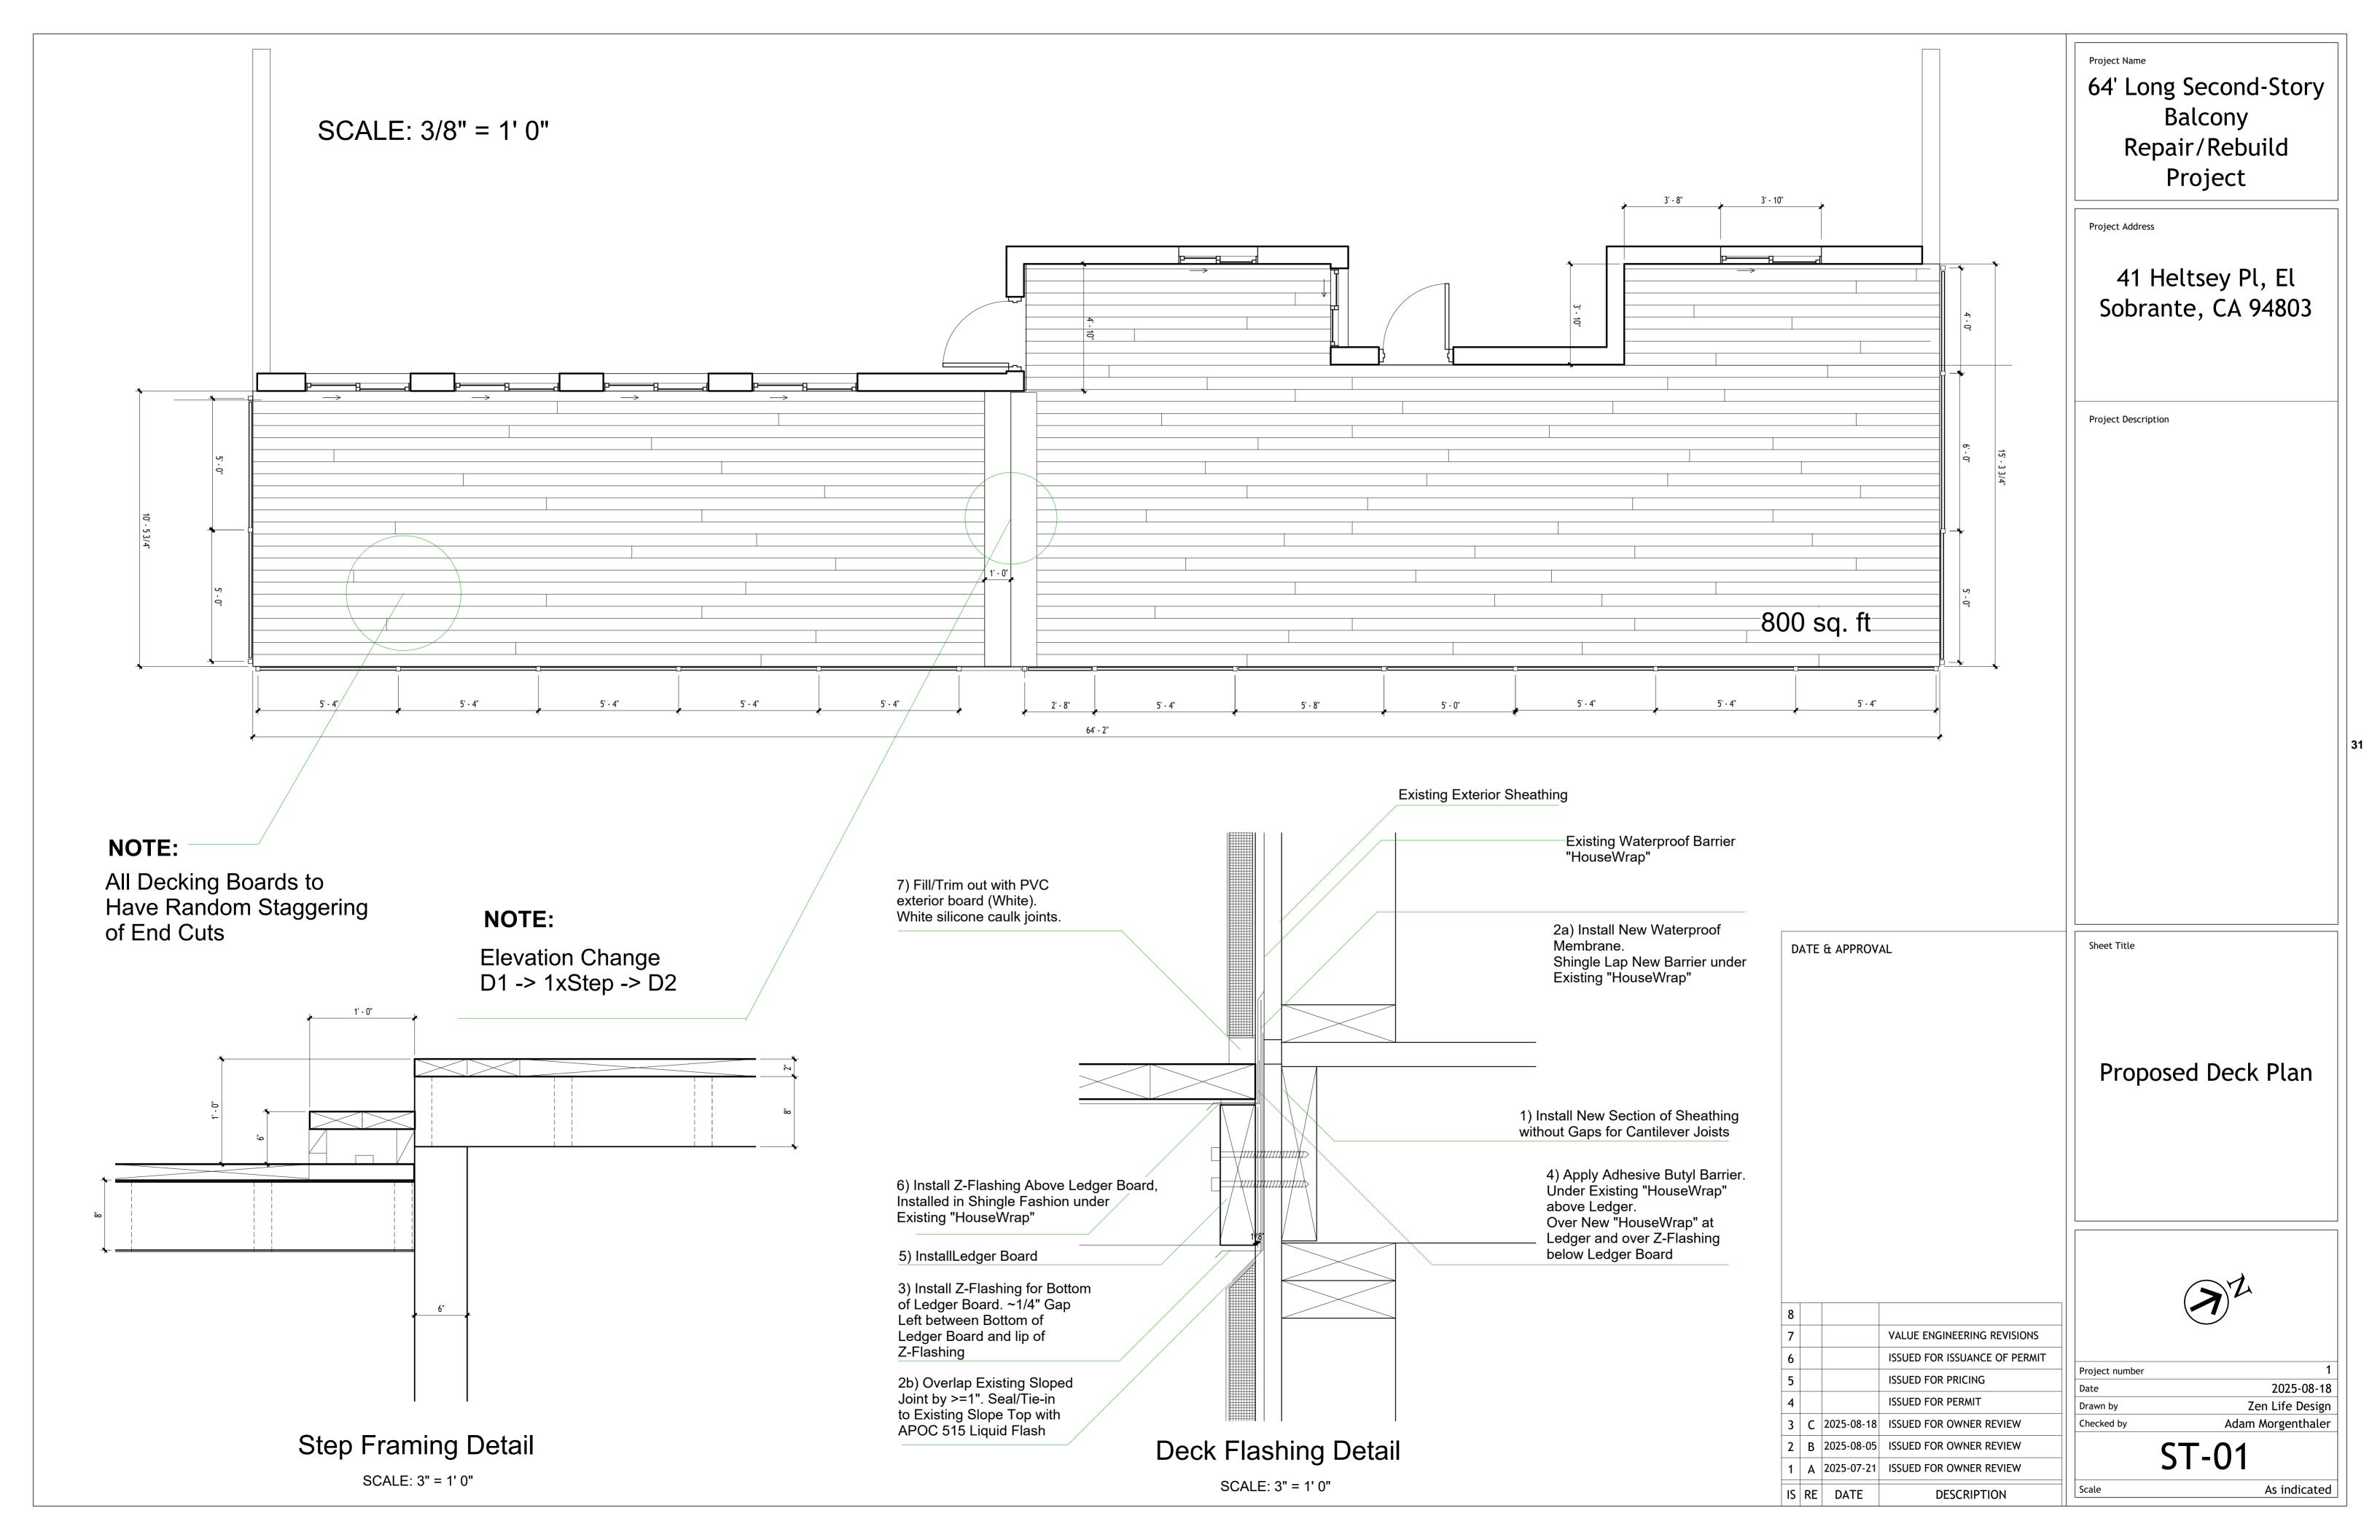

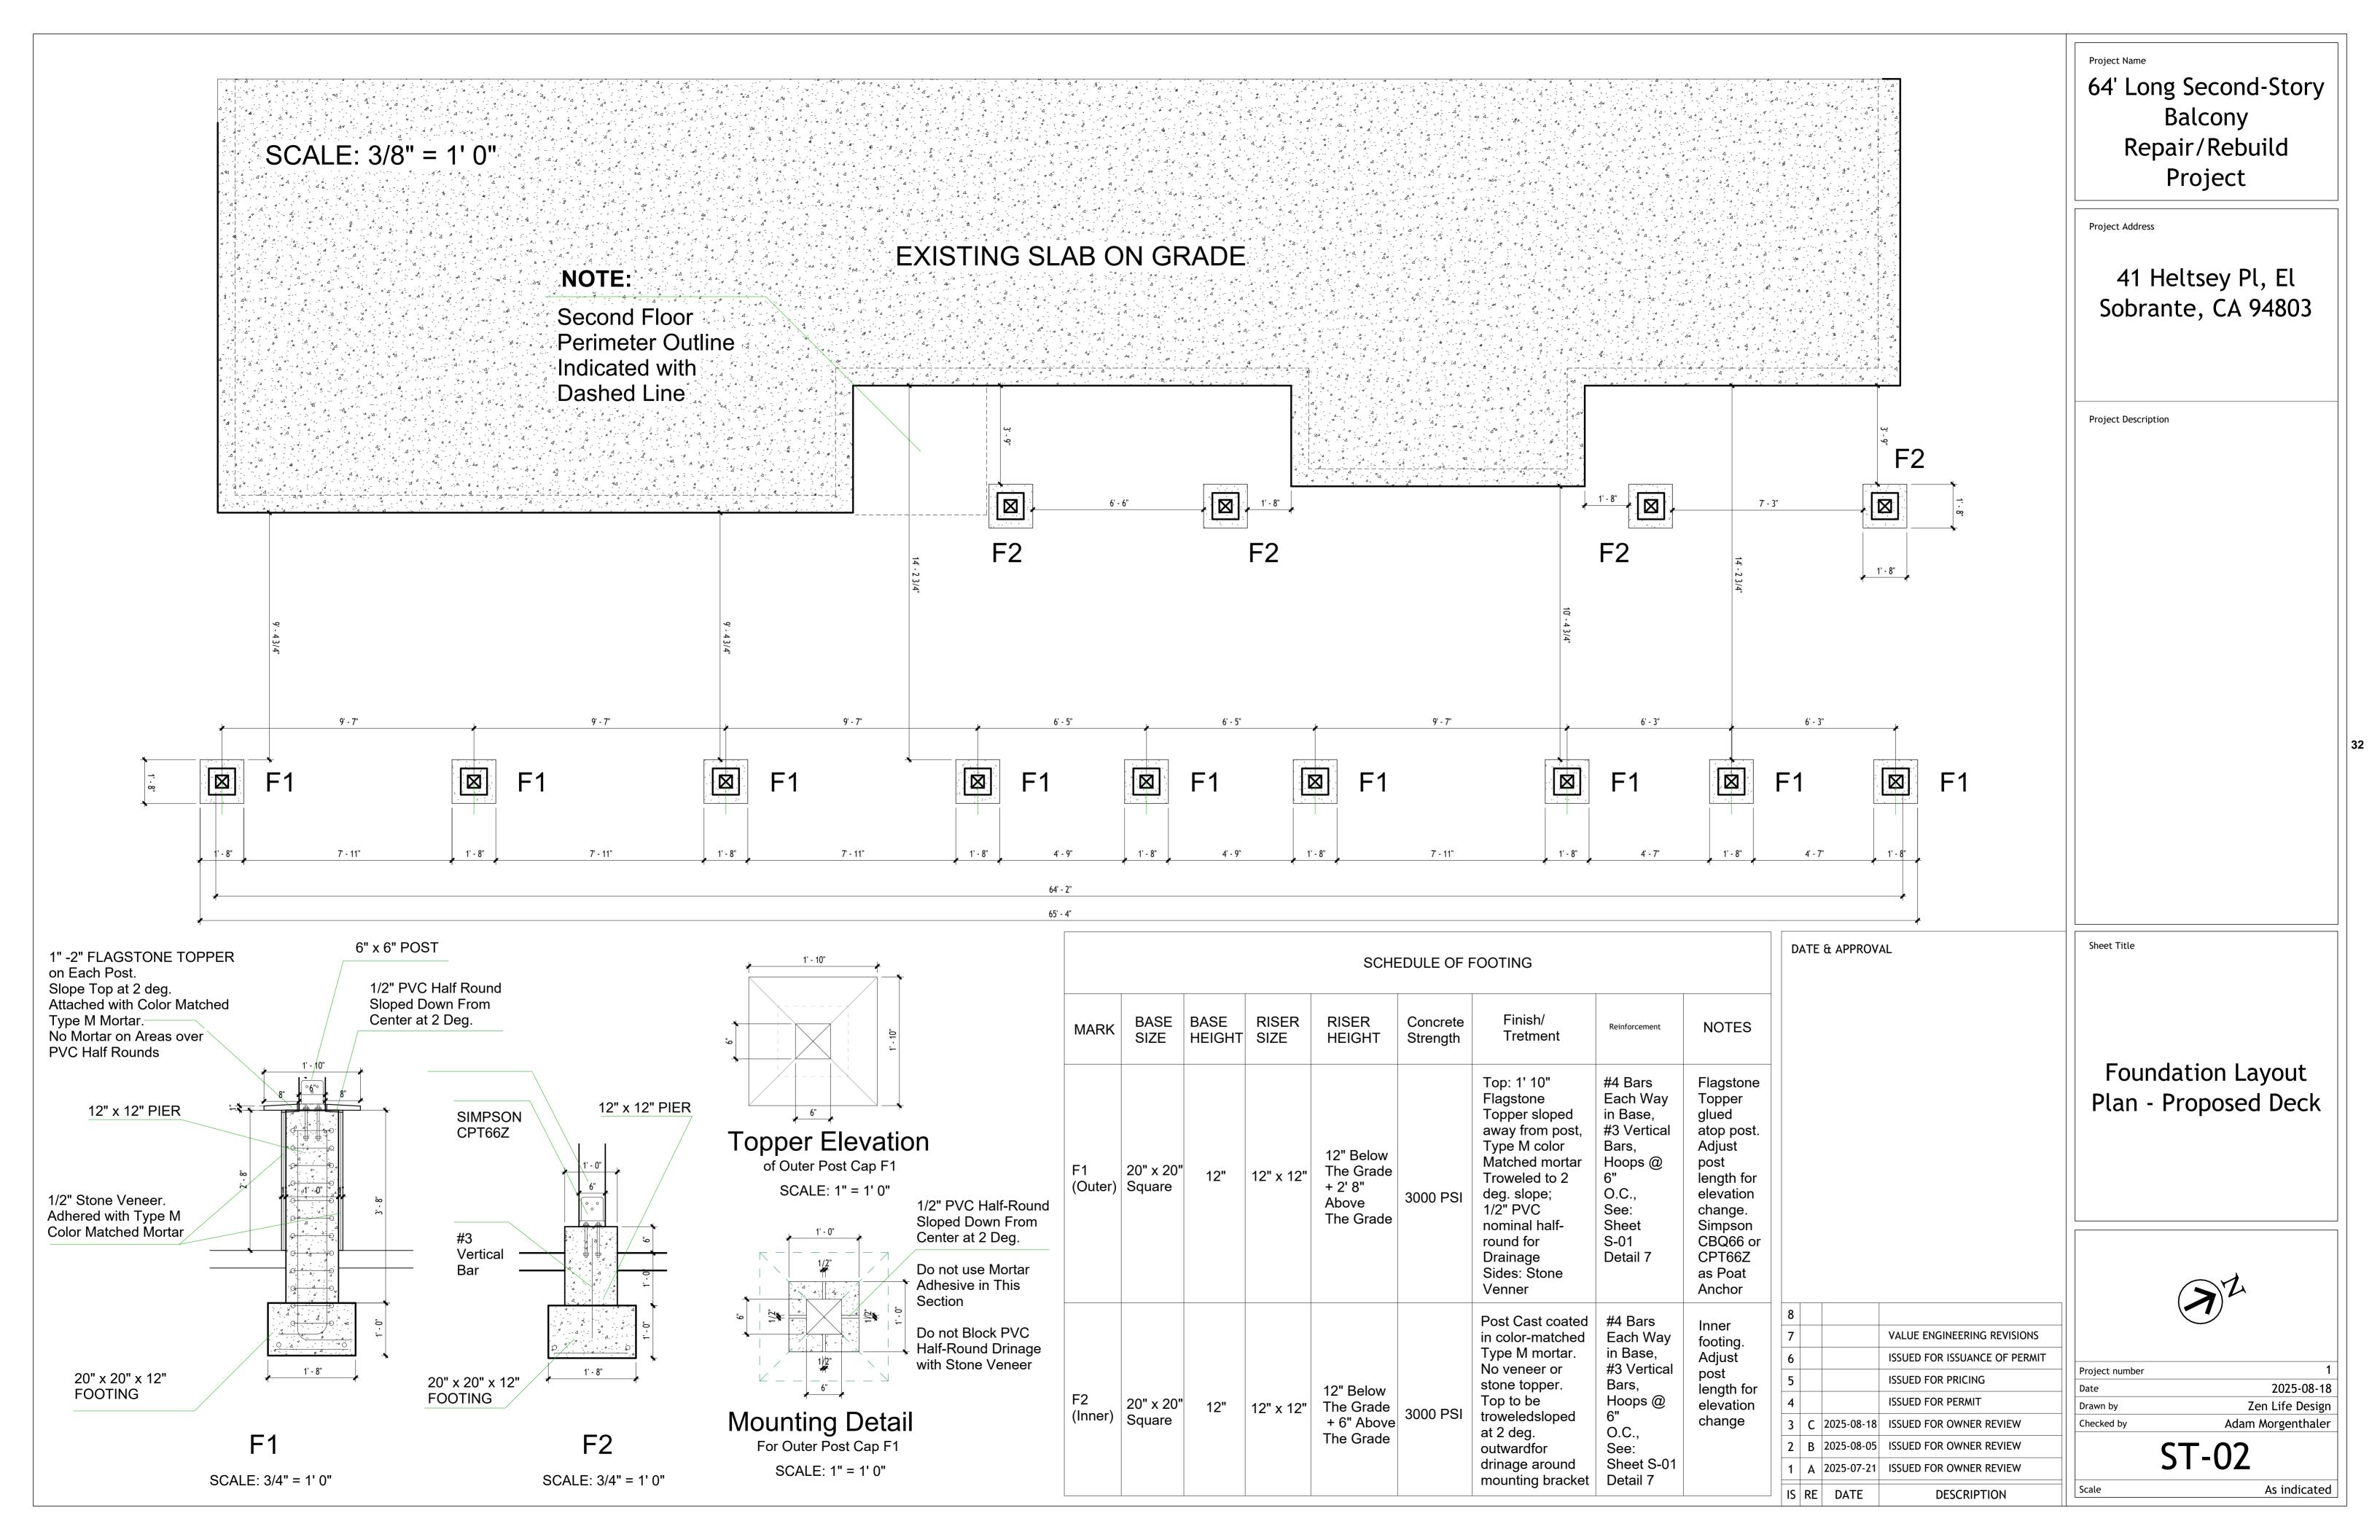

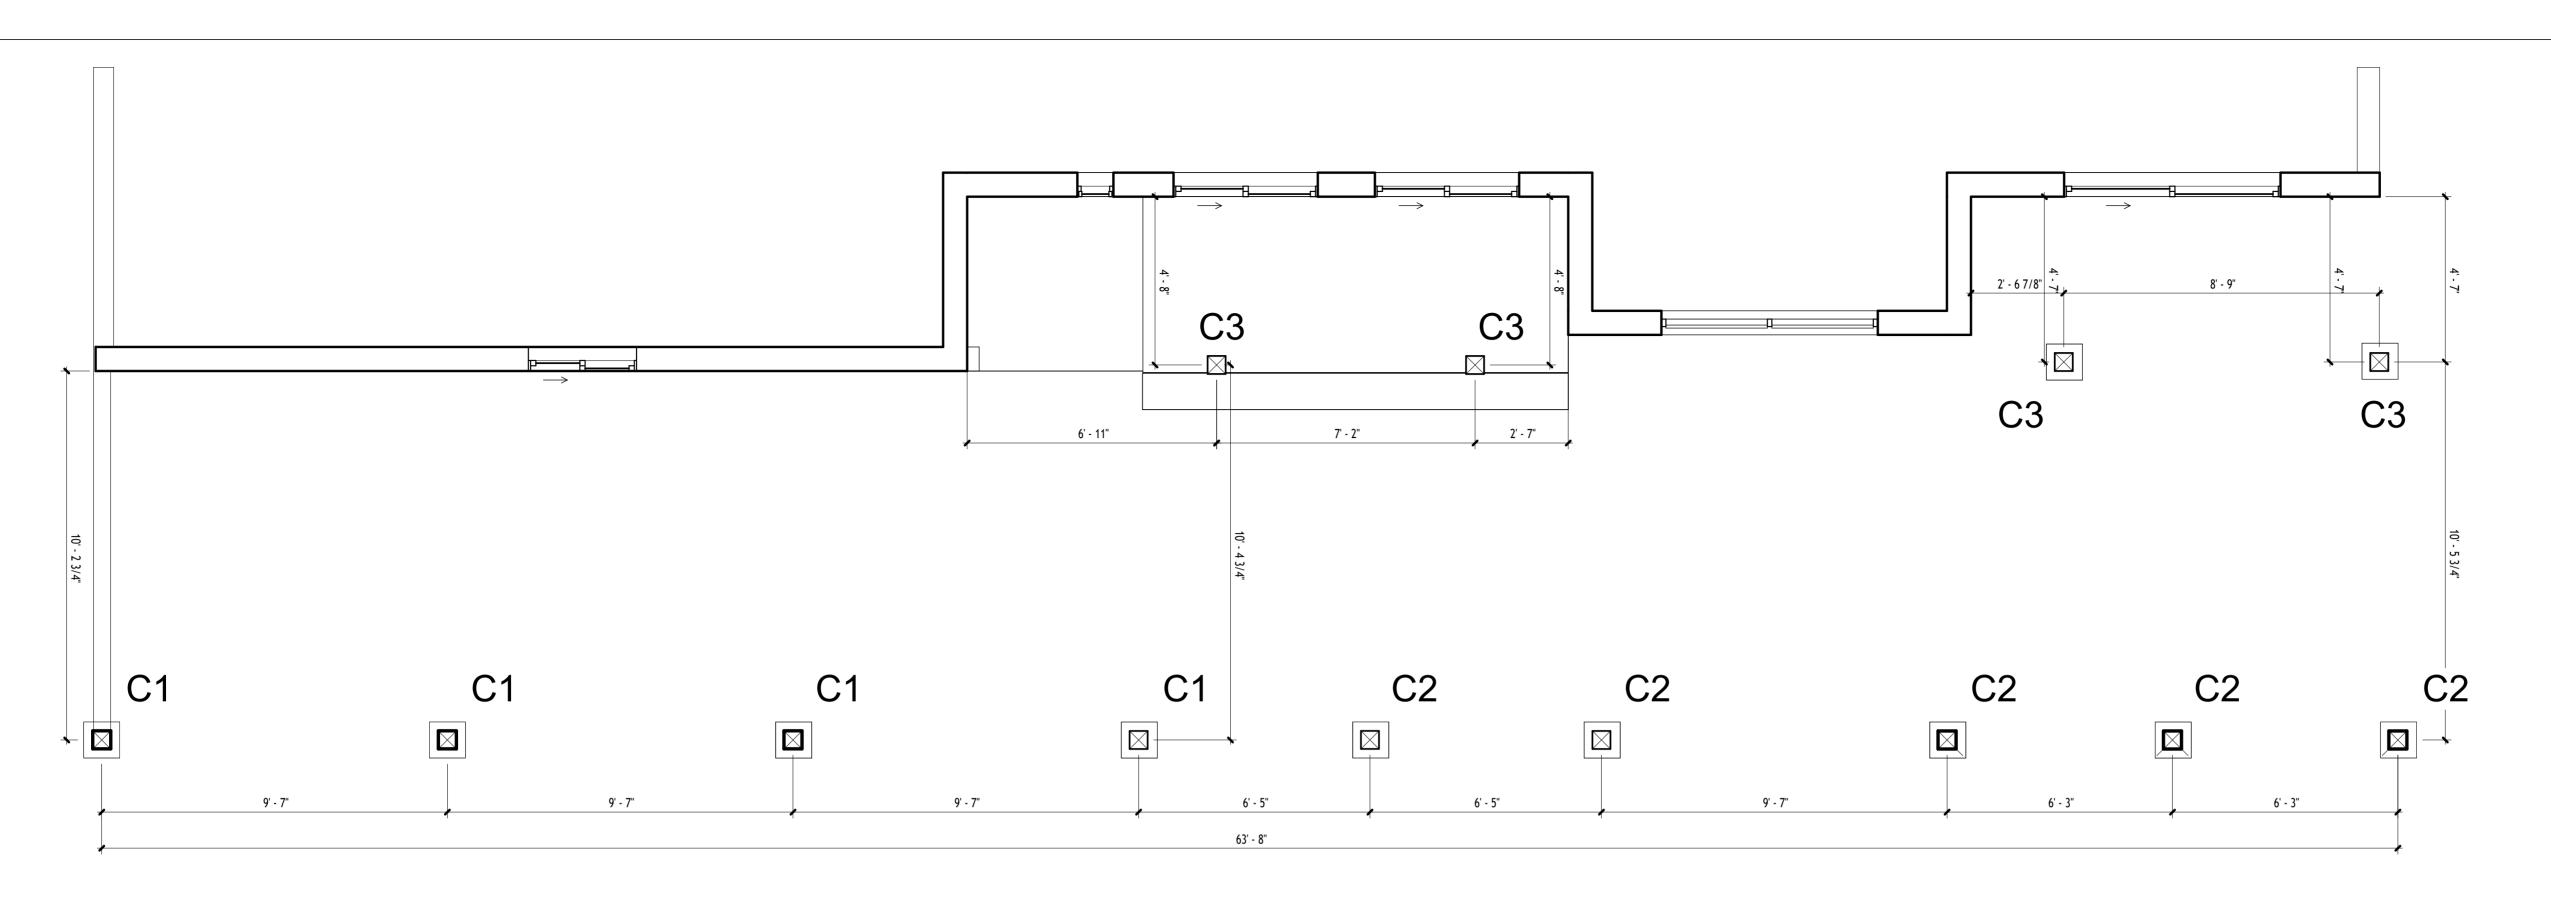

Project Name 64' Long Second-Story Balcony Repair/Rebuild

Project Address


41 Heltsey Pl, El Sobrante, CA 94803

Project

Project Description

New posts to be installed. Post height dictated by footing type and height of deck. Deck has 2 levels (Refer to ST-07 D1 and D2).

C1 corresponds to outer posts supporting deck at D1 height atop elevated footings. C2 corresponds to outer posts supporting deck at D2 height with elevated footings. C3 corresponds to inner posts supporting deck at D2 height with lower footings (See S-01 Detail 7)."

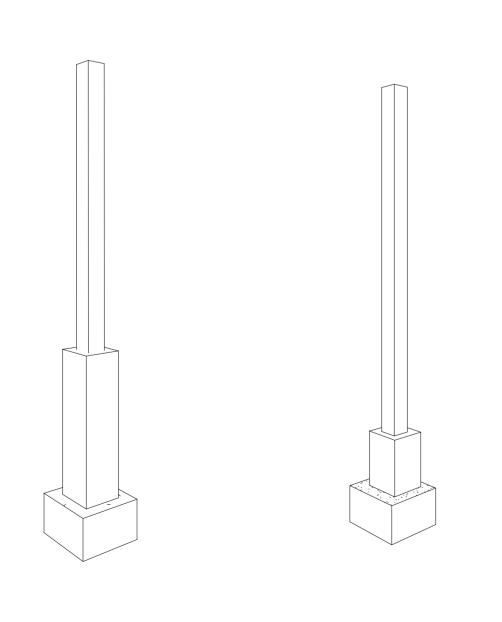

C1/C2

C3

SCHEDULE OF COLUMNS MARK WIDTH DEPTH HEIGHT DESCRIPTION 6x6 Post Sopporting D1 6" 6" Outter coulumn Starting 2' 8" above ground 6x6 Post Sopporting D2 C2 6" 6" 8' 10" Outter coulumn Starting 2' 8" above groundand 6x6 Post Sopporting D2 Inner coulumn **C**3 6" 6" 10' 10" Starting 6" above groundand

*Column Height may vary according to the distance between Footing Heigth and Deck Height

DATE & APPROVAL

Sheet Title

COLUMN LAYOUT PLAN - Proposed Deck




3/8" = 1'-0"


1	Α	2025-07-21	ISSUED FOR OWNER REVIEW	
2	В	2025-08-05	ISSUED FOR OWNER REVIEW	ST-03
3	С	2025-08-18	ISSUED FOR OWNER REVIEW	Checked by Adam Morgenthaler
4			ISSUED FOR PERMIT	Drawn by Zen Life Design
5			ISSUED FOR PRICING	Date 2025-08-18
6				Project number 1
_			ISSUED FOR ISSUANCE OF PERMIT	
7			VALUE ENGINEERING REVISIONS	


DESCRIPTION


IS RE DATE


Scale

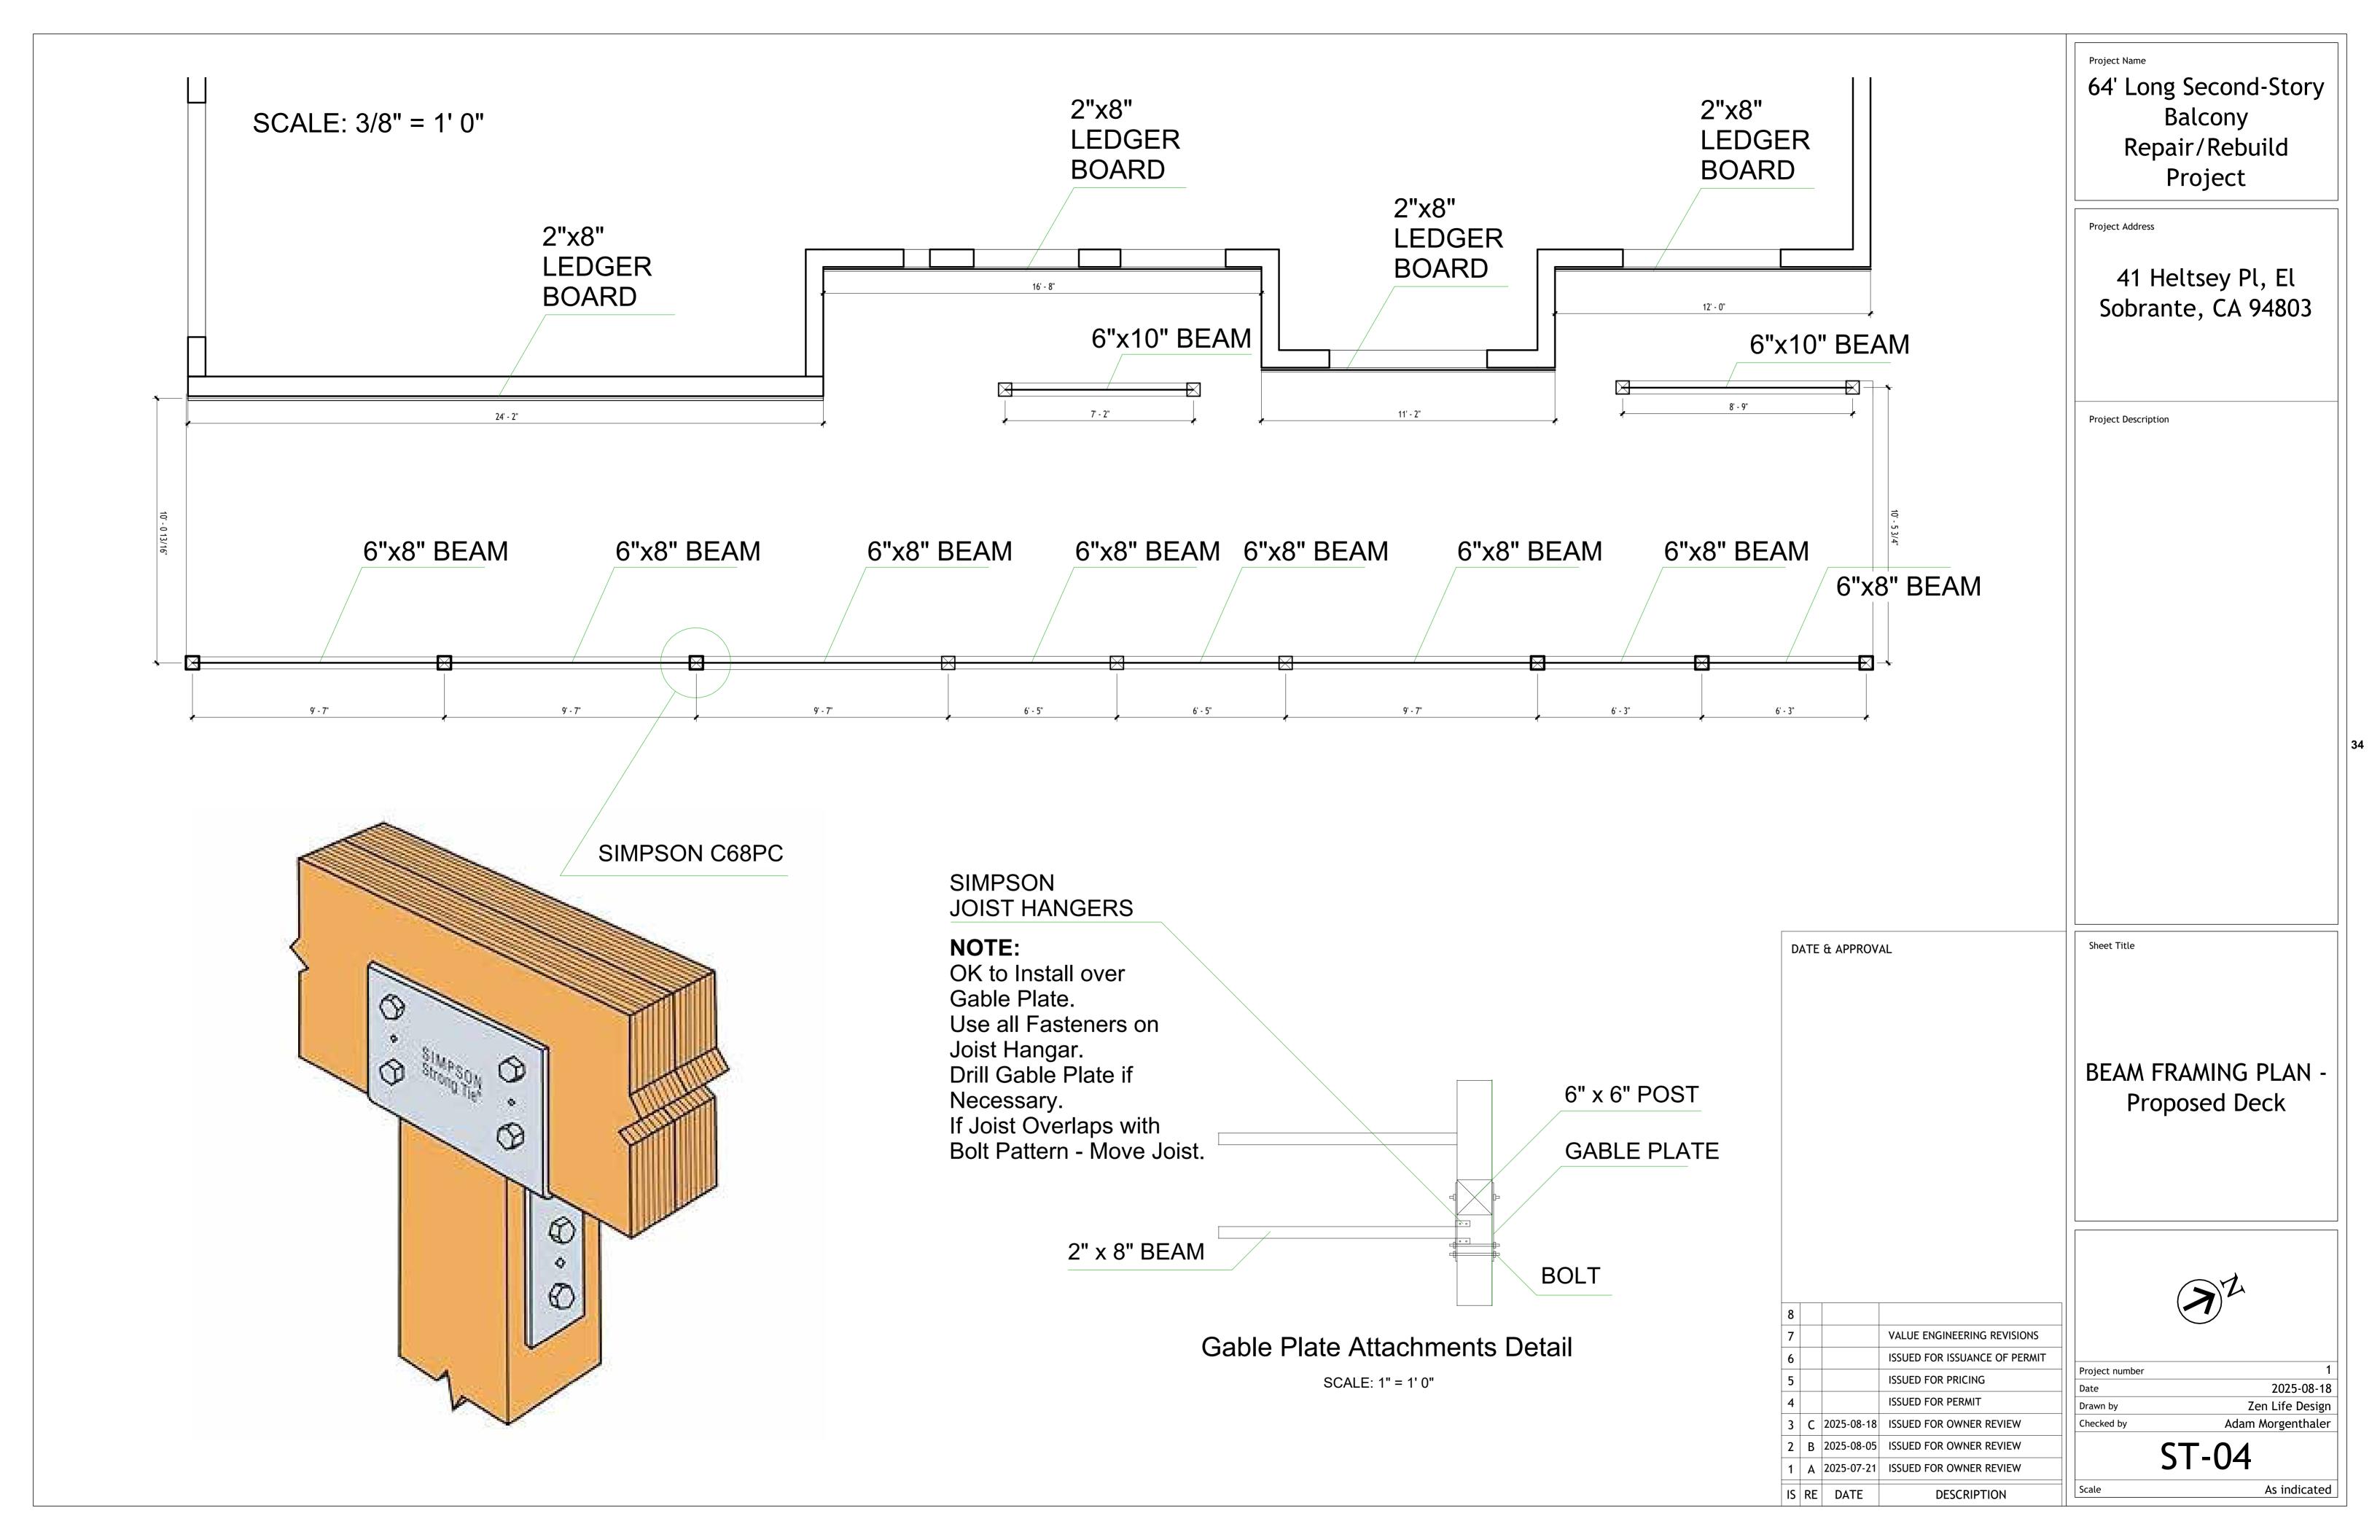

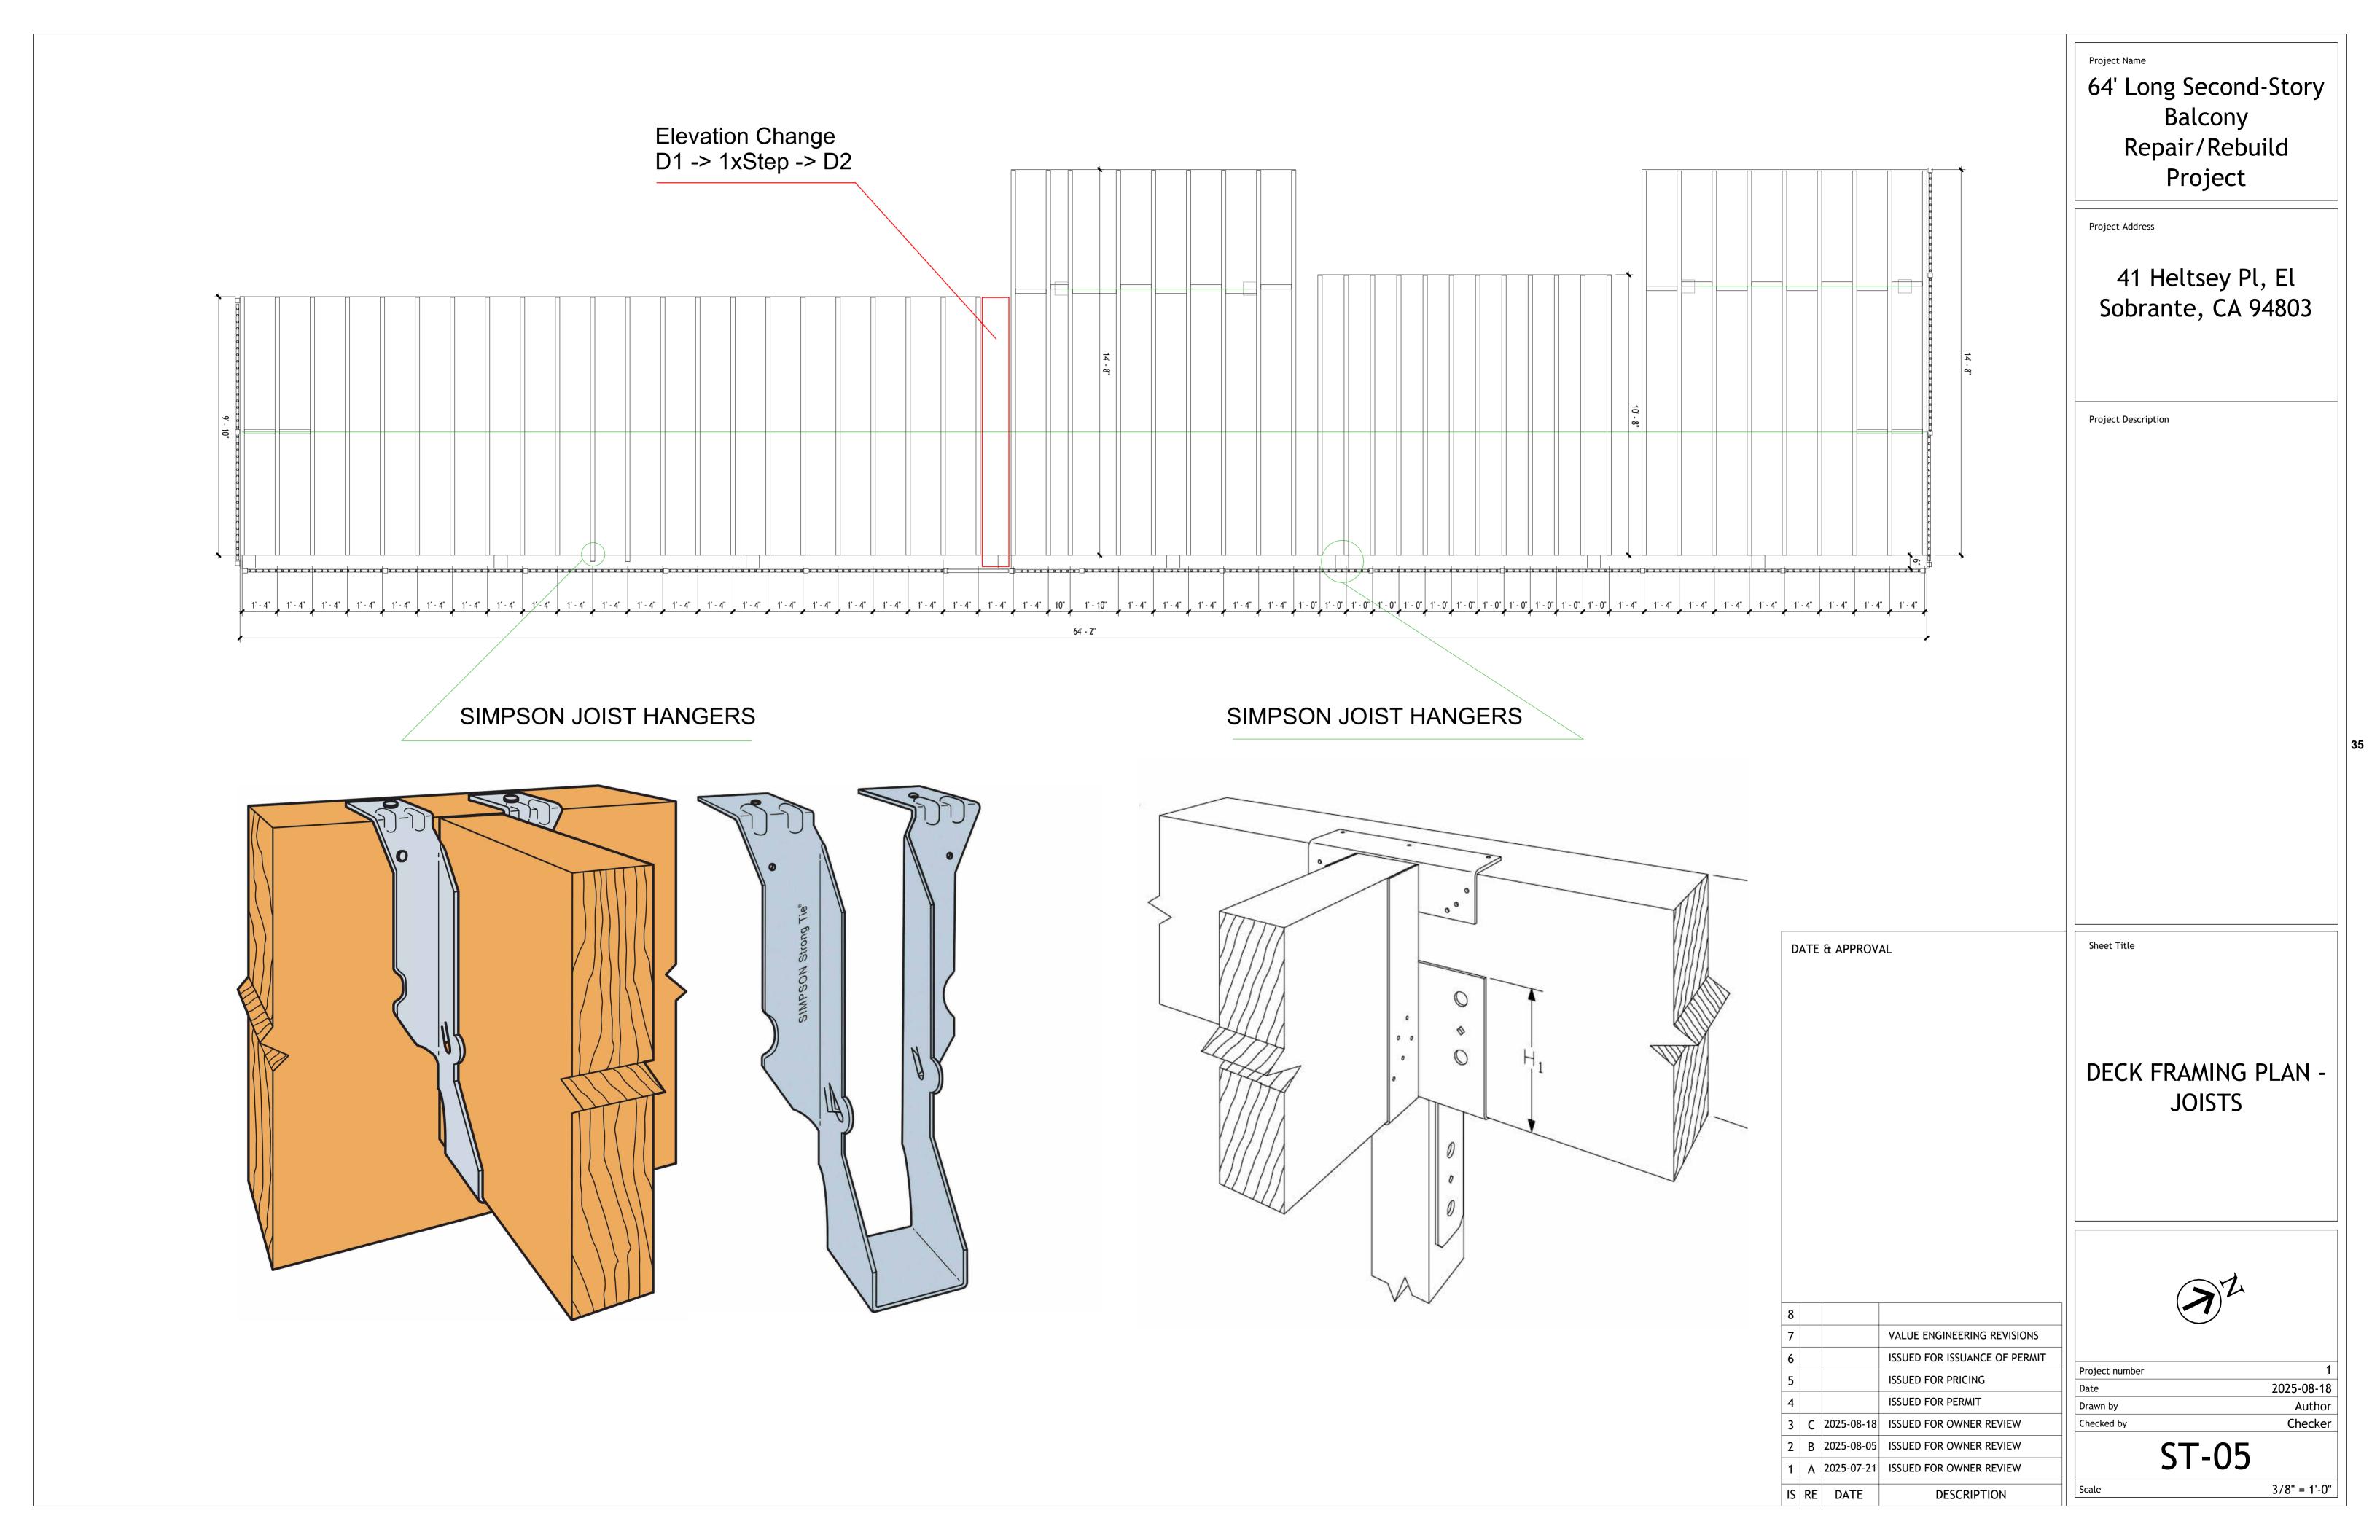


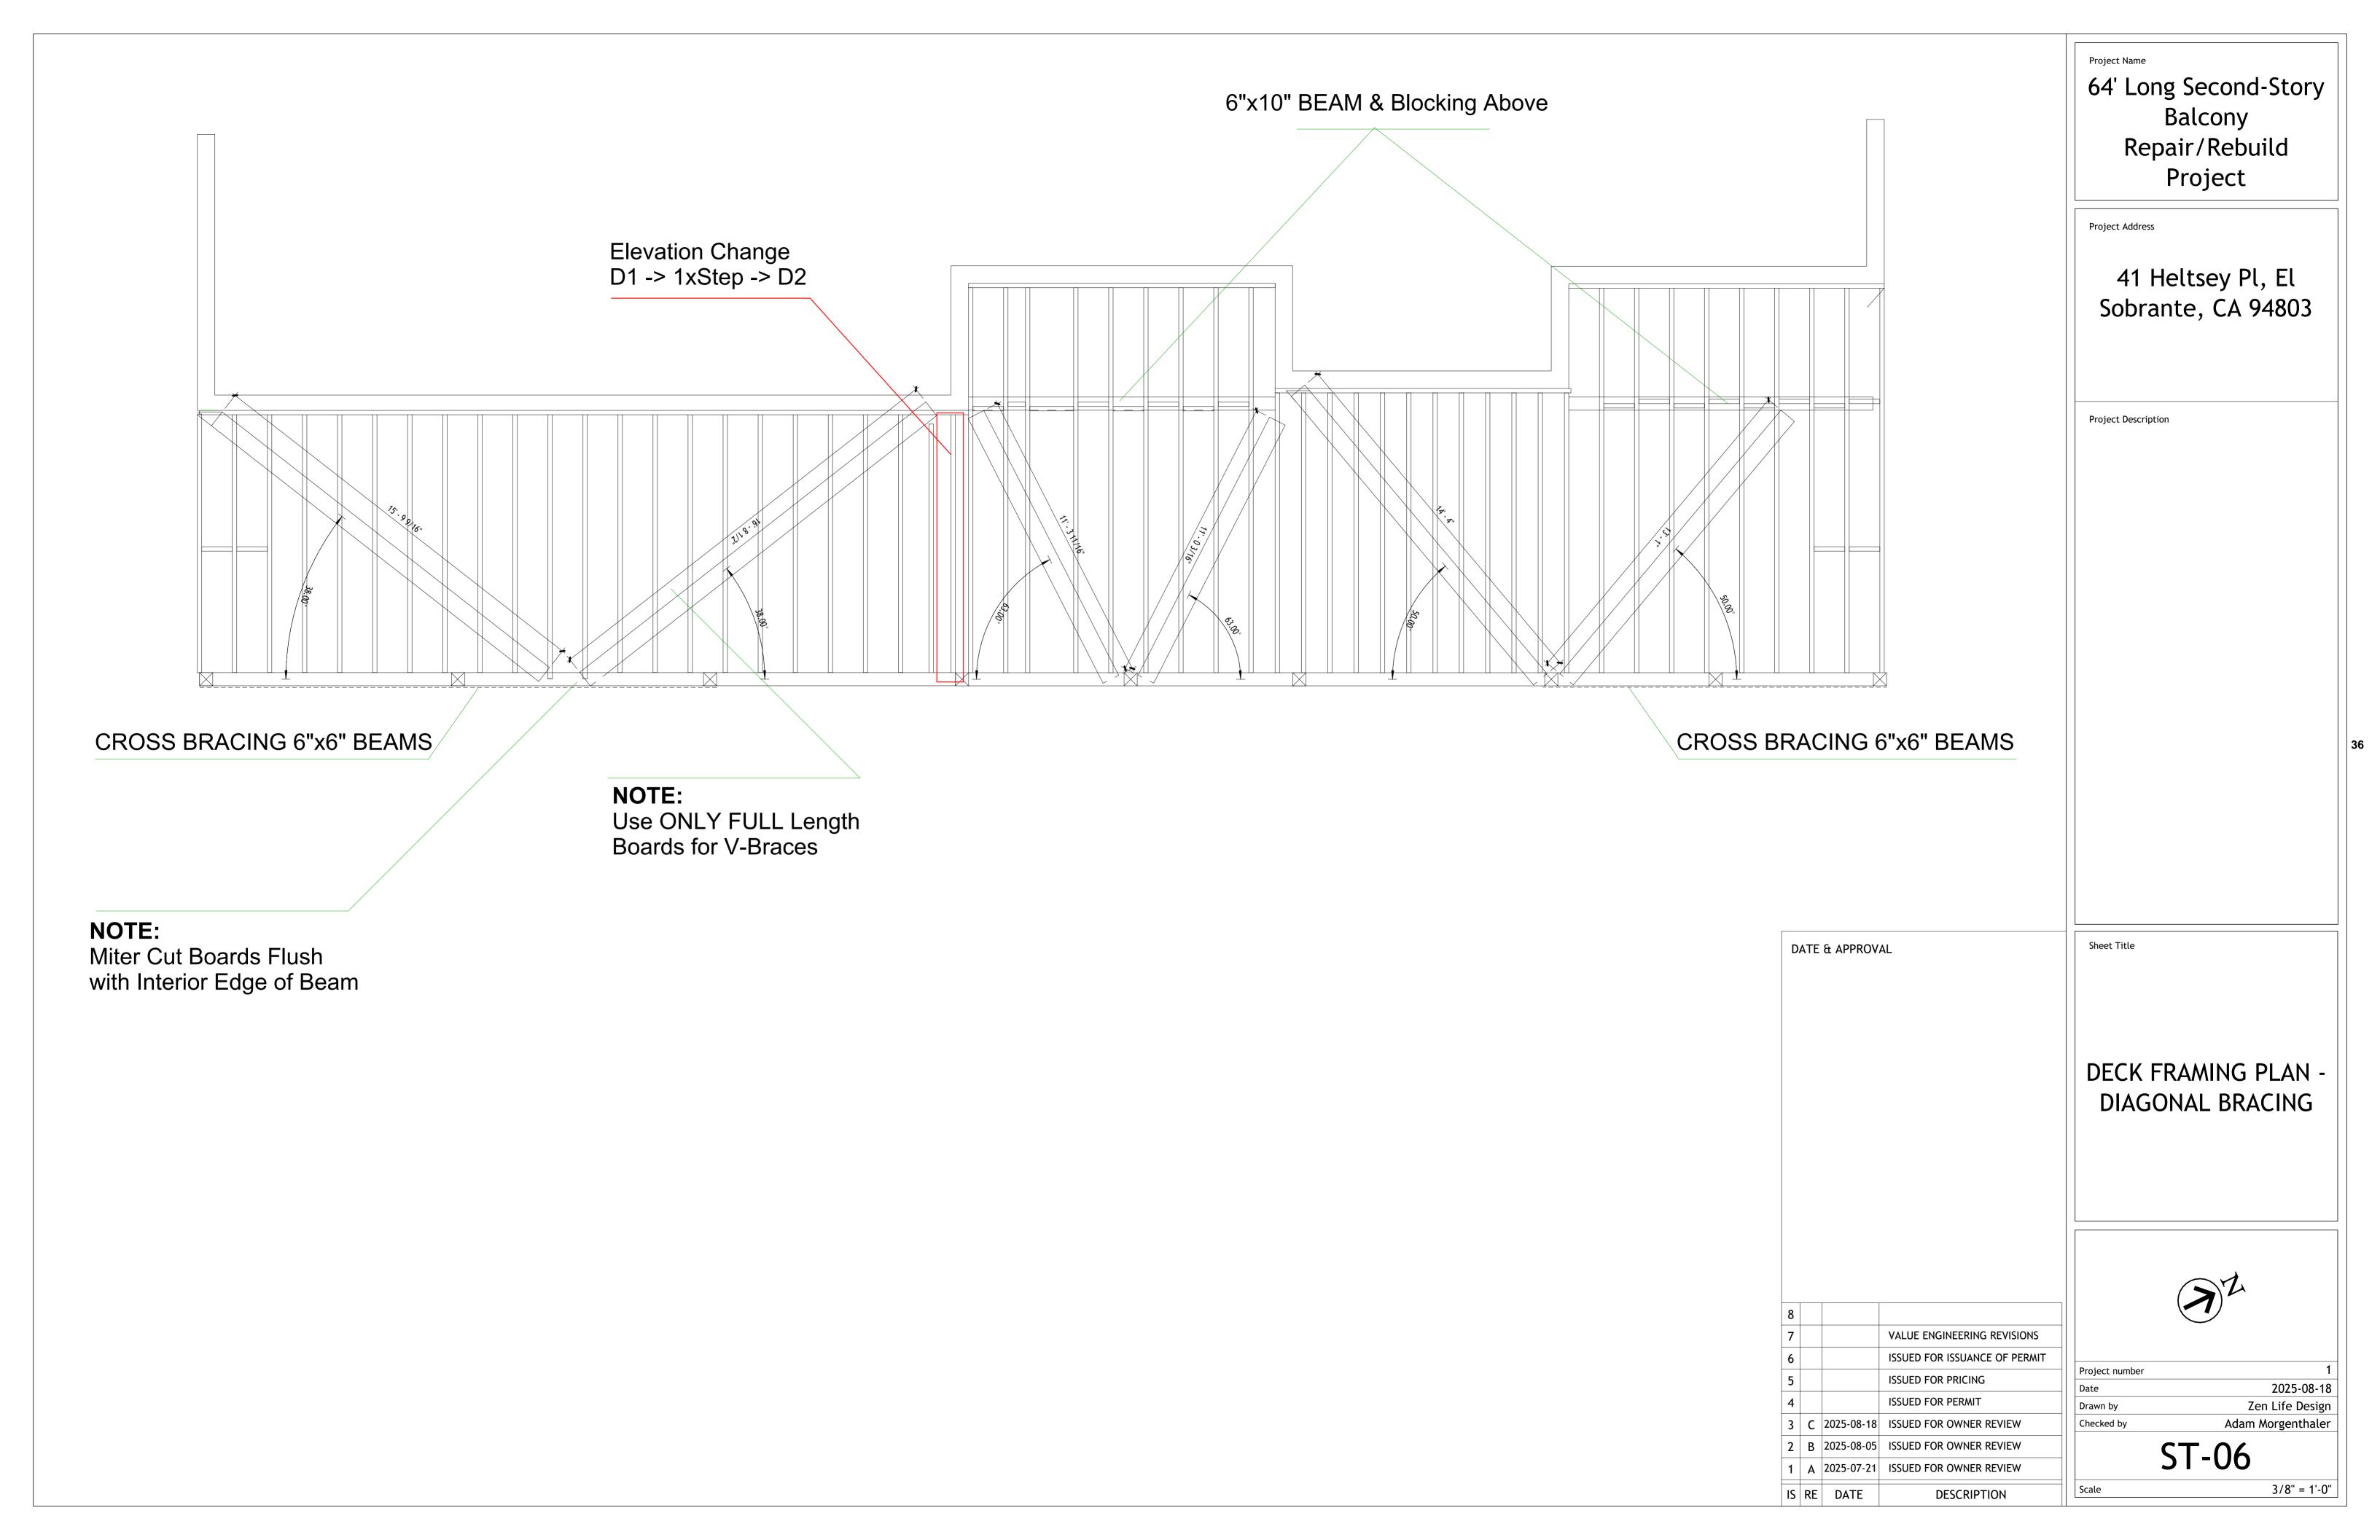


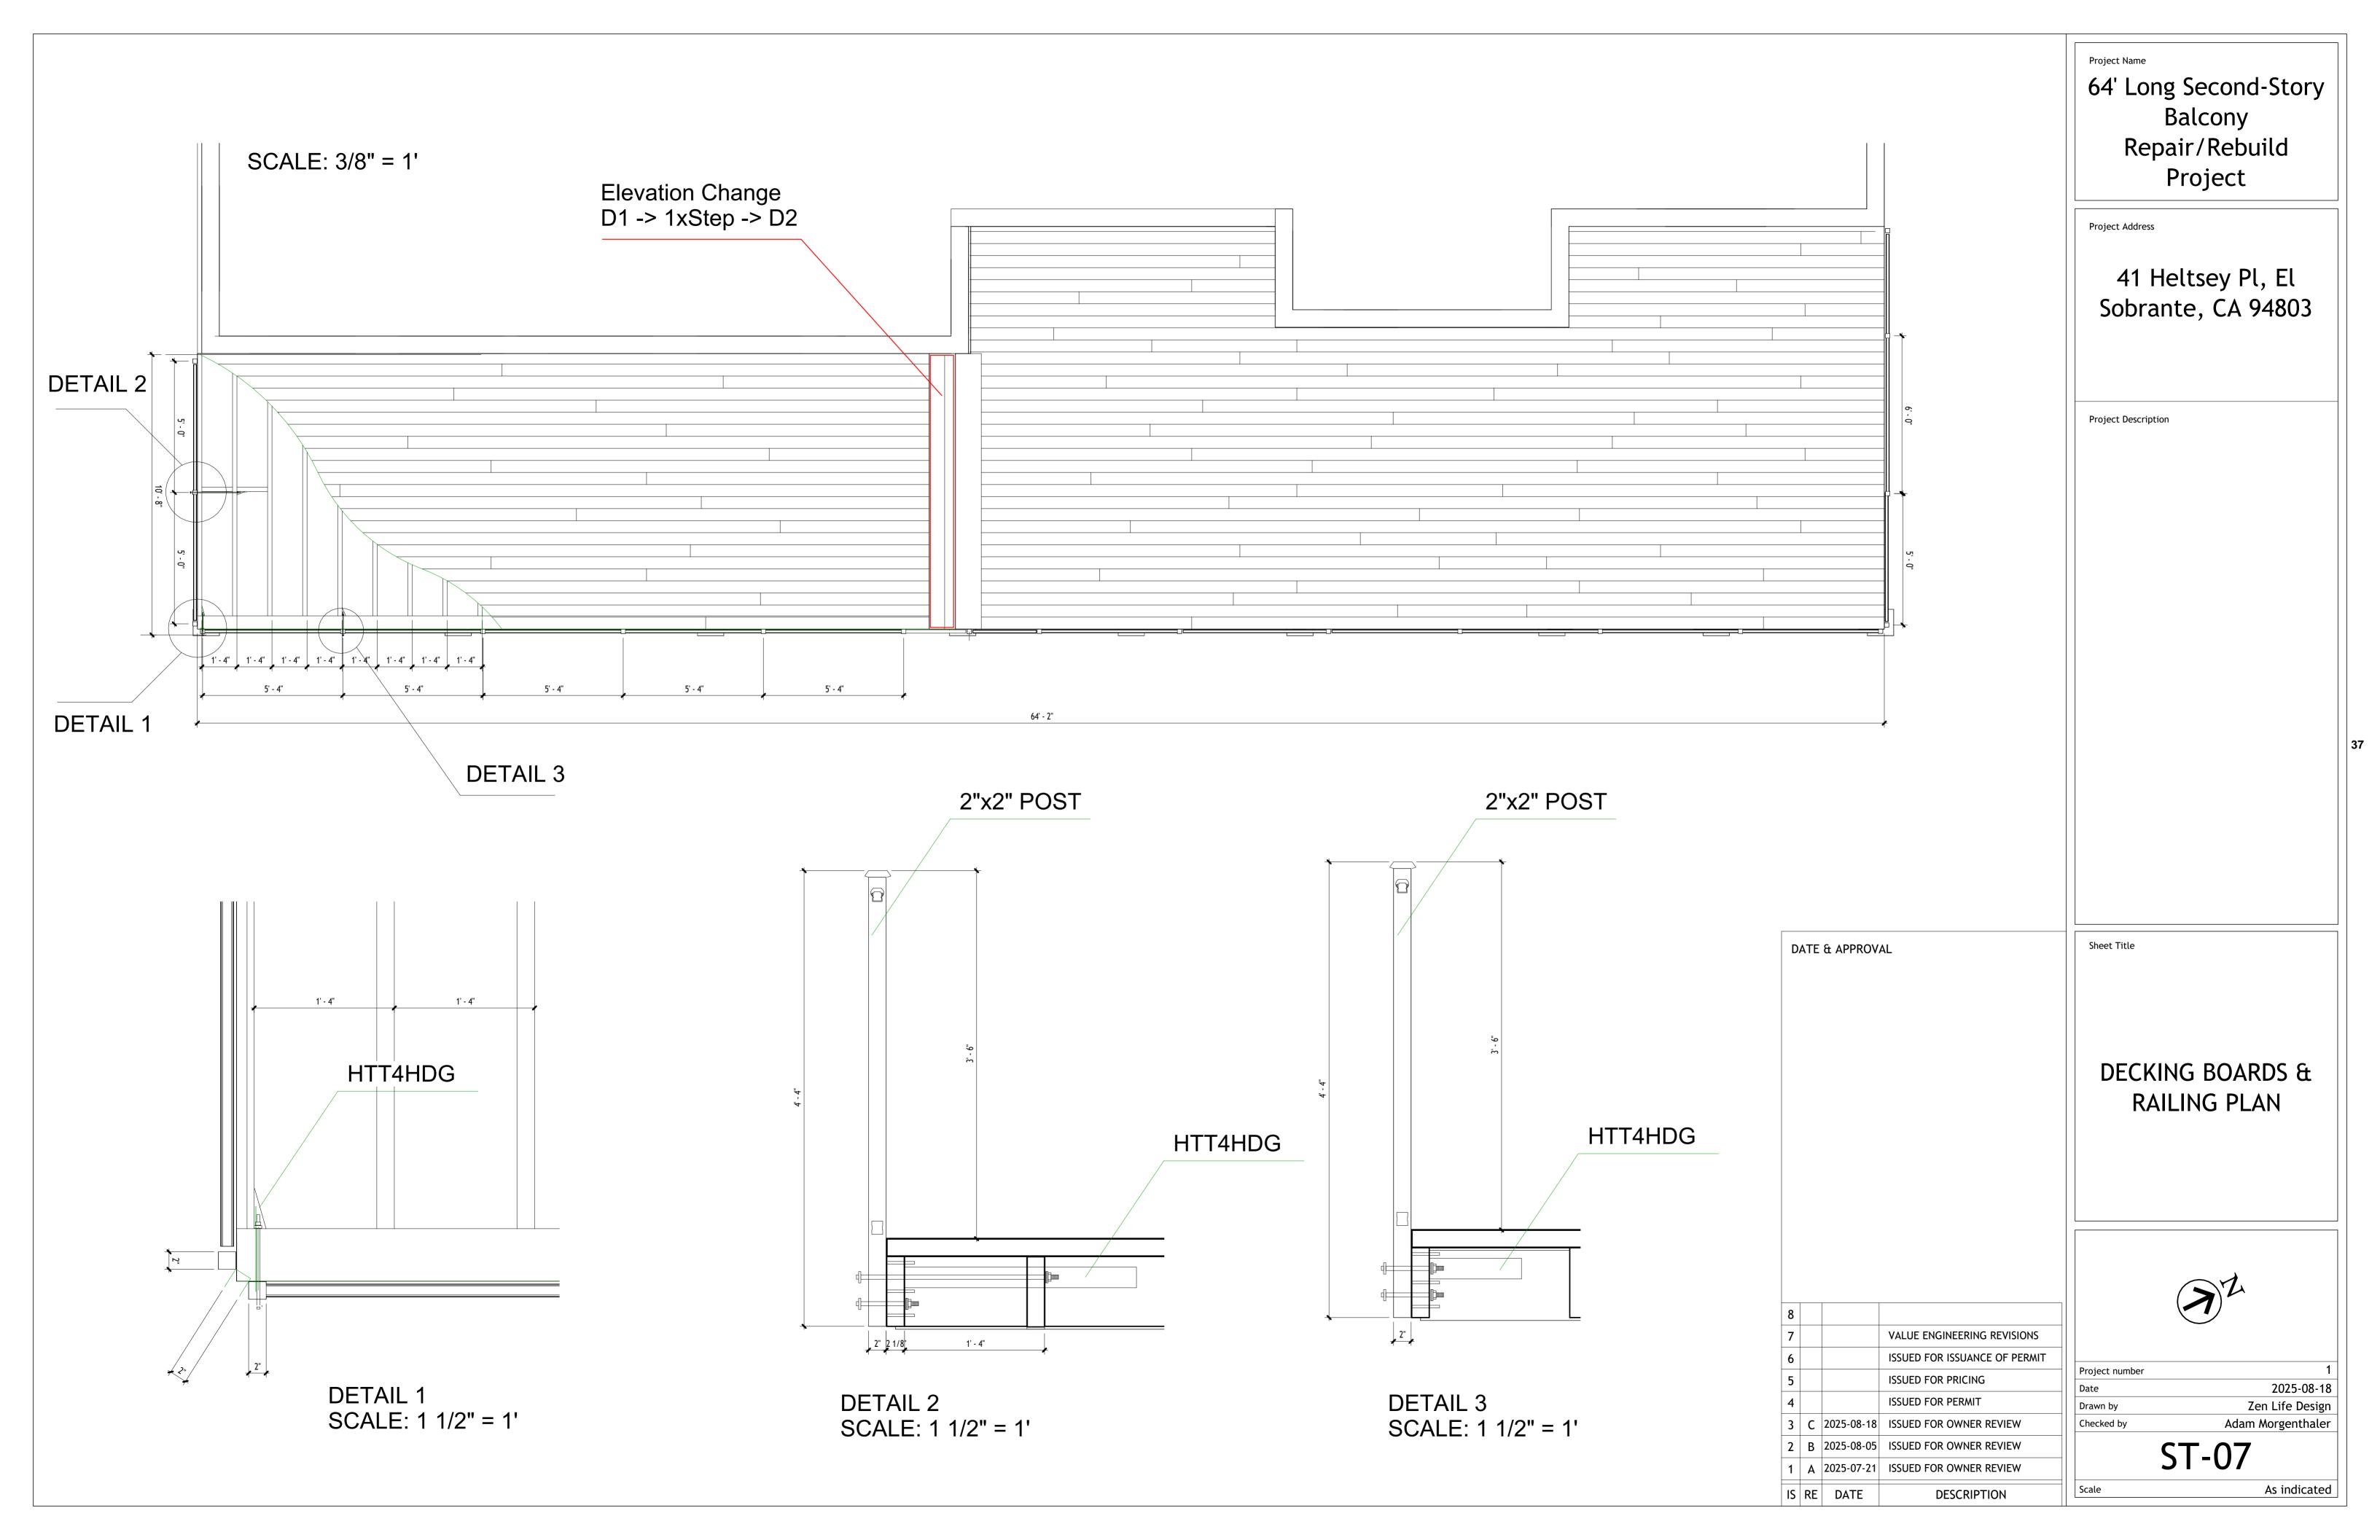

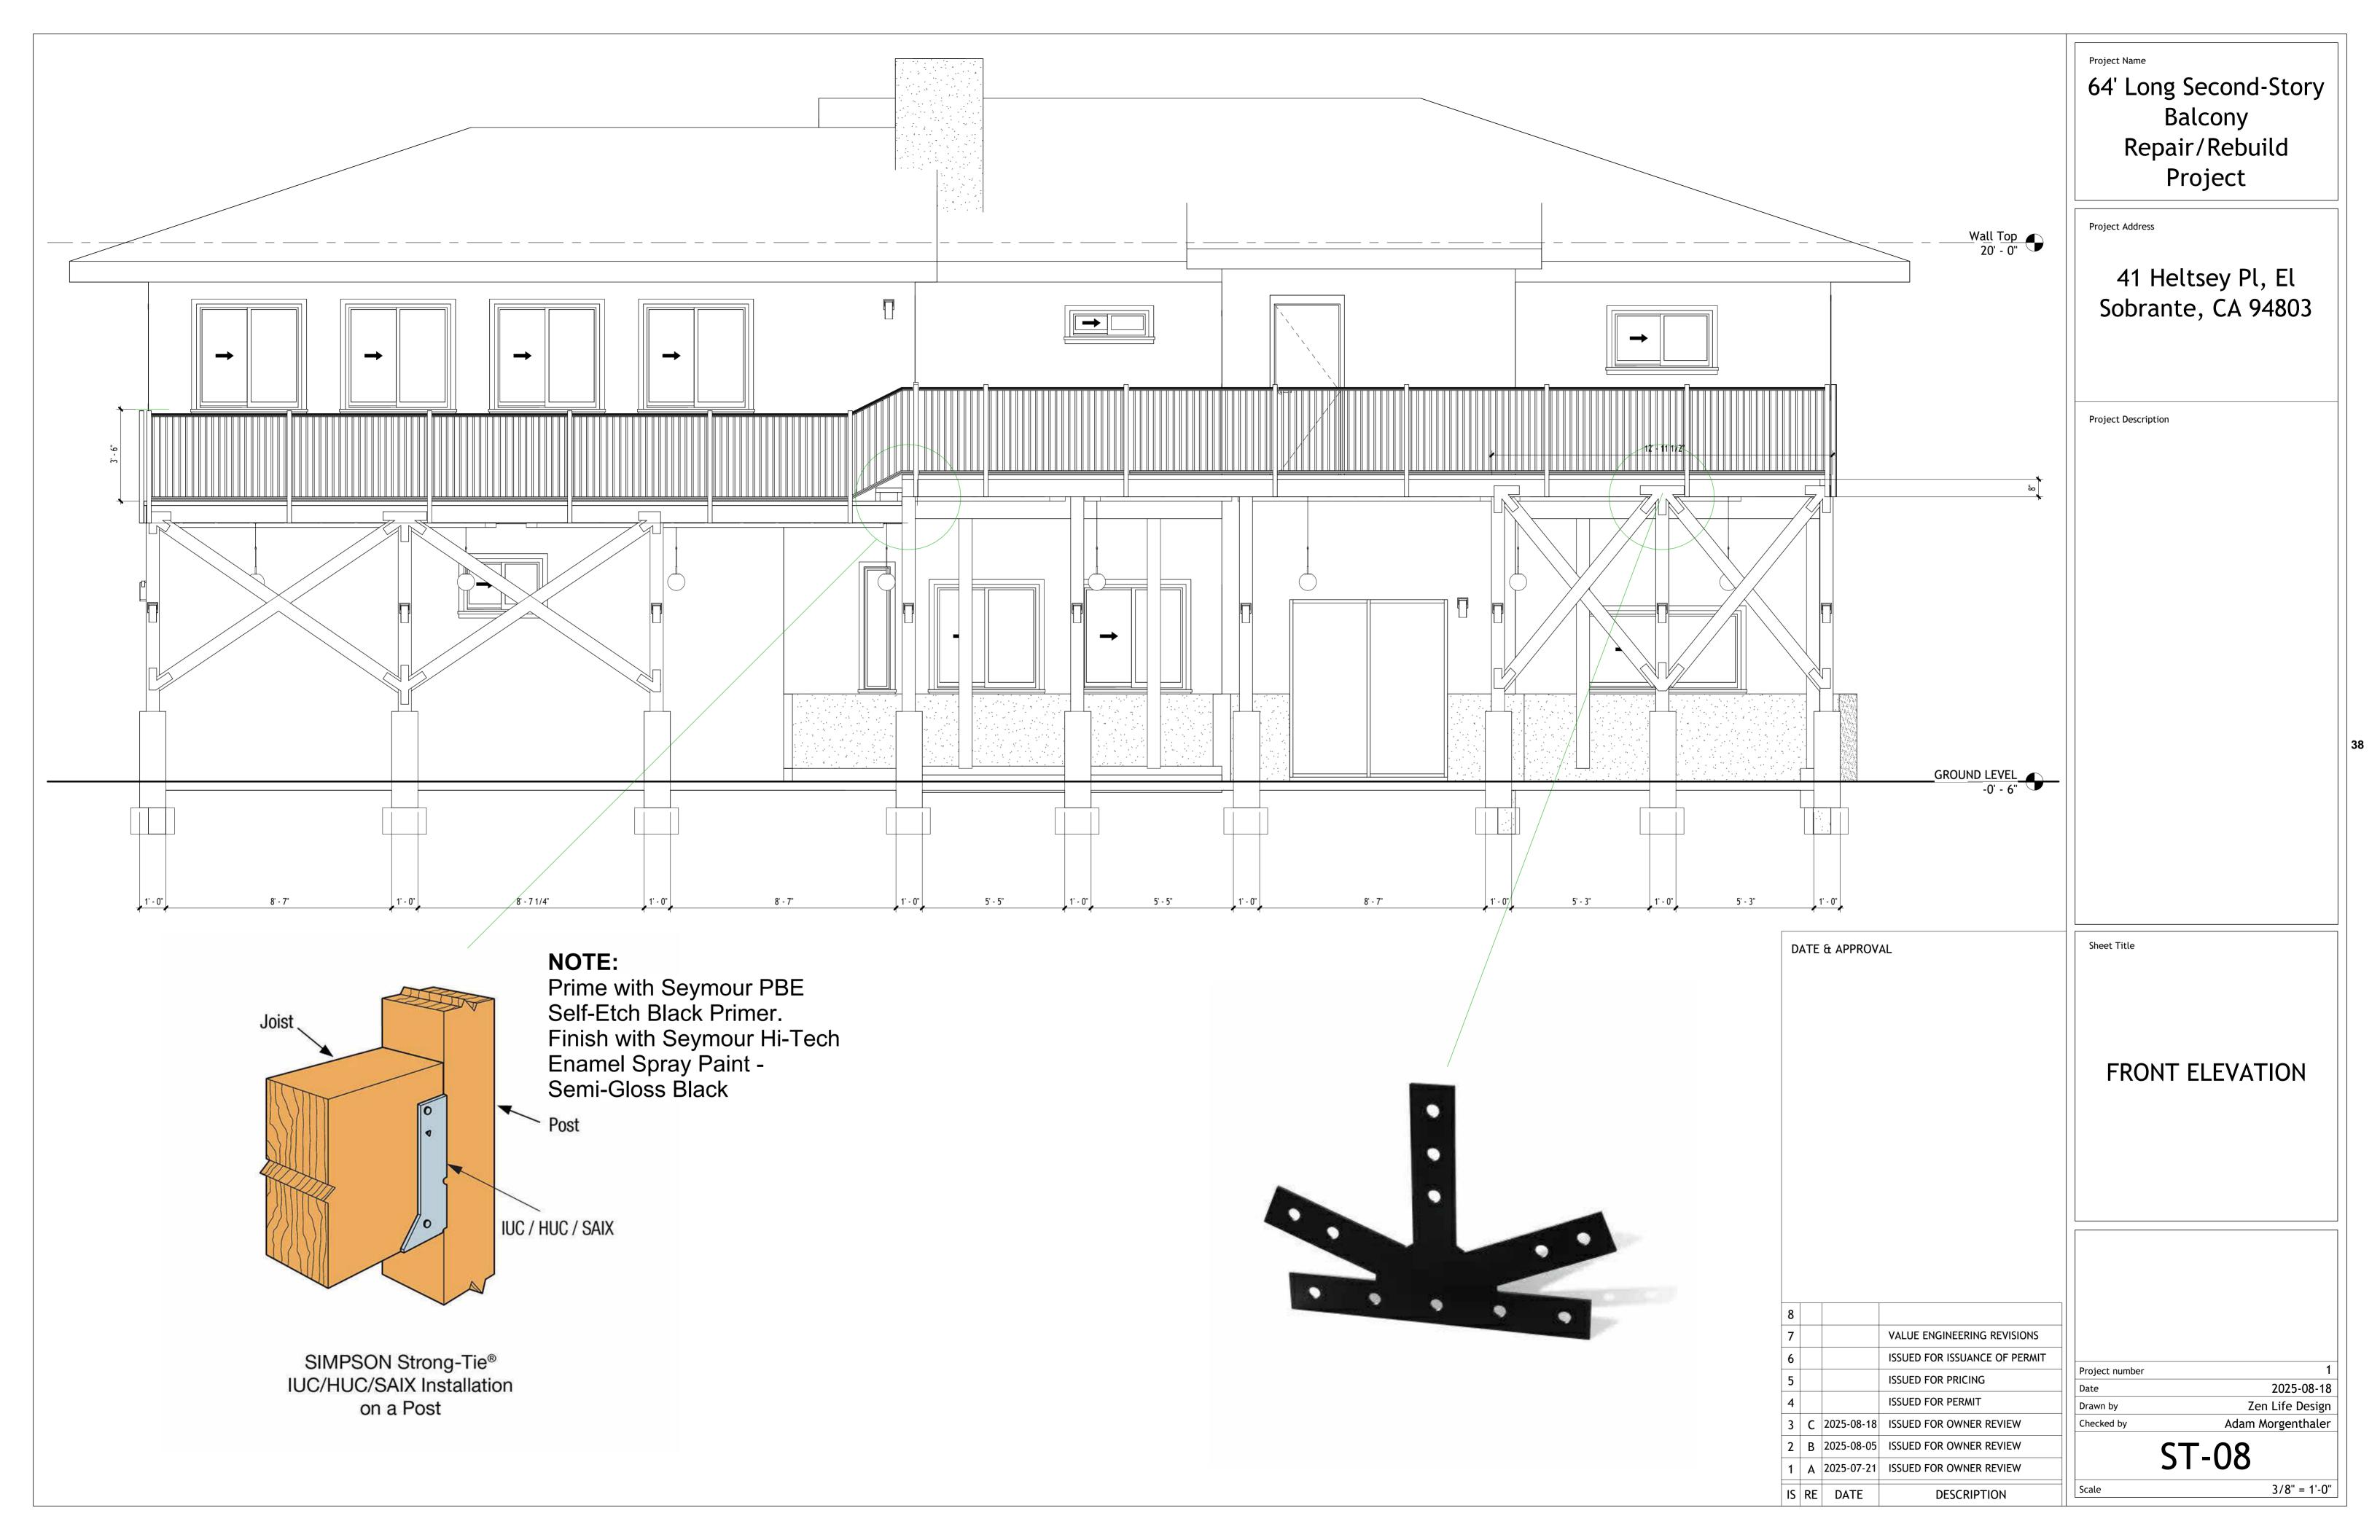



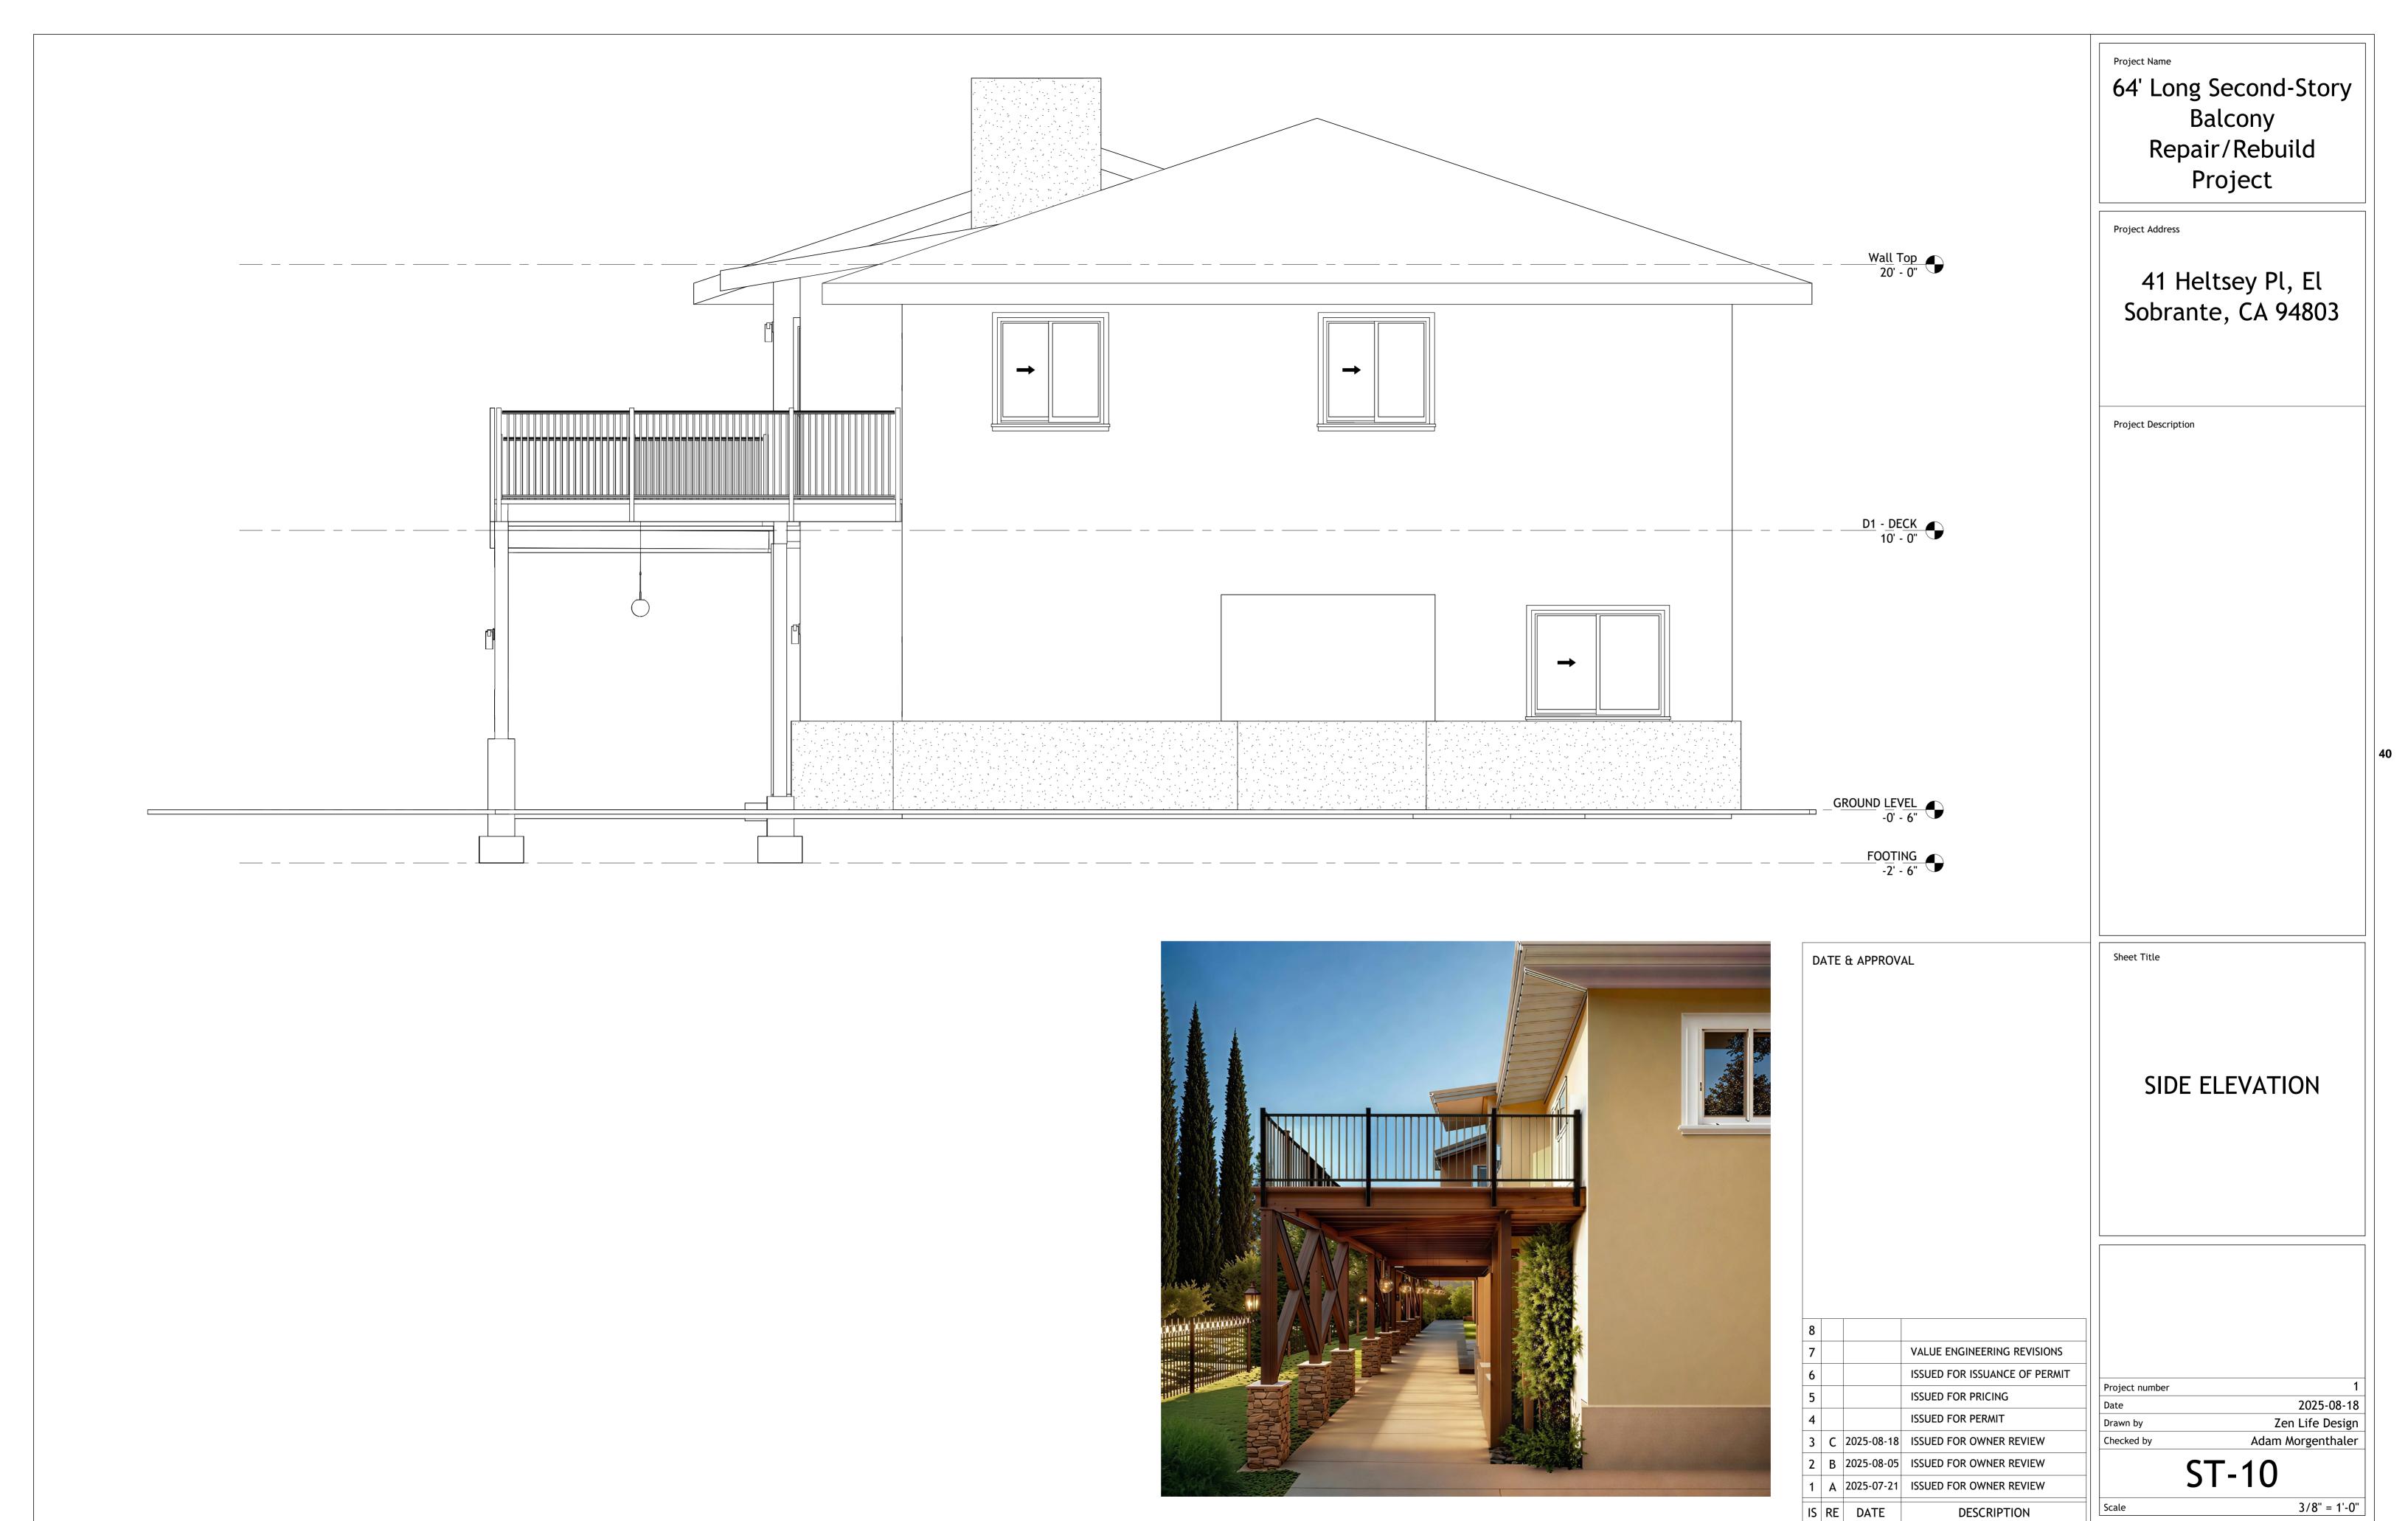

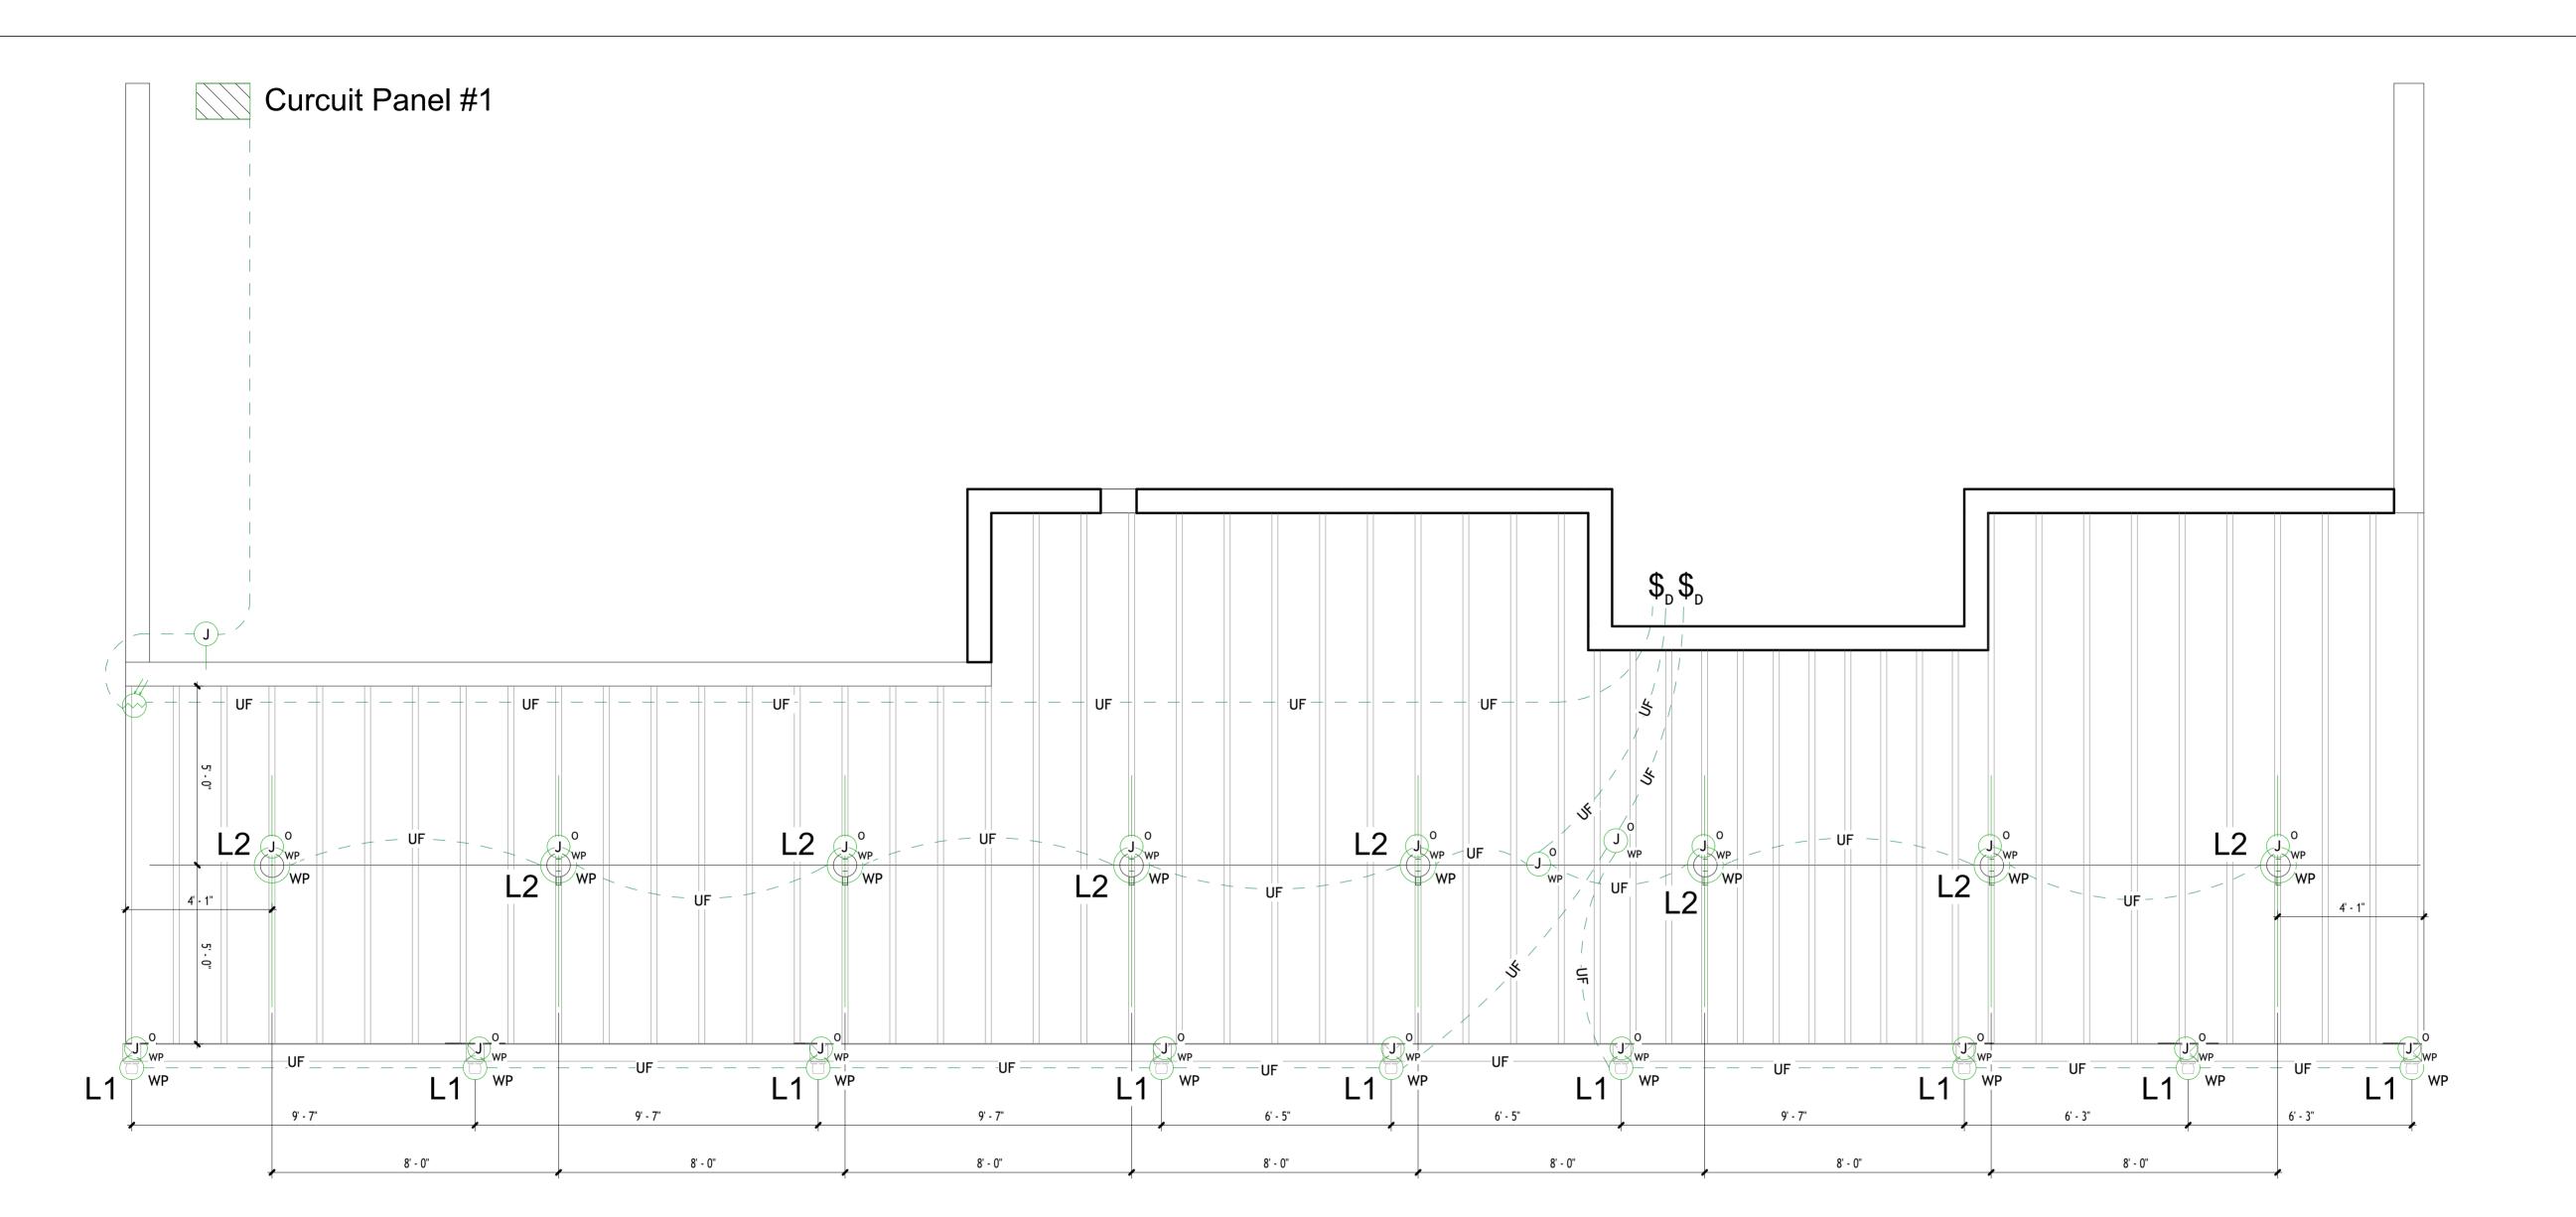

Project Name

64' Long Second-Story Balcony Repair/Rebuild Project

Project Address

41 Heltsey Pl, El Sobrante, CA 94803

Project Description

Summary of Scope:

Supply: 120 Vac

Bulbs: A19, E26, dimmable, 4000K neutral white, ~100 W equivalent (≈ 1600 lm)

Total fixtures: 17

Total run length (loop out and back to switch): ~150 ft

Installation:

Exterior/under-deck; use outdoor-rated junction boxes, fittings, and UF cable staples/clamps

Photocell mounted on canopy/box with swivel stem aimed away from fixture light.

Sheet Title

Lights Layout Plan

8			
7			VALUE ENGINEERING REVISIONS
6			ISSUED FOR ISSUANCE OF PERMIT
5			ISSUED FOR PRICING
4			ISSUED FOR PERMIT
3	С	2025-08-18	ISSUED FOR OWNER REVIEW
2	В	2025-08-05	ISSUED FOR OWNER REVIEW
1	Α	2025-07-21	ISSUED FOR OWNER REVIEW
IS	RE	DATE	DESCRIPTION

DATE & APPROVAL

Project number 2025-08-18 Drawn by Zen Life Design Adam Morgenthaler Checked by

EL-01

Scale

3/8" = 1'-0"

	SCHEDULE OF	= LIGH	TING

MARK	VISUAL	COUNT	DISCRIPTION	Watts MAX	SUBTOTAL Watts	Volts	TOTAL Watts	TOTAL Amps
L1		9	Outdoor Wall Sconce Matte Black with Clear Glass	60	540	120	1 020	9.5
L2		8	Glass Globe Pendants	60	480	120	1,020	8.5

Project Name

Photocell

Internet/SKU: Varies by distributor; Intermatic

Material: UV-resistant polycarbonate housing;

locations when properly installed (typical use on

Listing: UL Listed (UL 773), cCSAus; California

Load ratings: 15 A tungsten (1800 W) at 120 V;

stainless hardware; cadmium sulfide (CdS)

photo sensor; bimetallic thermal switch

Color/finish: Gray housing with black

NEMA rating: Raintight; suitable for wet

Voltage/frequency: 120 VAC, 50/60 Hz

8.3 A, 1000 VA magnetic ballast at 120 V

delay to prevent nuisance switching

approx. 3–15 fc (factory set)

Control type: Thermal (bimetal), SPST; fail

mode ON; built-in 30–90 s turn-on/turn-off time

Light levels: Turn ON approx. 1–5 fc; Turn OFF

Stem/thread: 1/2"-14 NPSM threaded stem with

Temperature range: -40 °C to +70 °C operating

threaded hub/opening on a weatherproof box or

DATE & APPROVAL

swivel mount; includes gasket and locknut

Leads: 9 in. (approx.) 18 AWG wire leads

Mounting: Stem-and-swivel through 1/2"

luminaire; aim sensor away from stray light

Cover/fixture compatibility: For outdoor

luminaires, junction and lampholder boxes;

compatible with 1/2" hubs on weatherproof

boxes (use supplied gasket/locknut)

Make: Intermatic

Model: K4221C

catalog K4221C

swivel/stem hardware

Title 20 compliant

outdoor luminaires and boxes)

Summary of Scope:

Supply: 120 Vac

Bulbs: A19, E26, dimmable, 4000K neutral white, ~100 W equivalent (≈ 1600 lm)

Total fixtures: 17

Total run length (loop out and back to switch): ~150 ft

Exterior/under-deck; use outdoor-rated junction boxes, fittings, and UF cable staples/clamps

Photocell mounted on canopy/box with swivel stem aimed away from fixture light.

Sheet Title

Lights Detail

Project number Drawn by

Scale

EL-02

Model: Brimfield 3-Light Outdoor Wall Lantern

L1

Sconce **Product ID**: 204294432

Materials: Metal; Glass/Lens Type: Seedy

Finish: Aged Iron

Shade: Clear Seeded Glass panels

Brand: Home Decorators Collection

Fixture dimensions (body): 11" D x 9" W x

17.38" H

Weight: 6.33 lb Mounting type: Wall mount; Sconce Type: Wall

Lantern

Location rating: Outdoor; Water Resistant, Waterproof, Weather Resistant; UL Listed (1-UL

Listed)

JOIST

Gray.

4" Round Non-Metallic

with (5) 1/2 in. Holes,

Model # WRB550PG

Krylon Fusion All-In-

One. Color = Brick

Pre-painted with

Weatherproof Box

Voltage: 120V

Power type: Hardwired Socket/base: E26 Max wattage: 60 W

Dimming: With compatible dimmable bulb Light sources supported: Incandescent, L

L1 - Mounting Detail

UF Cable secured

Round

Box Hubbel

Weatherproof

PRB57550WH. Pre-painted with _Krylon Fusion All-In-One. Color =

Coffee Bean

with U-Nails or cable

SCALE: 1/2" = 1' 0"

Brand: Zanritelit

Model: 006outdoor pendant light

ASIN: B0CRYBQW1G Materials: Aluminum, Glass Finish: Sand Black (matte) Shade: Amber Glass, Globe

Fixture dimensions (body): 9.1" L x 9.1" W x

L2

13" H

Overall height (max): 35.03" (with chain)

Chain length: 20" adjustable

Canopy diameter: 4" Weight: 3.69 lb

Mounting type: Ceiling mount; hanging

Location rating: IP65

Voltage: 120 V

Power type: Hardwired Socket/base: E26 Max wattage: 60 W

Dimming: With compatible dimmable bulb Light sources supported: LED, CFL,

incandescent, halogen

Make: BELL

Model: PRB57550WH Internet/SKU: 202284522

Material: Nonmetallic, high-impact PVC

Color/finish: White

NEMA rating: NEMA 3R (raintight; protects from

Junction Boxes

rain, sleet, dust; not submersible)

Listing: UL Listed

Volume: 13.5 in³ (221 cm³)

Product dimensions: H 4.38 in × W 4.25 in × D

1.13 in

Outlet/entry count: 5 outlets

Thread sizes supported: 3/4 in NPT at A, B, C, D, E locations; includes reducers for 1/2 in Mounting: Box with integral hubs; includes

ground screw installed


Cover/fixture compatibility: Houses cluster covers and lampholders; can be used as a


weatherproof junction box



L2 - Mounting Detail

SCALE: 1" = 1' 0"

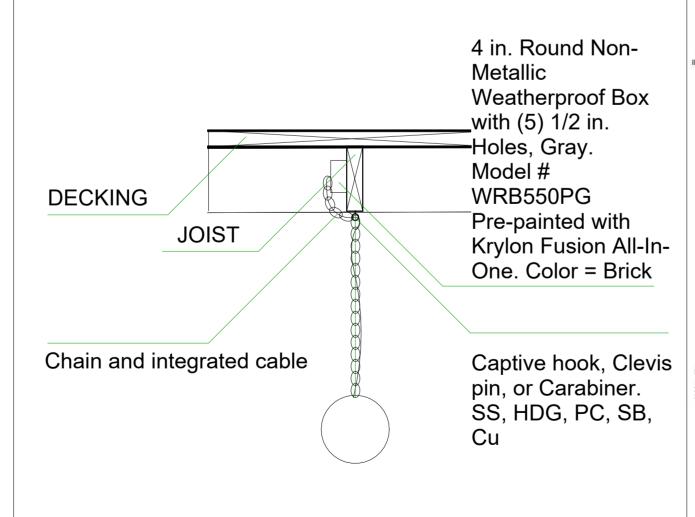

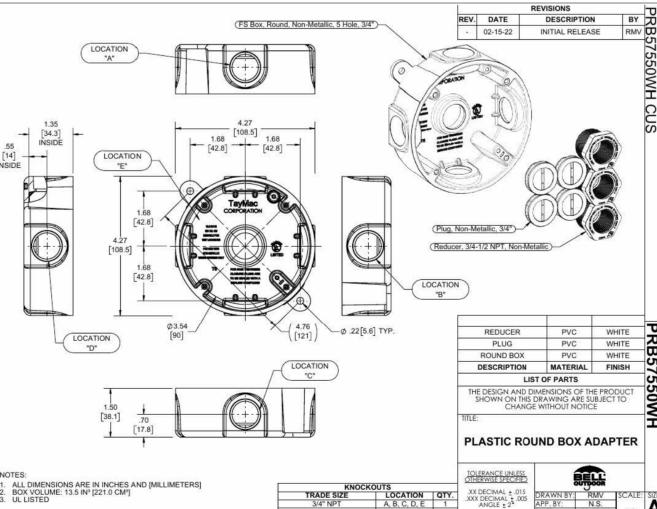



8			
7			VALUE ENGINEERING REVISIONS
6			ISSUED FOR ISSUANCE OF PERMIT
5			ISSUED FOR PRICING
4			ISSUED FOR PERMIT
3	С	2025-08-18	ISSUED FOR OWNER REVIEW
2	В	2025-08-05	ISSUED FOR OWNER REVIEW
1	Α	2025-07-21	ISSUED FOR OWNER REVIEW
IS	RE	DATE	DESCRIPTION


Adam Morgenthaler Checked by

As indicated

2025-08-18

Zen Life Design



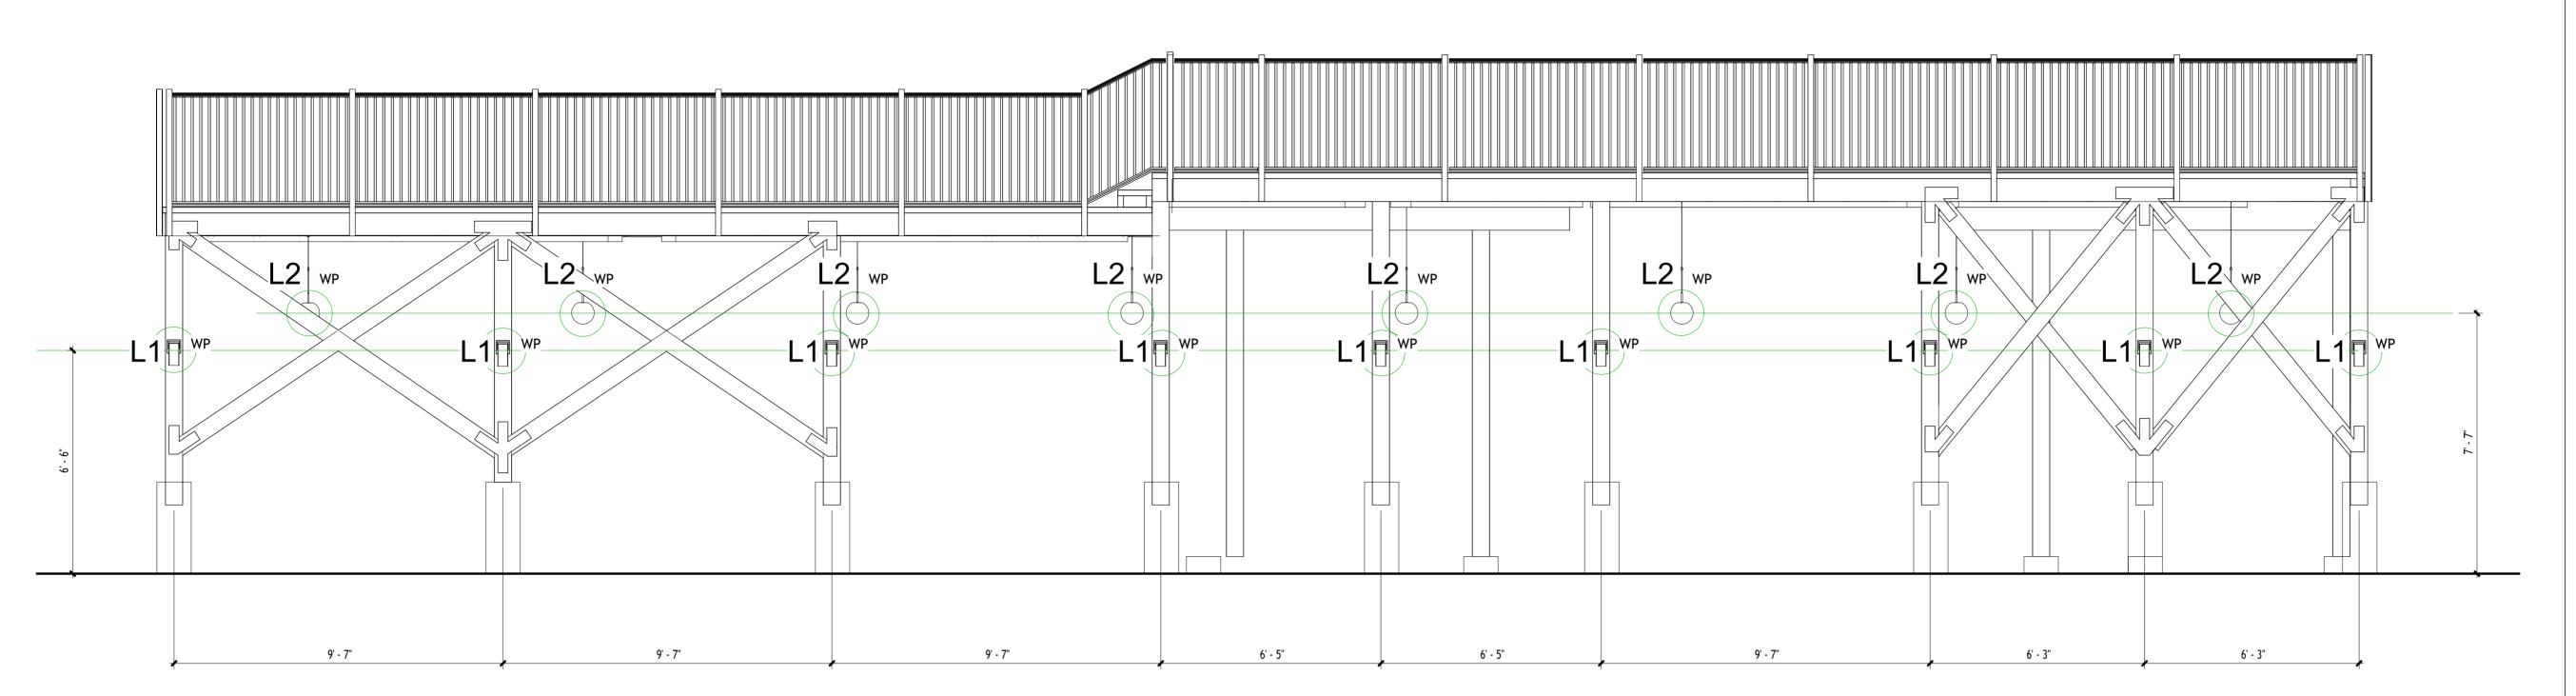


64' Long Second-Story
Balcony
Repair/Rebuild
Project

Project Address

41 Heltsey Pl, El Sobrante, CA 94803

Project Description

Sheet Title

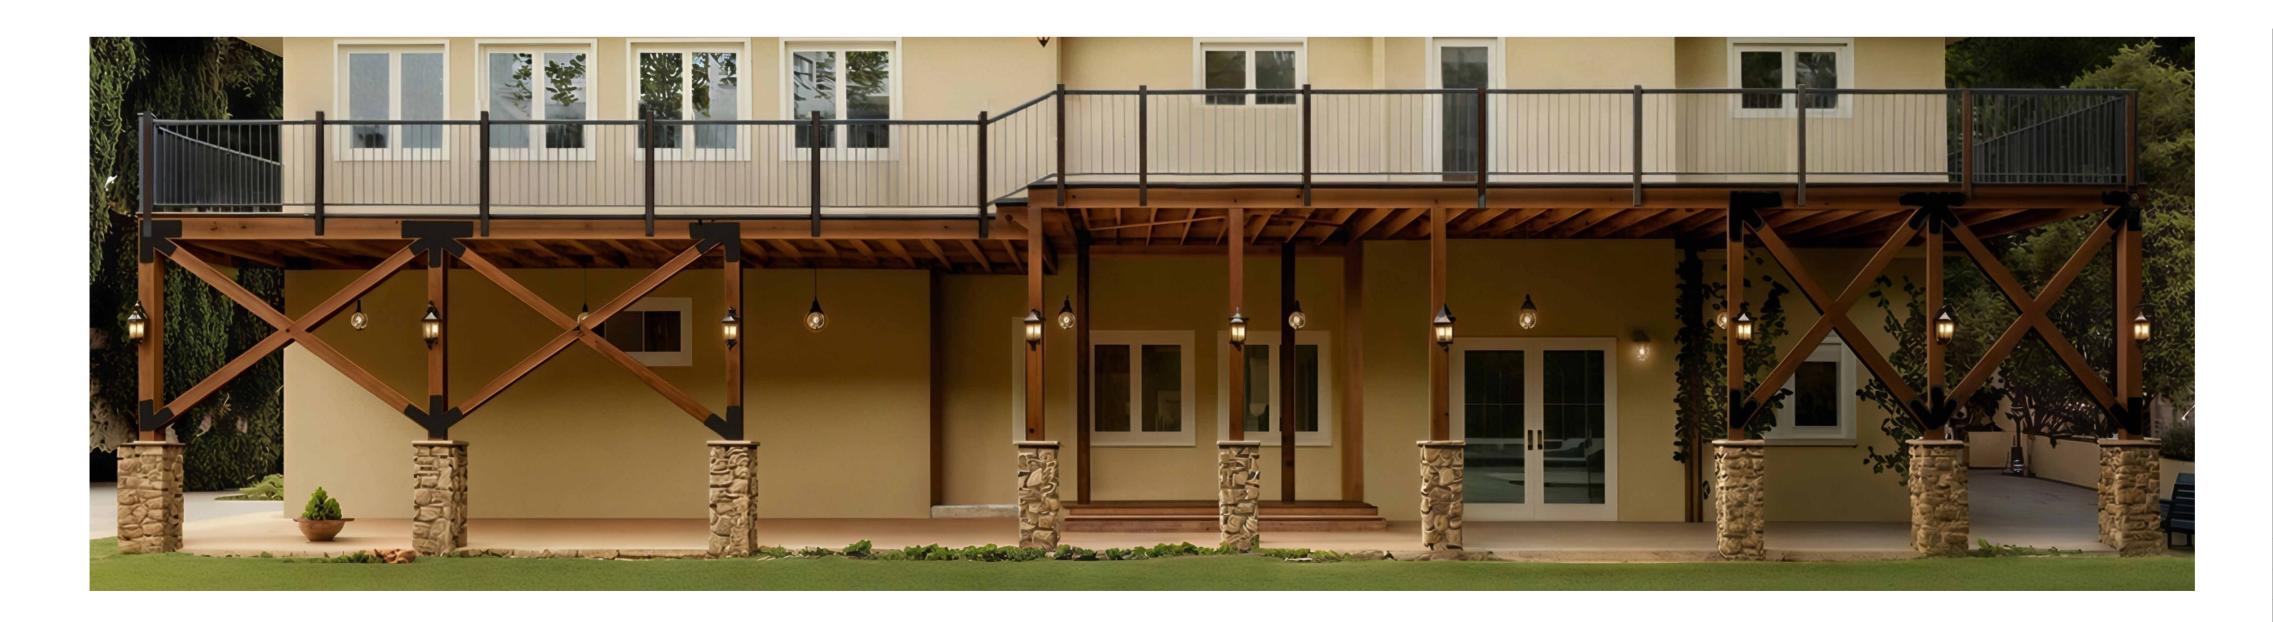

DATE & APPROVAL

Lighting Layout Elevation

8			
7			VALUE ENGINEERING REVISIONS
6			ISSUED FOR ISSUANCE OF PERMIT
5			ISSUED FOR PRICING
4			ISSUED FOR PERMIT
3	С	2025-08-18	ISSUED FOR OWNER REVIEW
2	В	2025-08-05	ISSUED FOR OWNER REVIEW
1	Α	2025-07-21	ISSUED FOR OWNER REVIEW
IS	RE	DATE	DESCRIPTION

Project number 1

Date 2025-08-18

Drawn by Zen Life Design

Checked by Adam Morgenthaler

EL-03