

## **CONTRA COSTA COUNTY**

## **AGENDA - PUBLISHED**

## **Alamo Municipal Advisory Council**

Tuesday, June 3, 2025

6:00 PM

Alamo Women's Club - 1401 Danville Blvd., Alamo

Agenda Items: Items may be taken out of order based on the business of the day and preference of the Council.

- 1. Roll Call and Introductions
- 2. Staff Reports
- 3. Public comment on any item under the jurisdiction of the Council and not on this agenda (speakers may be limited to two minutes).

**4.** CDVR24-01005 **25-2079** 

Attachments: CDVR25-01005 - 1524 Manning

Design Review Rev 0509-1524 Manning Ln Planset

- 5. Contra Costa County Proposed Tree Ordinance Comments
- 6. Livorna Park Play Structure Design
- 7. Subcommittee Reports
- 8. Consent Calendar
- 9. Comments by Members of the MAC
- 10. Future Agenda Items
- 11. The next meeting is currently scheduled for scheduled for August 5, 2025.
- 12. Adjourn

The Council will provide reasonable accommodations for persons with disabilities planning to attend the Council meetings. Contact the staff person listed below at least 72 hours before the meeting. Any disclosable public records related to an open session item on a regular meeting agenda and distributed by the County to a majority of members of the Council less than 96 hours prior to that meeting are available for public inspection at 309 Diablo Road, Danville, during normal business hours. Staff reports related to items on the agenda are also accessible online at www.contracosta.ca.gov. If the connection is not reestablished, the committee will continue the meeting in person without remote access. Public comment may be submitted via electronic mail on agenda items at least one full work day prior to the published meeting time.

For Additional Information Contact: Cameron Collins at Cameron.Collins@bos.cccounty.us or 925.655.2300.



## CONTRA COSTA COUNTY

1025 ESCOBAR STREET MARTINEZ, CA 94553

#### Staff Report

File #: 25-2079 Agenda Date: 6/3/2025 Agenda #: 4.

Advisory Board: Alamo Municipal Advisory Council

Subject: CDVR25-01005 - 1524 Manning

Contact: Everett Louie, <a href="mailto:Everett.Louie@dcd.cccounty.us">Everett.Louie@dcd.cccounty.us</a>

#### Information:

The applicant requests a variance, tree permit and small lot design review for the demolition of an existing single-family located at a 13'-2" secondary frontage (where 20' is the minimum), and a 27' side yard aggregate (where 35' is the minimum) and a 5' side yard minimum (where 15' side yard is the minimum) and a tree permit to work within the dripline of a 60" tree (vacant lot) and a small lot design review for the construction of a 5,202 square foot new single family residence on a substandard parcel size.

Recommendation(s)/Next Step(s):

The Alamo MAC is a recommending body only.

## **CONTRA COSTA COUNTY DEPARTMENT OF CONSERVATION AND DEVELOPMENT**

COMMUNITY DEVELOPMENT DIVISION

30 Muir Road

Martinez, CA 94553-4601 Phone: 925-655-2700 Fax: 925-655-2758



## **AGENCY COMMENT REQUEST**

Ve request your comments regarding the attached applic	Date 02/04/2025cation currently under review.
DISTRIBUTION  INTERNAL  ✓ Building Inspection Grading Inspection Advance Planning Housing Programs Trans. Planning Telecom Planner ALUC Staff HCP/NCCP Staff County Geologist  HEALTH SERVICES DEPARTMENT  ✓ Environmental Health Hazardous Materials  PUBLIC WORKS DEPARTMENT  Engineering Services Special Districts Traffic Flood Control (Full-size)  LOCAL  ✓ Fire District  ✓ San Ramon Valley – (email) rwendel@srvfire.ca.gov Consolidated – (email) fire@cccfpd.org  ✓ Sanitary DistrictCentral San  ✓ Water District  EBMUD  City of School District(s)  LAFCO  Reclamation District #  East Bay Regional Park District Diablo/Discovery Bay/Crockett CSD  ✓ MAC/TAC Alamo	
<ul> <li>✓ Improvement/Community Association</li> <li>✓ CC Mosquito &amp; Vector Control Dist (email)</li> <li>OTHERS/NON-LOCAL</li> <li>CHRIS (email only: nwic@sonoma.edu)</li> <li>CA Fish and Wildlife, Region 3 – Bay Delta</li> <li>Native American Tribes</li> <li>ADDITIONAL RECIPIENTS</li> <li>AIA</li> </ul>	Print Name



## **Planning Application Summary**

County File Number: CDVR25-01005 File Date: 2/4/2025

**Applicant:** 

Javaid Noorzad javaid.m.noorzad@kp.org 1524 MANNING LN (510) 458-4777

ALAMO, CA 94507

**Property Owner:** 

JAVAID & JOCELY NOORZAD javaid.m.noorzad@kp.org

1524 MANNING LN (510) 458-4777

ALAMO, CA 945071028

#### **Project Description:**

The applicant requests a variance, tree permit and small lot design review for the demolition of an existing single-family located at a 13'-2" secondary frontage (where 20' is the minimum), and a 27' side yard aggregate (where 35' is the minimum) and a 5' side yard minimum (where 15' side yard is the minimum) and a tree permit to work within the dripline of a 60" tree (vacant lot) and a small lot design review for the construction of a 5,202 sf new single family residence on a substandard parcel size.

Project Location: (Address: 1524 MANNING LN, ALAMO, CA 945071028), (APN: 191040028)

**Additional APNs:** 

**General Plan Designation(s):** RL **Zoning District(s):** R-20

Flood Hazard Areas: X AP Fault Zone:

60-dBA Noise Control: MAC/TAC:


Sphere of Influence: Fire District: SAN RAMON VLY FIRE

Sanitary District: CENTRAL SANITARY Housing Inventory Site: NO

**Specific Plan:** 

Fees:				
Fee Item	Description	Account Code	Total Fee	Paid
052B	Notification Fee (\$30)	002606-9660-REV-000-5B052B	30.00	30.00
VRS0044	Zone Variance - DCD	002606-9660-REV-000-5B0044	3250.00	3250.00
		Total:	3280.00	3280.00

## Aerial

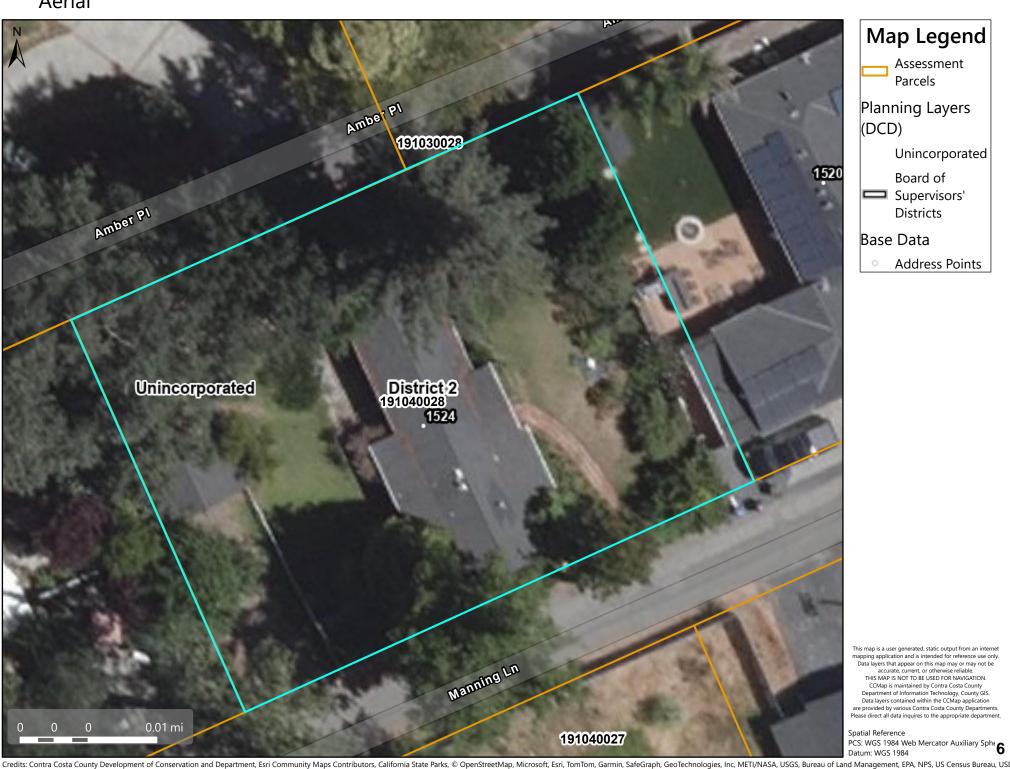

Map Legend

Assessment Parcels

Planning Layers (DCD)

Unincorporated

Board of Supervisors' Districts

Base Data


**Address Points** 

This map is a user generated, static output from an internet mapping application and is intended for reference use only. Data layers that appear on this map may or may not be accurate, current, or otherwise reliable.

THIS MAP IS NOT TO BE USED FOR NAVIGATION. CCMap is maintained by Contra Costa County Data layers contained within the CCMap application are provided by various Contra Costa County Departments. Please direct all data inquires to the appropriate department.

Spatial Reference PCS: WGS 1984 Web Mercator Auxiliary Sph



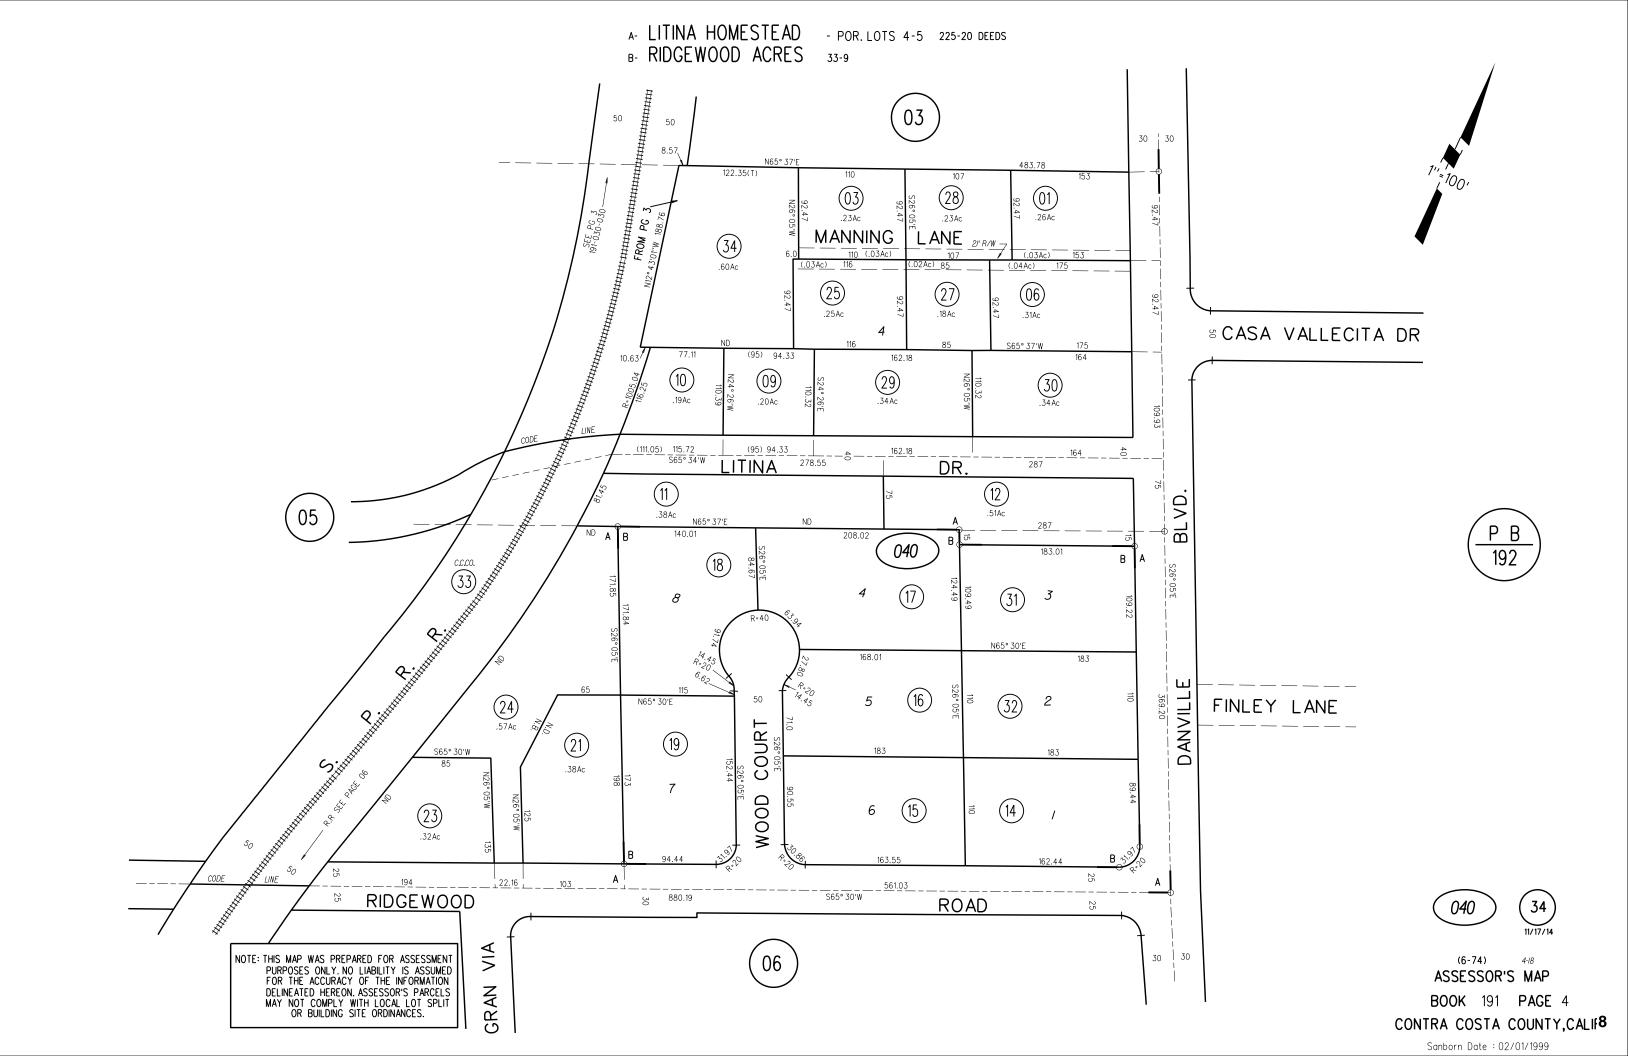

## Zoning - R-20 Map Legend Assessment Parcels Planning Layers (DCD) 191030028 Zoning ZONE\_OVER R-20 (Single Family Residential) Unincorporated Board of Supervisors Districts Base Data **Address Points** District 2 191040028 Unincorporated R-20 This map is a user generated, static output from an internet mapping application and is intended for reference use only. Data layers that appear on this map may or may not be accurate, current, or otherwise reliable. THIS MAP IS NOT TO BE USED FOR NAVIGATION. CCMap is maintained by Contra Costa County Department of Information Technology, County GIS. Data layers contained within the CCMap application are provided by various Contra Costa County Departments. Please direct all data inquires to the appropriate department. Spatial Reference 191040027 PCS: WGS 1984 Web Mercator Auxiliary Sphe



# VICINITY MAP

**ABBREVIATIONS** 

AC: Air Conditioning, Acoustical

ADJ: Adjust, Adjustable, Adjacent

AGA: American Gas Association

ALT: Alternate, Alteration; Altitude

AFF: Above Finished Floor

&: And

ABV: Above

ADH: Adhesive

BR: Bedroom,

CLO.: CLEAN-OUT

CSMT: CASEMENT

ELEC.: ELECTRICAL

GC: General Contractor

GPH: Gallons Per Hour

GYP BD: Gypsum Board

GFCI: Ground Fault Circuit Interrupted

GA: Gauge, Gage

CLG: Ceiling

DTL. DETAIL

E: EXISTING

GAL: Gallon

GLZ: Glaze

GVL: Gravel

GYP: Gypsum

INSTL.: Install

PNL.: PANEL

OPT.: OPTIONAL

SH: SINGLE HUNG

N: NEW

@: At

# PROJECT SITE

## PROJECT DIRECTORY

Owner: Javaid and Jocelyn Noorzad 1524 Manning Ln., Alamo, CA 94507 Email: jocelynnoorzad@gmail.com Phone #: 510-600-5100

Architect: LNX Architecture inc. Address: 6710 Corte Snata Maria, Pleasanton, CA 94566 Responsible Person: Yuan Lin, Architect Phone#: 925 357 5801

# **CODE COMPLIANCE:**


Email: yuanlin29@yahoo.com


2022 CBC,CMC,CPC,CEC, CRC, CFC 2022 CAL GREEN STANDARDS 2022 CALIFORNIA ENERGY CODE CONTRA COSTA CO. CODES/ORDINANCES


# DRAWING DIRECTORY

WORK POINT, CONTROL POINT OR DATUM POINT INDICATION - DETAIL NUMBER NOTALL CUT INDICATOR SHEET LOCATION

GRAPHIC SYMBOL LEGEND

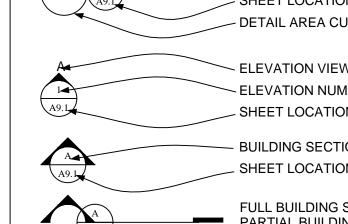


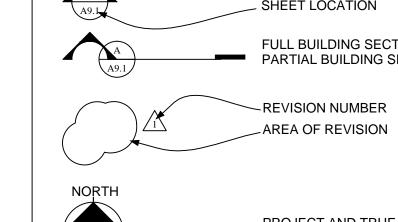

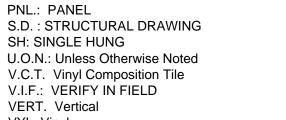

V.I.F.: VERIFY IN FIELD VERT. Vertical VYL. Vinyl WD. Wood WDW. Window W.P.M Water Proofing Membrane WT. Weight YD. Yard

- DETAIL AREA CUT - ELEVATION VIEW **ELEVATION NUMBER** SHEET LOCATION **BUILDING SECTION LETTER** SHEET LOCATION FULL BUILDING SECTION PARTIAL BUILDING SECTION

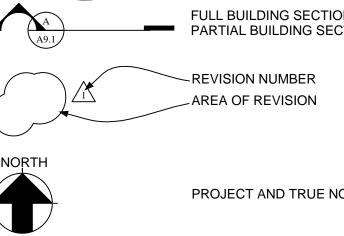

PROJECT AND TRUE NORTH WINDOW AND DOOR SIZE TAG:

SHEET NOTES TAG DOOR TAG, SEE WINDOW/DOOR SCHEDULE WINDOW TAG, SEE WINDOW/DOOR SCHEDULE

3'-0'X5'-0"

A-1.1 COVER SHEET AND SITE PLAN A-2.1 1ST FLOOR PLAN A-2.2 2ND FLOOR PLAN

A-2.3 ROOF PLAN A-3.1 ELEVATIONS & SECTION A-3.2 ELEVATIONS & SECTION G-1 SURVEY MAP

1). Expand (E) house of 1140 sf to 1876 sf on 1st floor

SCOPE OF WORK:

to accomodate open living/dining/kitchen and foyer. 2). Expand (E) garage to accomodate extra storage and

3). Add 2nd story to accomodate 4 bedrooms/ 4 baths 4). Install new 400AMP electrical panel, heat pump water heater and ducted AC unit;

5). Install new fire sprinkler system, permit separately; 6). Modify (E) driveway and front yard landscaping.

## PROJECT INFO.

LOCATION: 1524 Manning Ln., Alamo, CA 94507 APN: 191-040-028-0 **ZONING:** R-20 LOT SIZE: CONSTRUCTION TYPE: TYPE V/B; SPRINKLERED OCCUPANCY GROUP: R-3/U(garage) (E) HOUSE: (E) LIVING AREA: 1140 SF (E) GARAGE AREA: 488 SF (E) BUILDING FOOT PRINT 1745 SF

(N) ADDITION: (N) 1ST FLOOR: 1876 SF (N) 2ND FLOOR: 2332 SF (N) TOTAL MAIN HOUSE LIVING AREA: 4208 SF (N) GARAGE AREA: 673 SF (N) COVERED FRONT PORCH: 202 SF

LOT COVERAGE: 2751/ 9889 = 27.8% FAR(FLOOR AREA RATIO): 4208/ 9889 = 42.5%

FIRE SPRINKLERS: YES, DEFERRED SUBMITTAL OF NFPA 13D 2019 APPROVED FIRE SPRINKLER SYSTEM PER SMC 16.17.080

# **NEW ADDITION** (E) LANDSCAPING TO REMAIN 22'-0" (E) HOUSE SIDE SETBACK SETBACK **FOOTPRINT** 10,6 1/2" ິ17'−3" PLANTER TORM DRAIN EASEMENT /EX. VIILITY POLÉ /107.00<sup>\*</sup>/\$66°53'54"W $\langle \alpha \rangle$

BUILDING OUTLINE

PROPERTY LINE 107'

(E) LANDSCAPING

-(E) GARAGE-**FOOTPRINT** 

N66°53'54"E

\_(È)-WALL TO REMAIN

SIDE PATIO

APN NO.: 191-040-028

**RECEIVED** on 2/4/2025 CDVR25-01005 Department of Conservation and Development



MANNING LANE

## SITE PLAN NOTES

1. SEE GENERAL NOTES ON A2.1 FOR ADDITIONAL INFORMATION 2. THE SITE PLAN IS NOT A SURVEY. IT IS PROVIDED FOR BUILDING AND LIMITED SITE PLAN LAYOUT ONLY. THE CONTRACTOR SHALL VERIFY IN FIELD ALL GRADES, EXISTING IMPROVEMENTS, PROPERTY LINES AND SETBACKS, EASEMENTS, UTILITIES AND SUBSTRUCTURES. SITE SPECIFIC SOILS REPORTS AND CIVIL DRAWINGS SHALL TAKE PRECEDENCE OVER NOTES AND DETAILS ON THIS SET OF

3. THIS PLAN IS NOT A GRADING AND DRAINAGE OR EROSION CONTROL PLAN. CONSULT A CIVIL ENGINEER FOR SUCH INFORMATION. 4. DISPLACED TOP SOIL SHALL BE STOCKPILED FOR REUSE IN A DESIGNATED AREA AND COVERED

OR PROTECTED FROM EROSION 5. ALL GRADING, SITE PREPARATION, PLACEMENT AND COMPACTION OF FILL IS TO BE DONE IN ACCORDANCE WITH THE COUNTY OF CONTRA COSTA. GRADING ORDINANCE AND ALSO UNDER THE OBSERVATION OF THE GEOTECHNICAL ENGINEER.

6. AT A MINIMUM, THE PAD GRADE UNDER BUILDING SHALL HAVE POSITIVE SLOPE TO A MINIMUM OF ONE AREA DRAIN WHICH SHALL BE PIPED TO STREET(OR OTHER SUITABLE DISCHARGE POINT DETERMINED BY THE CIVIL ENGINEER AND/OR LOCAL GOVERNING AUTHORITY ), VIA A

NON-CORROSIVE DEVICE. 7. ALL FOUNDATION PERIMETER AND ROOF DRAINAGE SHALL BE PIPED TO STREET OR APPROVED DISCHARGE SYSTEM.

8. IRRIGATION SYSTEM SHALL BE DESIGNED TO PREVENT SATURATION OF SOIL ADJACENT TO THE BUILDING, STRUCTURES, OR UTILITY BOXES

9. SEE LANDSCAPE OR CIVIL DRAWINGS FOR ALL SITE AND HARDSCAPE DRAIN 10. WATER SHOULD BE PREVENTED FROM PONDING ANYWHERE ON THE LOT PARTICULARLY NEAR THE HOUSE. WATERFROM DOWN SPOUTS AND YARD DRAINS SHOULD BE CONNECTED TO TIGHTLINE PIPES THAT CARRY THE WATER TO AVAILABLE DISCHARGE FACILITIES. REFER TO A-4 CALGREEN

11. CRAWL SPACES SHOULD BE GRADED IN SUCH A WAY THAT WATER WHICH MAY STILL ENTER THE CRAW SPACE FLOWS TO A LOW POINT WHERE IT CAN BE PIPED BENEATH THE PERIMETER FOUNDATION (GRADE BEAM OR "T" FOOTING ) AND DISCHARGED.

12. AT ALL RETAINING WALLS, LANDSCAPE WALLS OR CLOSE PROXIMITY TO STRUCTURES, PROTECTIVE SUB DRAINAGE SHALL BE INSTALLED BENEATH THE FILLS IN THE SWALE AREAS. THE SUB DRAINS SHOULD CONSIST OF A BLANKET OR TRENCH FILLED WITH CLASS TWO PERMEABLE MATERIAL AND HAVING A WIDTH OF AT LEAST 18 INCHES. THE SUB DRAINS SHOULD HAVE A VERTICAL HEIGHT OF 4 FEET AND SHOULD BE INSTALED AT THE BACK OF THE LOWEST ELEVATION POSSIBLE TO PERMIT DAYLIGHT DRAINAGE ON THE PROPERTY(OR TO AN APPROVED DISCHARGE SYSTEM). ENDS OF PIPES SHALL BE RIP RAPPED SO THEY WILL NOT BECOME BLOCKED IN THE FUTURE. SLD. AND SEE CIVIL AND LANDSCAPE PLUS SEE DETAILS FOR ANY REQUIRED WATERPROOFING ALONG THE VERTICAL FACE OF ANY BURIED WALLS. 13. THE CONTRACTOR IS RESPONSIBLE FOR KEEPING A SET OF CURRENT, THOROUGH, AND ACCURATE AS-BUILT DRAWINGS AT THE PROJECT SITE.

14. ALL WATER USE SHALL BE METERED EXCEPT FOR USE IN DISINFECTION AND FLUSHING OF WATER MAINS.

15. NO WATER VALVES ON THE EXISTING SYSTEM NOR ANY NEW VALVE CONNECTED TO THE EXISTING SYSTEM SHALL BE OPENED OR CLOSED BY ANYONE EXCEPT AUTHORIZED WATER DEPARTMENT PERSONNEL.

16. MAINTAIN, SECURE, AND PROTECT ANY EXISTING WATER SYSTEM FACILITY IN PLACE UNTIL THE PROPOSED WATER SYSTEM IS COMPLETED AND ACTIVATED. 17. PARTS FROM ABANDONED CITY FACILITIES, INCLUDING METERS AND VALVES, SHALL BE

RETURNED TO THE WATER DEPARTMENT INSPECTOR. 18. NO EXISTING OR NEW UTILITY METERS OR VAULTS SHALL BE LOCATED WITHIN THE NEW DRIVEWAY APPROACH. ALL EXISTING OR NEW UTILITY VAULTS SERVING THE PROJECT SITE SHALL BE LOCATED ON-SITE AND NOT WITHIN THE PUBLIC UTILITY EASEMENT, IF ANY.

HITECTURE



**REVISIONS** 

PROJECT NAME

SHEET NAME **COVER SHEET** & SITE PLAN

5

DATE: 06/11/2024

SCALE: AS SHOWN

SHEET NO.



HITECTURE



REVISIONS

PROJECT NAME

1524 MANNING LN., ALAMO, CA A HOME EXPANSION PROJECT

DATE: 06/11/2024 SCALE: AS SHOWN SHEET NAME

1ST FLOOR PLAN

SHEET NO.

A-2.1

	FIXTURE TYPE	# OF FIXTURE	FLOW RATE		
	W.C .	4	1.28 GL/FLUSH		
	LAV.	6	1.2 GPM@60psi		
	SHOWERHEAD	3	1.8 GPM@80psi		
	TUB FAUCET	2	1.8 GPM@80psi		
	KITCHEN SINK	1	1.8 GPM@60psi		
	LAUNDRY SINK	1	1.8 GPM@60psi		

PROPOSED 1ST FLOOR PLAN

# WINDOW / DOOR NOTES

SH SINGLE HUNG
DH DOUBLE HUNG
SLD SLIDING DOOR
SLW SLIDING WINDOW
AWN AWNING WINDOW
FX FIXED WINDOW
PKD POCKED DOOR
CSM CASEMENT WINDOW
COM COMBINATION WINDOWS
STK STACKED WINDOW
3080 3'-0"X8'-0"
2680 2'-6"X8'-0"
OPT. OPTIONAL
TEMPERED GLASS

PROPOSED 2ND FLOOR PLAN

SCALE: 1/4"=1'-0"

ЦХ

ARCHITECTURE INC.
6710 CORTE SANTA MARIA PLEASANTON, CA 94566



REVISIONS

PROJECT NAME

1524 MANNING LN., ALAMO, CA A HOME EXPANSION PROJECT

DATE: 06/11/2024
SCALE: AS SHOWN
SHEET NAME

2ND FLOOR PLAN

SHEET NO.

A-2.2

CLASS A ROOF COVERING SHALL BE

MANUFACTURER: OWENS CORNING ROOFING OR EQUAL QUALITY PRODUCT

COMP. SHINGLE ROOFING FOR SLOPED ROOF

COLOR:

GUTTERS ON ALL ELEVATIONS SHALL BE PROFILED ALUMINUM GUTTERS BY AMERIMAX OR

ROOF PITCH SHALL BE AS NOTED ON ROOF PLAN

OVERHANG DIMENSIONS SHALL BE AS NOTED ON ROOF PLAN

DASHED LINES INDICATE WALL(STRUCTURE) BELOW.

LOCATE GUTTERS AND DOWNSPOUTS AS SHOWN. NOTE: LOCATE DOWNSPOUTS MIN. 8" OFF CORNER WHERE POSSIBLE (U.O.N.)

ALL ROOF DRAINAGE SHALL BE PIPED TO STREET OR APPROVED DRAINAGE FACILITY.

ALL PLUMBING VENTS SHALL BE COMBINED INTO A MINIMUM AMOUNT OF ROOF PENETRATIONS. ALL ROOF PENETRATIONS SHALL OCCUR TO THE REAR OF THE MAIN RIDGE (WHERE POSSIBLE) SEE DETAIL 11 /A-4.1


ATTIC VENTILATION SHALL BE PROVIDED PER SECTION 1505.3 OF THE UBC. (SEE CALCULATIONS, THIS SHEET)

LOCATE UPPER AND LOWER ROOF VENTS AS SHOWN ON PLAN.

UNDERLAYMENT FOR ASPHALT SHINGLES SHALL COMPLY WITH ASTM D226 TYPE I; ASTM D4869 TYPE I,II,III OR IV; ASTM D6757, AND SHALL BEAR A LABEL INDICATING COMPLIANCE TO THE STANDARD DESIGNATION. (R905.1.1)

FLASH ALL ROOF VALLEYS (INSTALL FLASHING OVER 30# FELT)

ALL FLASHING SHALL BE 26 GAUGE G.S.M.

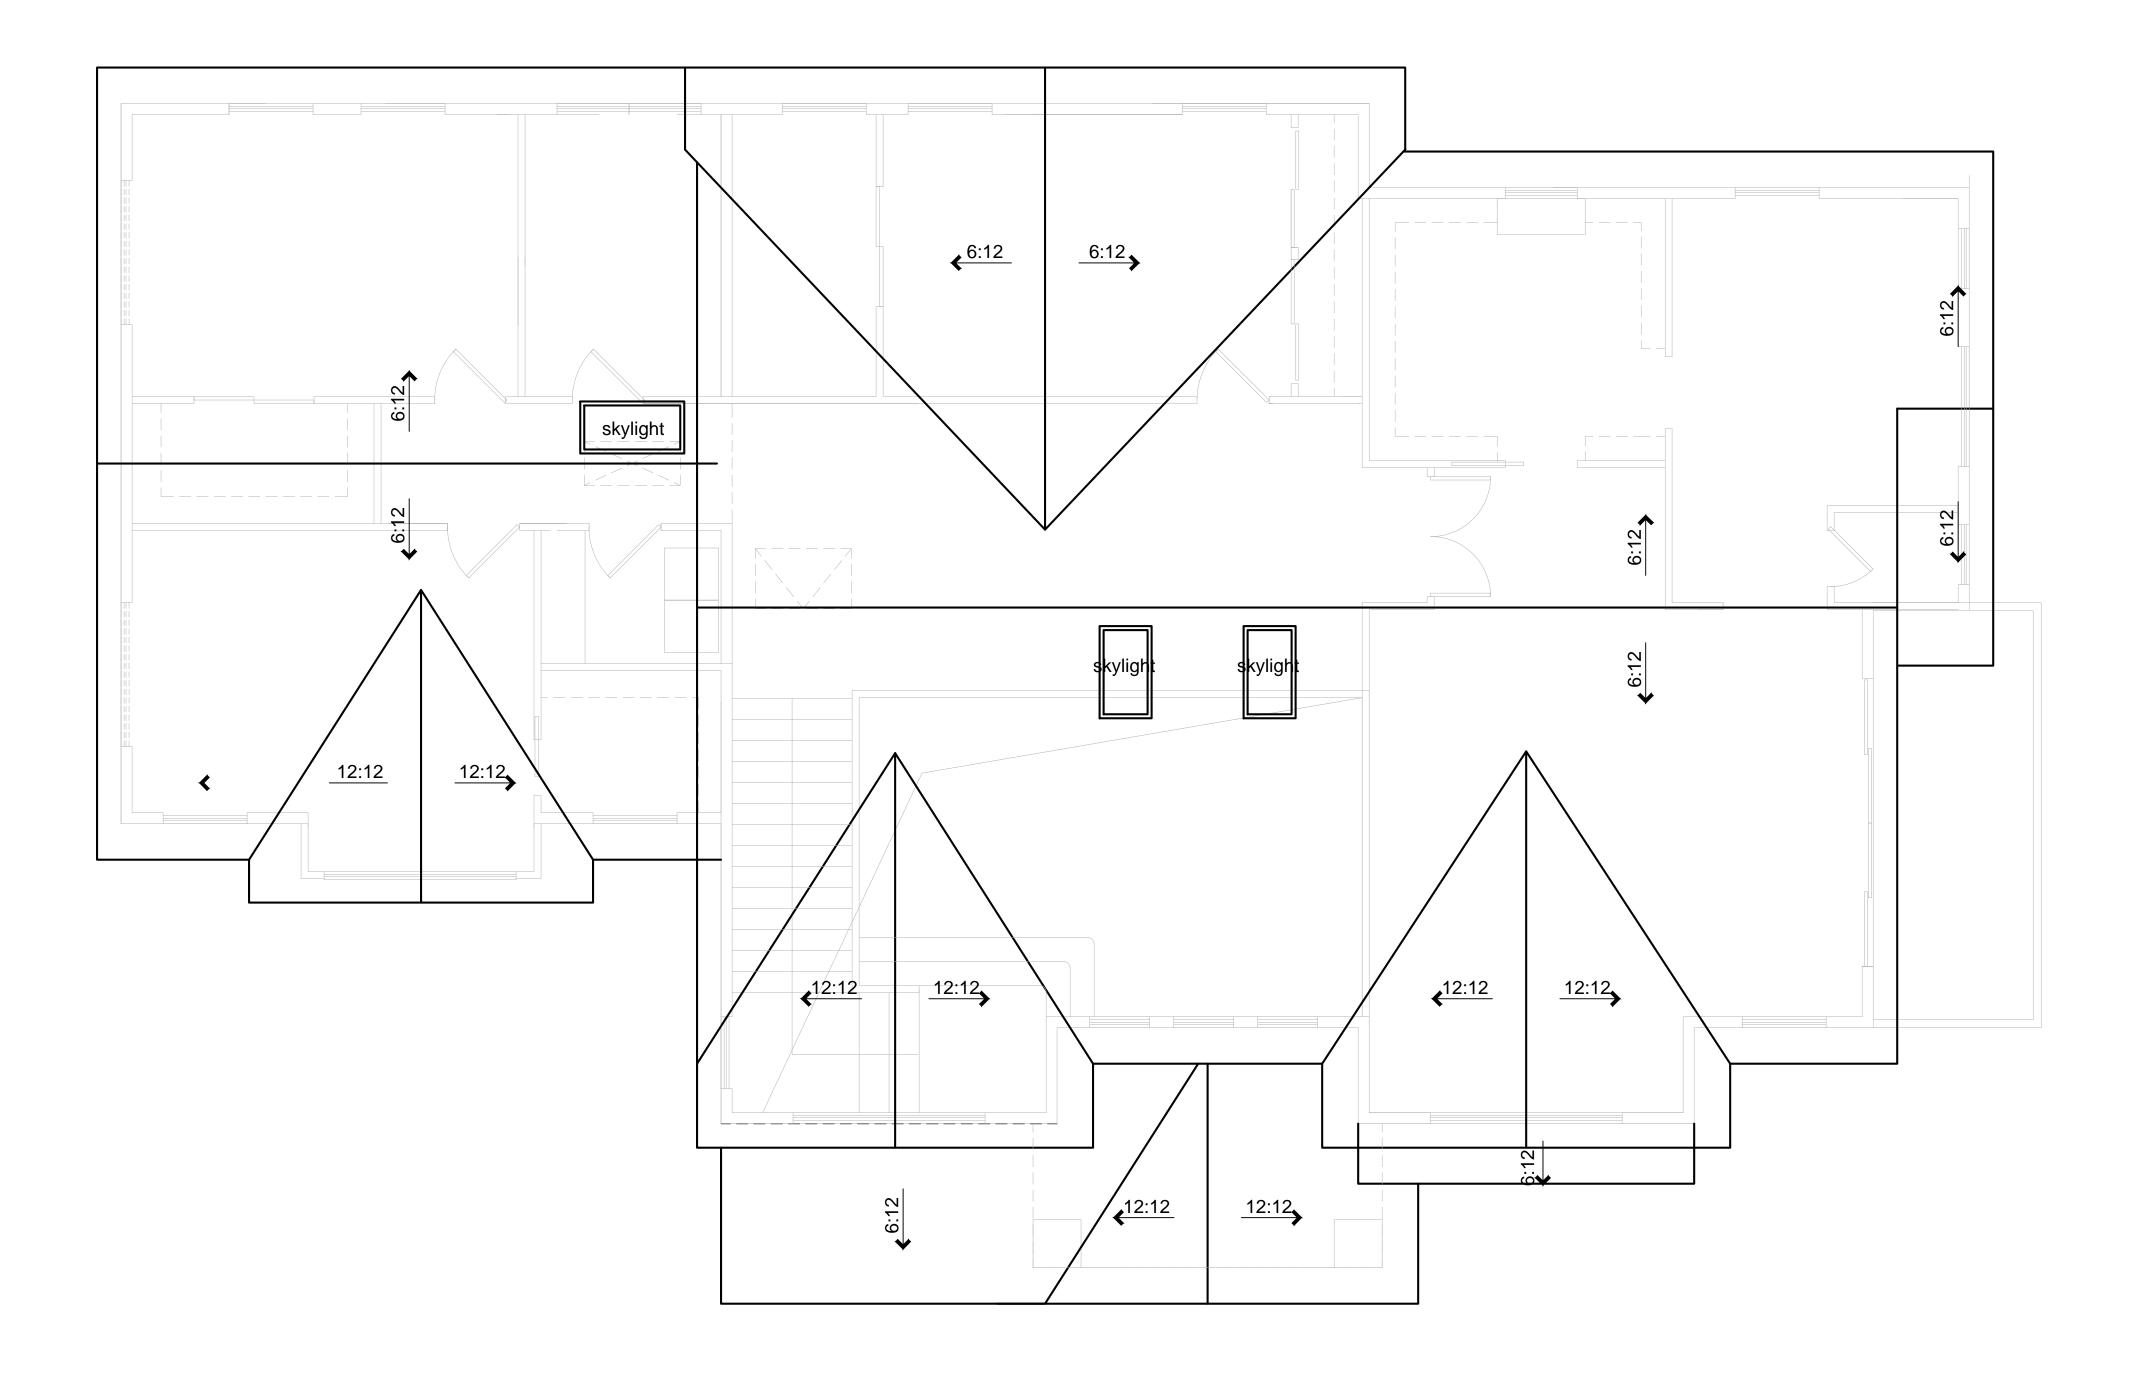

PROPOSED ROOF PLAN

SCALE: 1/4"=1'-0"



CHITECTURE



REVISIONS

PROJECT NAME

1524 MANNING LN., ALAMO, CA A HOME EXPANSION PROJECT

DATE: 06/11/2024 SCALE: AS SHOWN SHEET NAME

ROOF PLAN

SHEET NO.

A-2.3



RIGHT SIDE ELEVATION

SCALE: 1/4"=1'-0"

SCALE: 1/4"=1'-0"

**FOYER** 

BUILDING SECTION A-A

SCALE: 1/4"=1'-0"

KITCHEN

SCALE: 1/4"=1'-0"

A-3.1

DATE: 06/11/2024
SCALE: AS SHOWN
SHEET NAME


BUILDING
SECTIONS


SHEET NO.

A-3.2





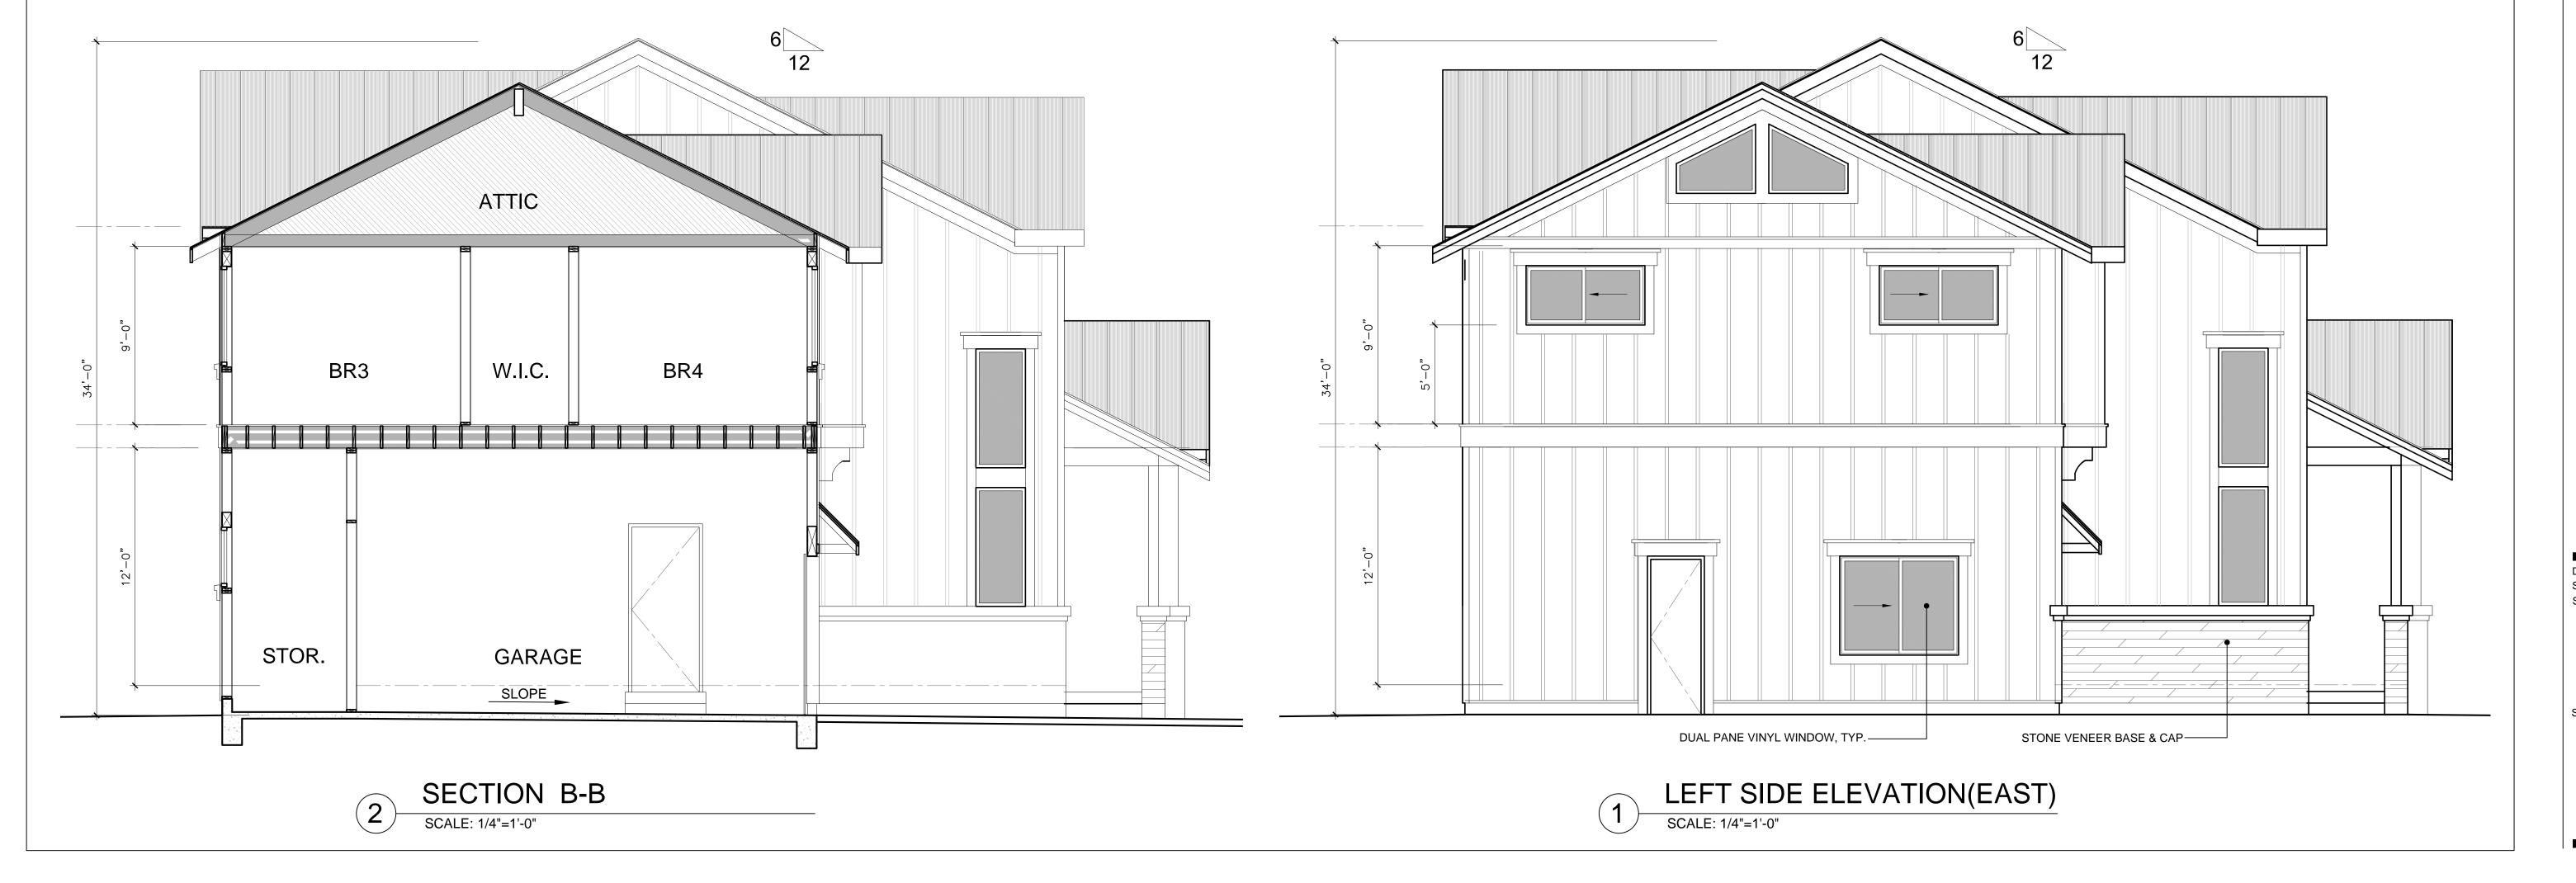

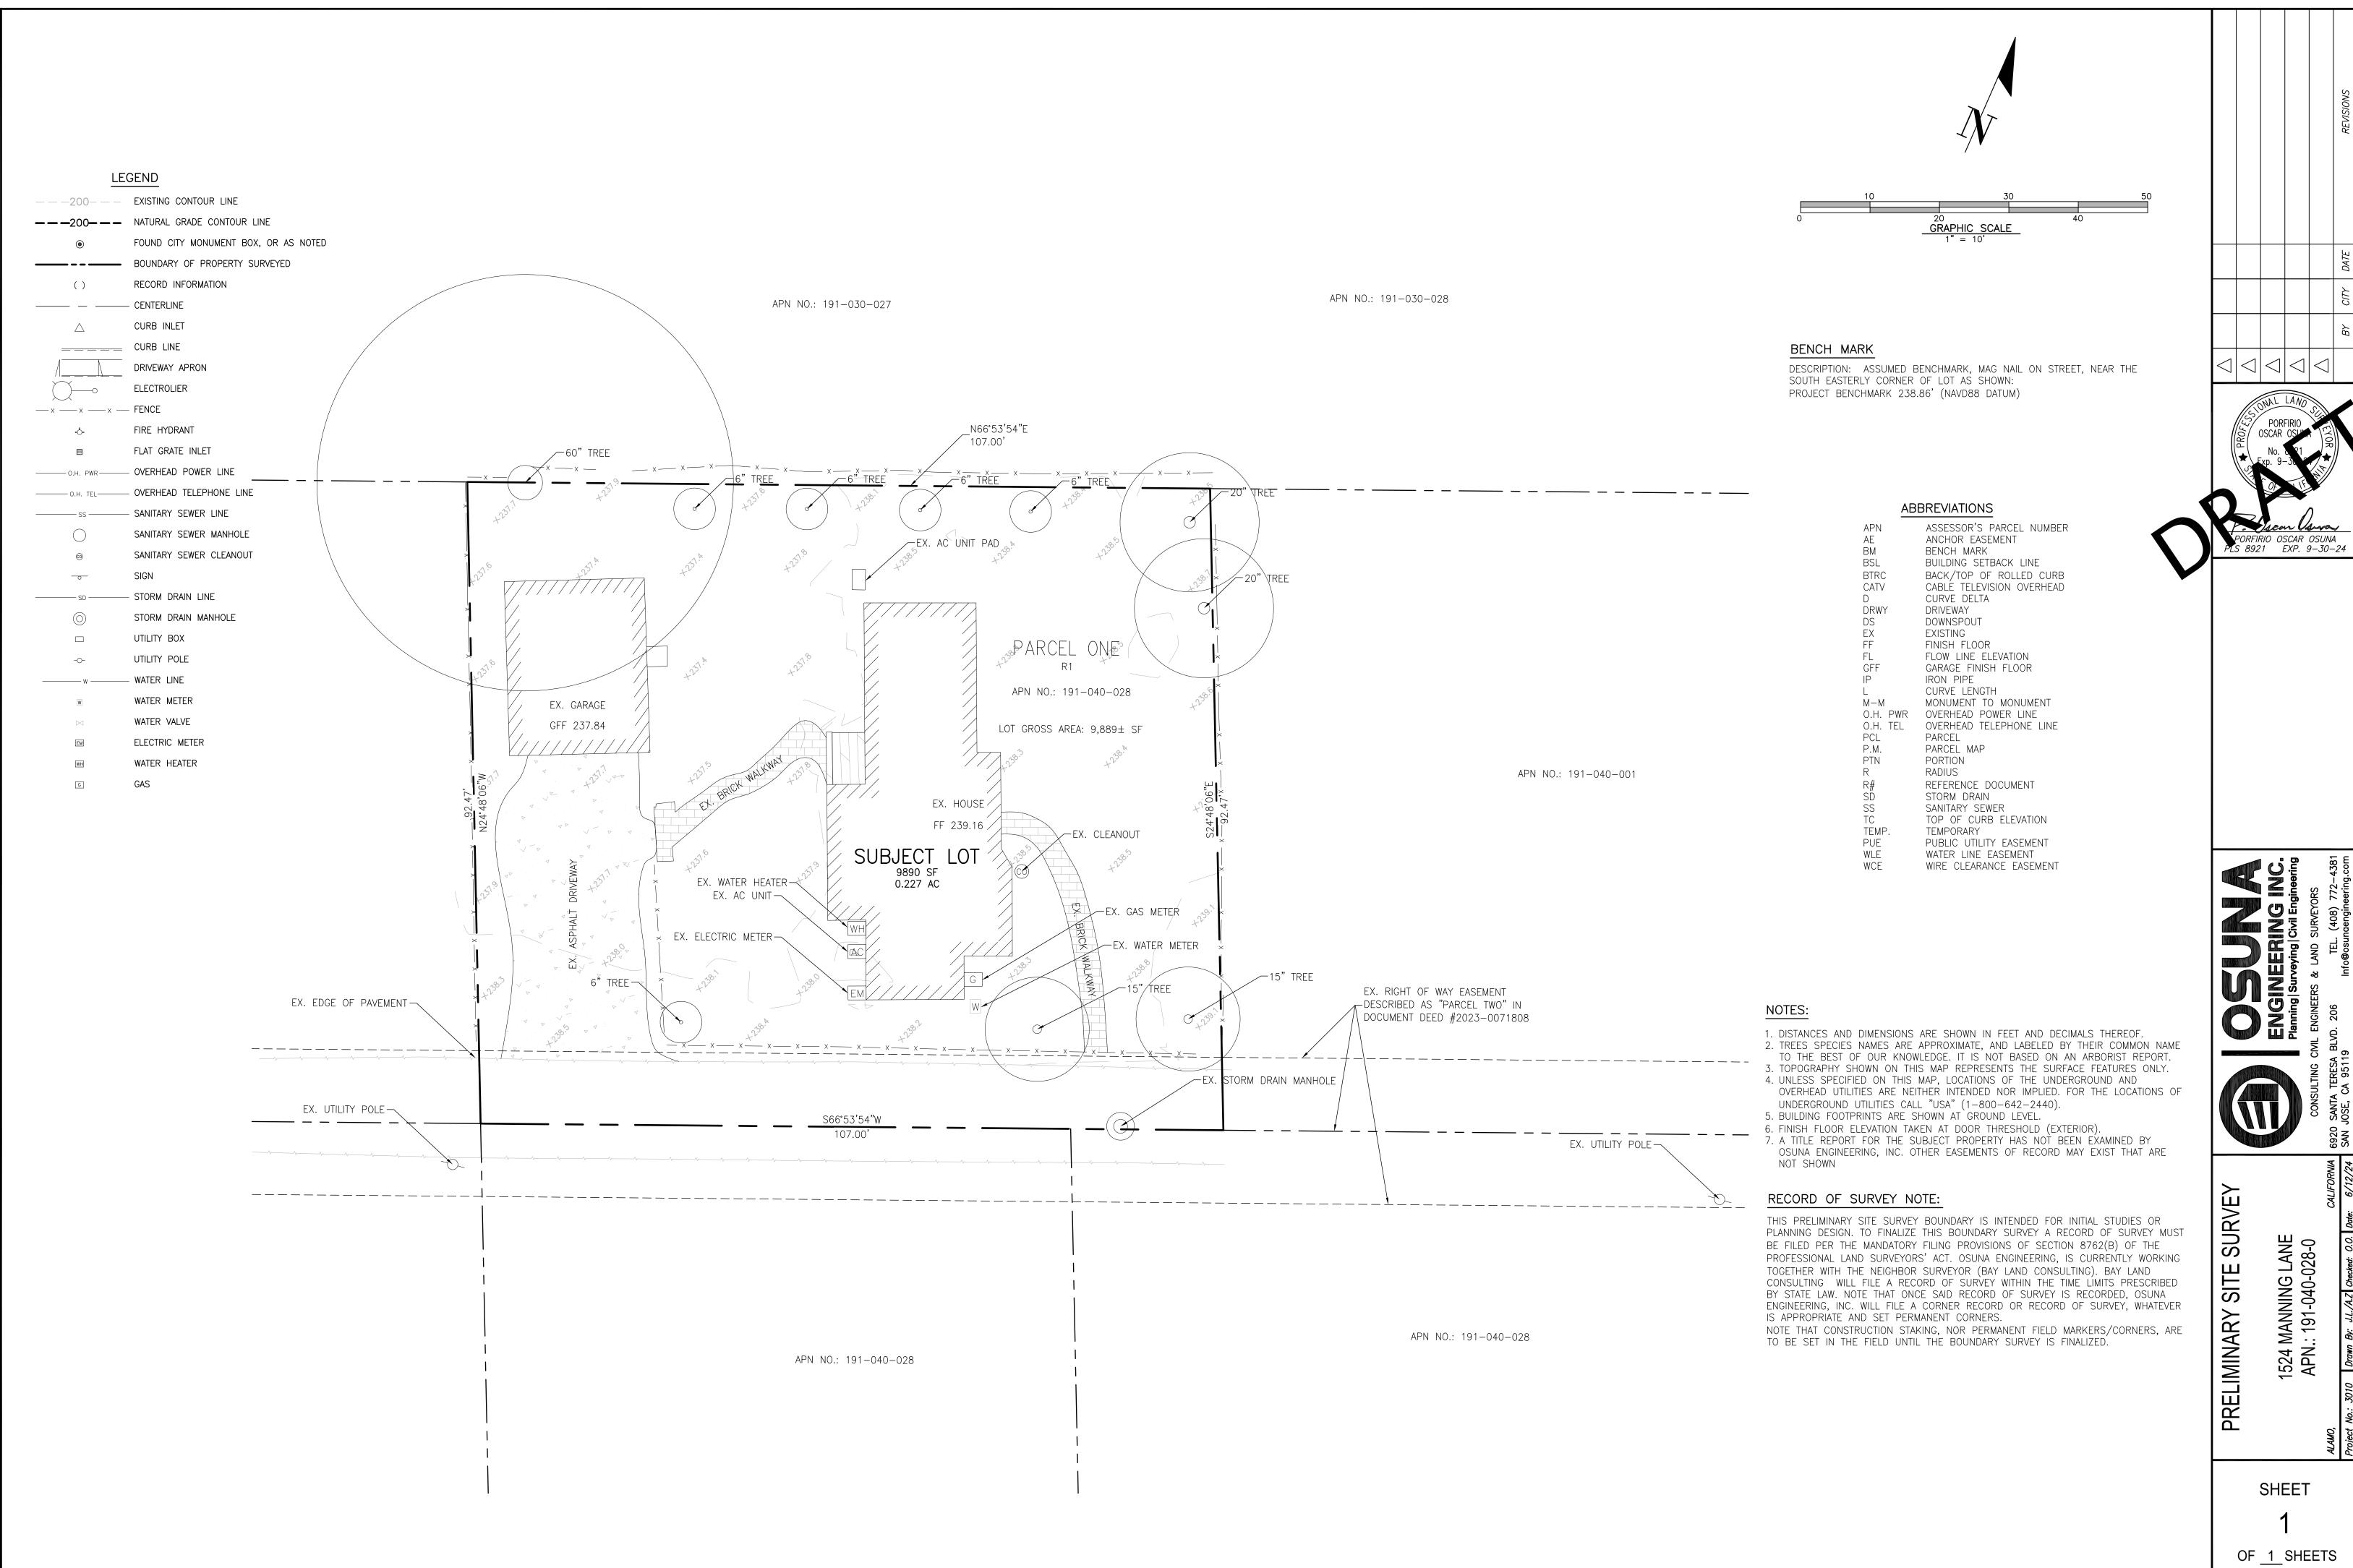

# 1524 MANNING LN., ALAMO A RESIDENTIAL EXPANSION PROJECT



# VICINITY MAP

**ABBREVIATIONS** 

AC: Air Conditioning, Acoustical

ADJ: Adjust, Adjustable, Adjacent

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AFF: Above Finished Floor

&: And

ABV: Above

ADH: Adhesive

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GLZ: Glaze

GVL: Gravel

GYP: Gypsum

INSTL.: Install

PNL.: PANEL

VYL. Vinyl

WD. Wood

WT. Weight

YD. Yard

N: NEW

@: At

# PROJECT SITE

## PROJECT DIRECTORY

Owner: Javaid and Jocelyn Noorzad 1524 Manning Ln., Alamo, CA 94507 Email: jocelynnoorzad@gmail.com Phone #: 510-600-5100

Architect: LNX Architecture inc. Address: 6710 Corte Snata Maria, Pleasanton, CA 94566 Responsible Person: Yuan Lin, Architect Phone#: 925 357 5801

# **CODE COMPLIANCE:**

Email: yuanlin29@yahoo.com

2022 CBC,CMC,CPC,CEC, CRC, CFC 2022 CAL GREEN STANDARDS 2022 CALIFORNIA ENERGY CODE CONTRA COSTA CO. CODES/ORDINANCES

# DRAWING DIRECTORY

WORK POINT, CONTROL POINT OR DATUM POINT INDICATION - DETAIL NUMBER NOTALL CUT INDICATOR

PROJECT AND TRUE NORTH

WINDOW AND DOOR SIZE TAG:

SEE WINDOW/DOOR SCHEDULE

SEE WINDOW/DOOR SCHEDULE

3'-0'X5'-0"


DOOR TAG,


WINDOW TAG,

SHEET NOTES TAG

SHEET LOCATION - DETAIL AREA CUT - ELEVATION VIEW **ELEVATION NUMBER** SHEET LOCATION **BUILDING SECTION LETTER** SHEET LOCATION

GRAPHIC SYMBOL LEGEND

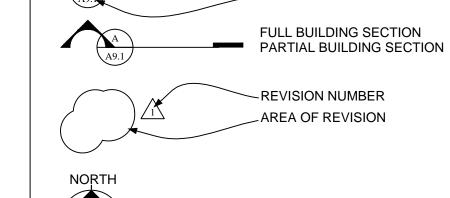

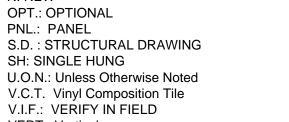

U.O.N.: Unless Otherwise Noted V.C.T. Vinyl Composition Tile V.I.F.: VERIFY IN FIELD VERT. Vertical WDW. Window

W.P.M Water Proofing Membrane

A-1.1 COVER SHEET AND SITE PLAN A-2.1 1ST FLOOR PLAN A-2.2 2ND FLOOR PLAN

A-2.3 ROOF PLAN A-3.1 ELEVATIONS & SECTION A-3.2 ELEVATIONS & SECTION G-1 SURVEY MAP

SCOPE OF WORK:

4). Install new 400AMP electrical panel, heat pump

5). Install new fire sprinkler system, permit separately; 6). Modify (E) driveway and front yard landscaping.

# PROJECT INFO.

LOCATION: 1524 Manning Ln., Alamo, CA 94507 APN: 191-040-028-0 **ZONING:** R-20 LOT SIZE: CONSTRUCTION TYPE: TYPE V/B; SPRINKLERED OCCUPANCY GROUP: R-3/U(garage) (E) HOUSE: (E) LIVING AREA: 1140 SF (E) GARAGE AREA: 488 SF

(E) BUILDING FOOT PRINT 1745 SF (N) ADDITION:

1741 SF (N) 2ND FLOOR: 2119 SF (N) TOTAL MAIN HOUSE LIVING AREA: 3860 SF 656 SF (N) GARAGE AREA: (N) COVERED FRONT PORCH: 82 SF

FIRE SPRINKLERS: YES, DEFERRED SUBMITTAL OF NFPA 13D 2019 APPROVED FIRE SPRINKLER SYSTEM

(N) 1ST FLOOR:

(N) COVERED SIDE PATIO: 272 SF

LOT COVERAGE: (1741+656+82+272)/ 9889 = 27.8% FAR(FLOOR AREA RATIO): 3860/ 9889 = 39%

PER SMC 16.17.080


1). Expand (E) house of 1140 sf to 1876 sf on 1st floor to accomodate open living/dining/kitchen and foyer. 2). Expand (E) garage to accomodate extra storage and

3). Add 2nd story to accomodate 4 bedrooms/ 4 baths water heater and ducted AC unit;

# ---- (E) HOUSE FOOTPRINT (E) EXTERIOR WALL TO REMAIN N66°53'54"E BUILDING OUTLINE PROPERTY LINE 107' (E) LANDSCAPING TO REMAIN WALL TO REMAIN 7'-6" -(E) ĠARAGE FOOTPRINT SIDE PATIO 191-040-028 **NEW ADDITION** SIDE SETBACK 23'-9 1/8" (E) LANDSCAPING TO REMAIN SÉTBACK (E) HOUSE **FOOTPRINT** BENCH (N) DRIVEWAY -EX. GAS METÆR ROOF LINE 12'-6 1/2" 10 6 1/2" 16'–9" 20'-6" **PLANTER** TORM DRAIN ZEX. NHLYTY POLÉ /107.00<sup>\*</sup>/\$66°53'54"W (X MANNING LANE

# SCALE: 1"=10'-0"

# SITE PLAN

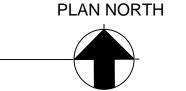

**LEGEND** 

## SITE PLAN NOTES

1. SEE GENERAL NOTES ON A2.1 FOR ADDITIONAL INFORMATION 2. THE SITE PLAN IS NOT A SURVEY. IT IS PROVIDED FOR BUILDING AND LIMITED SITE PLAN LAYOUT ONLY. THE CONTRACTOR SHALL VERIFY IN FIELD ALL GRADES, EXISTING IMPROVEMENTS, PROPERTY LINES AND SETBACKS, EASEMENTS, UTILITIES AND SUBSTRUCTURES. SITE SPECIFIC SOILS REPORTS AND CIVIL DRAWINGS SHALL TAKE PRECEDENCE OVER NOTES AND DETAILS ON THIS SET OF

3. THIS PLAN IS NOT A GRADING AND DRAINAGE OR EROSION CONTROL PLAN. CONSULT A CIVIL ENGINEER FOR SUCH INFORMATION. 4. DISPLACED TOP SOIL SHALL BE STOCKPILED FOR REUSE IN A DESIGNATED AREA AND COVERED

OR PROTECTED FROM EROSION 5. ALL GRADING, SITE PREPARATION, PLACEMENT AND COMPACTION OF FILL IS TO BE DONE IN ACCORDANCE WITH THE COUNTY OF CONTRA COSTA. GRADING ORDINANCE AND ALSO UNDER THE OBSERVATION OF THE GEOTECHNICAL ENGINEER.

6. AT A MINIMUM, THE PAD GRADE UNDER BUILDING SHALL HAVE POSITIVE SLOPE TO A MINIMUM OF ONE AREA DRAIN WHICH SHALL BE PIPED TO STREET(OR OTHER SUITABLE DISCHARGE POINT DETERMINED BY THE CIVIL ENGINEER AND/OR LOCAL GOVERNING AUTHORITY ), VIA A

NON-CORROSIVE DEVICE. 7. ALL FOUNDATION PERIMETER AND ROOF DRAINAGE SHALL BE PIPED TO STREET OR APPROVED DISCHARGE SYSTEM. 8. IRRIGATION SYSTEM SHALL BE DESIGNED TO PREVENT SATURATION OF SOIL ADJACENT TO THE

BUILDING, STRUCTURES, OR UTILITY BOXES 9. SEE LANDSCAPE OR CIVIL DRAWINGS FOR ALL SITE AND HARDSCAPE DRAIN 10. WATER SHOULD BE PREVENTED FROM PONDING ANYWHERE ON THE LOT PARTICULARLY NEAR THE HOUSE. WATERFROM DOWN SPOUTS AND YARD DRAINS SHOULD BE CONNECTED TO TIGHTLINE PIPES THAT CARRY THE WATER TO AVAILABLE DISCHARGE FACILITIES. REFER TO A-4 CALGREEN

11. CRAWL SPACES SHOULD BE GRADED IN SUCH A WAY THAT WATER WHICH MAY STILL ENTER THE CRAW SPACE FLOWS TO A LOW POINT WHERE IT CAN BE PIPED BENEATH THE PERIMETER FOUNDATION (GRADE BEAM OR "T" FOOTING ) AND DISCHARGED.

12. AT ALL RETAINING WALLS, LANDSCAPE WALLS OR CLOSE PROXIMITY TO STRUCTURES, PROTECTIVE SUB DRAINAGE SHALL BE INSTALLED BENEATH THE FILLS IN THE SWALE AREAS. THE SUB DRAINS SHOULD CONSIST OF A BLANKET OR TRENCH FILLED WITH CLASS TWO PERMEABLE MATERIAL AND HAVING A WIDTH OF AT LEAST 18 INCHES. THE SUB DRAINS SHOULD HAVE A VERTICAL HEIGHT OF 4 FEET AND SHOULD BE INSTALED AT THE BACK OF THE LOWEST ELEVATION POSSIBLE TO PERMIT DAYLIGHT DRAINAGE ON THE PROPERTY(OR TO AN APPROVED DISCHARGE SYSTEM). ENDS OF PIPES SHALL BE RIP RAPPED SO THEY WILL NOT BECOME BLOCKED IN THE FUTURE. SLD. AND SEE CIVIL AND LANDSCAPE PLUS SEE DETAILS FOR ANY REQUIRED WATERPROOFING ALONG THE VERTICAL FACE OF ANY BURIED WALLS. 13. THE CONTRACTOR IS RESPONSIBLE FOR KEEPING A SET OF CURRENT, THOROUGH, AND ACCURATE AS-BUILT DRAWINGS AT THE PROJECT SITE.

14. ALL WATER USE SHALL BE METERED EXCEPT FOR USE IN DISINFECTION AND FLUSHING OF WATER MAINS.

15. NO WATER VALVES ON THE EXISTING SYSTEM NOR ANY NEW VALVE CONNECTED TO THE EXISTING SYSTEM SHALL BE OPENED OR CLOSED BY ANYONE EXCEPT AUTHORIZED

WATER DEPARTMENT PERSONNEL. 16. MAINTAIN, SECURE, AND PROTECT ANY EXISTING WATER SYSTEM FACILITY IN PLACE UNTIL THE PROPOSED WATER SYSTEM IS COMPLETED AND ACTIVATED. 17. PARTS FROM ABANDONED CITY FACILITIES, INCLUDING METERS AND VALVES, SHALL BE

RETURNED TO THE WATER DEPARTMENT INSPECTOR. 18. NO EXISTING OR NEW UTILITY METERS OR VAULTS SHALL BE LOCATED WITHIN THE NEW DRIVEWAY APPROACH. ALL EXISTING OR NEW UTILITY VAULTS SERVING THE PROJECT SITE SHALL BE LOCATED ON-SITE AND NOT WITHIN THE PUBLIC UTILITY EASEMENT, IF ANY.

HITECTURE



**REVISIONS** 

PROJECT NAME

SHEET NAME **COVER SHEET** & SITE PLAN

5

DATE: 06/11/2024

SCALE: AS SHOWN

SHEET NO.



HITECTURE



PROJECT NAME

1524 MANNING LN., ALAMO, CA A HOME EXPANSION PROJECT

SHEET NAME

1ST FLOOR PLAN

SHEET NO.

2ND FL. LIVING AREA:

TOTAL LIVING AREA:


255

GARAGE AREA: 656

FRONT PORCH: 82

SIDE PATIO:

A-2.1

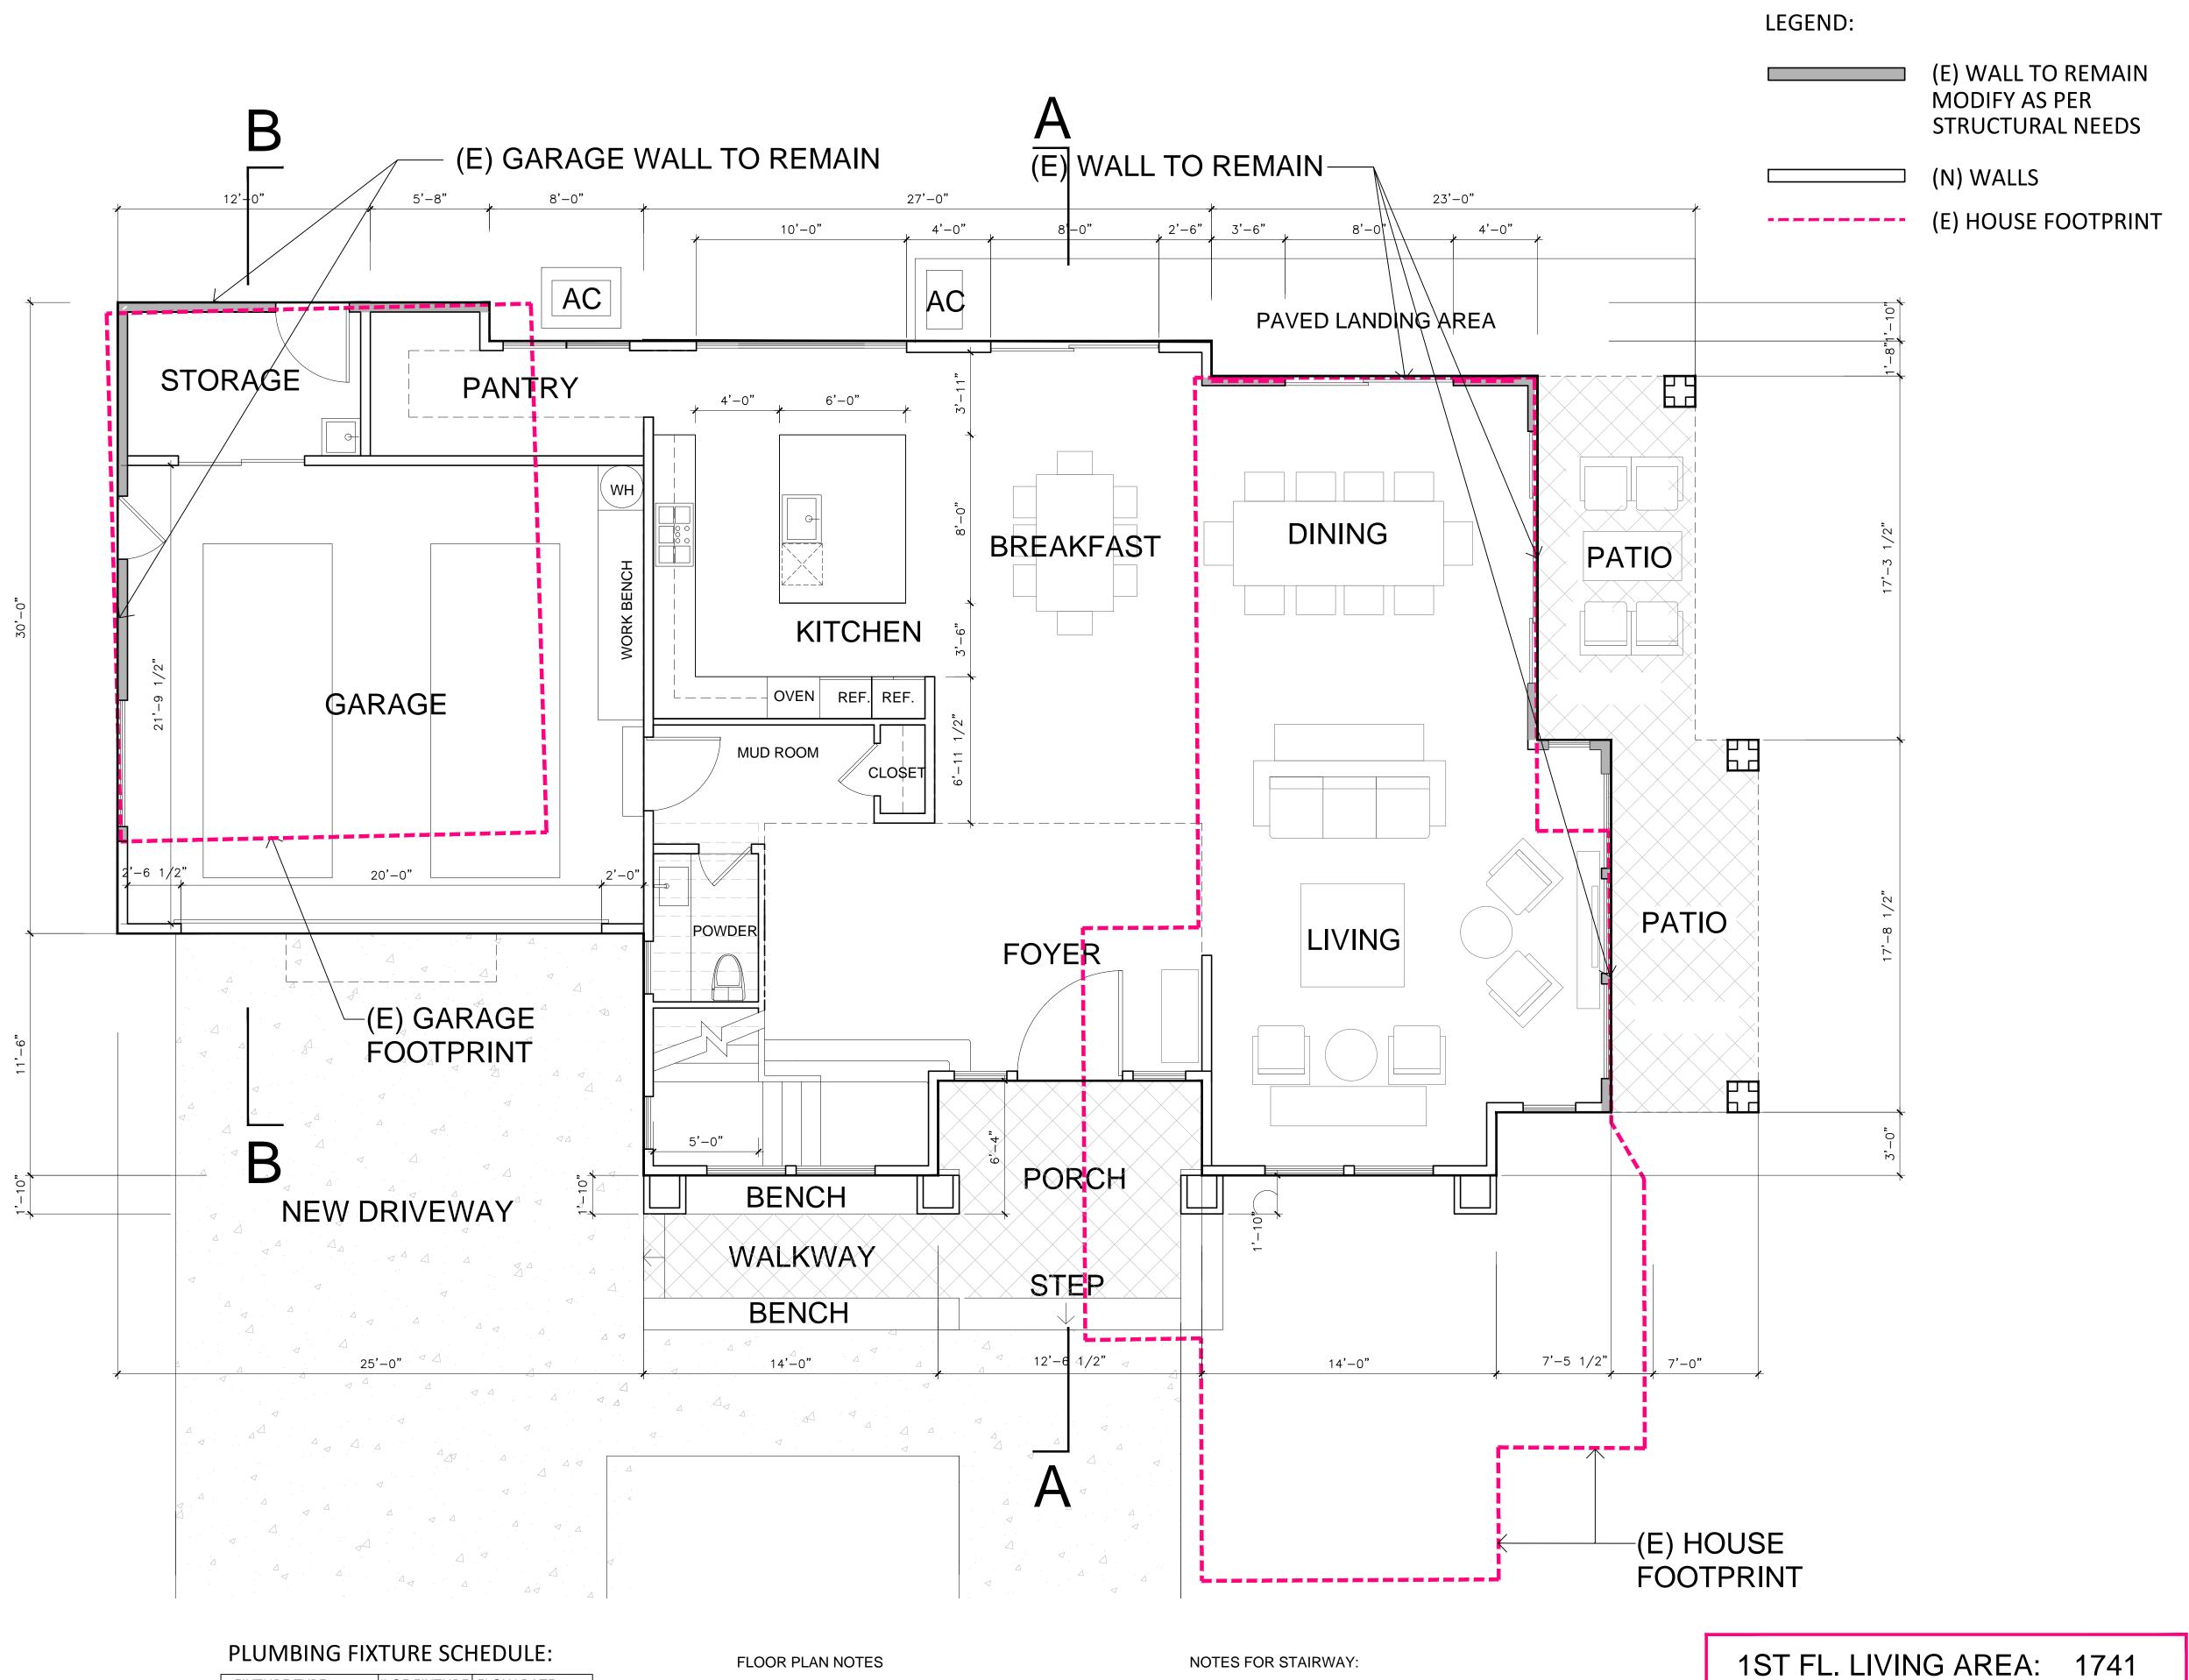

FIXTURE TYPE	# OF FIXTURE	FLOW RATE
W.C .	4	1.28 GL/FLUSH
LAV.	6	1.2 GPM@60psi
SHOWERHEAD	3	1.8 GPM@80psi
TUB FAUCET	2	1.8 GPM@80psi
KITCHEN SINK	1	1.8 GPM@60psi
LAUNDRY SINK	1	1.8 GPM@60psi

## FLOOR PLAN NOTES

# ALL NEW EXTERIOR WALLS TO BE 2X6 FRAMING

## 1ST FLOOR INTERIOR BEARING WALLS TO BE 2X6 FRAMING REMAINING EXTERIOR WALLS TO BE MODIFIED TO MEET STRUCTURAL NEEDS

## NOTES FOR STAIRWAY:

STAIRWAY TO BE A MINIMUM 36" CLEAR WIDTH AT ALL POINTS ABOVE THE PERMITTED HANDRAIL HEIGHT, WITH HANDRAILS PROJECTING A MAXIMUM OF 4.5" ON EITHER SIDE OF THE STAIRWAY


STAIRS TO HAVE MAXIMUM 7.75" RISE AND MINIMUM 10" RUN. CRC R311.7.4.1 STAIRS TO HAVE MINIMUM 80" HEad room

PROPOSED 1ST FLOOR PLAN SCALE: 1/4"=1'-0"

DATE: 06/11/2024 SCALE: AS SHOWN SHEET NAME 2ND FLOOR PLAN

SHEET NO.

A-2.2

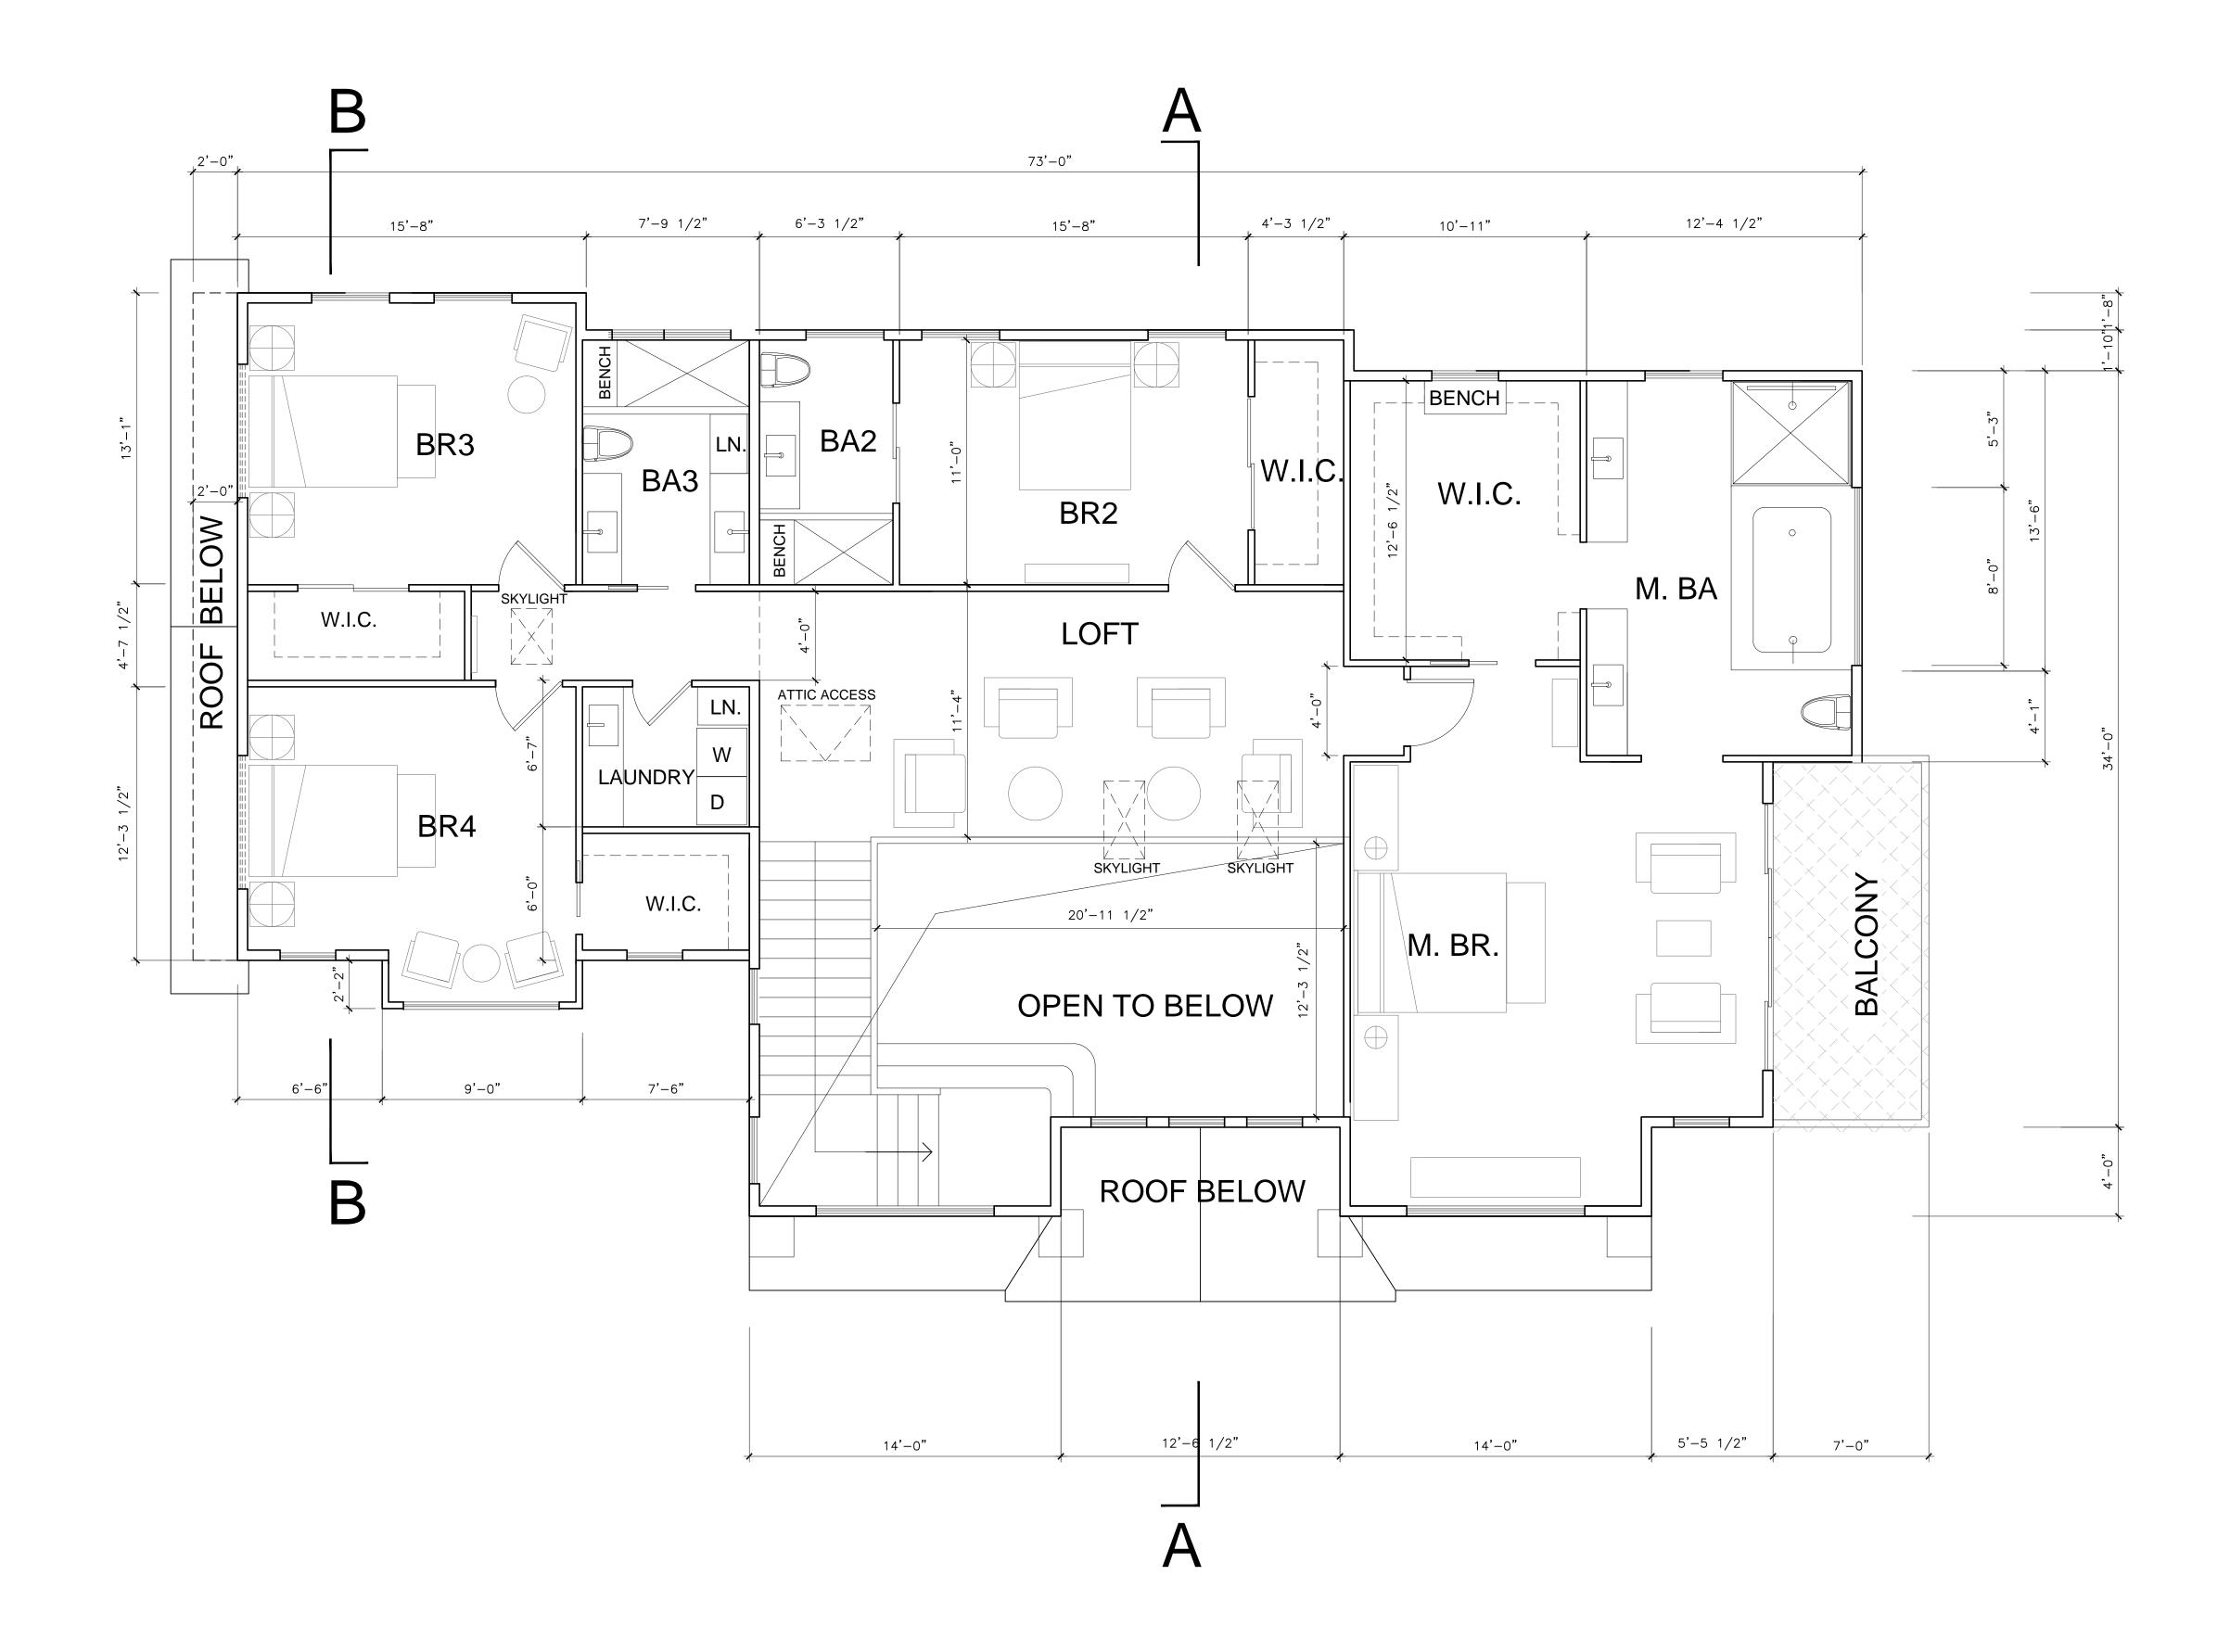

## WINDOW / DOOR NOTES

SINGLE HUNG DOUBLE HUNG SLIDING DOOR SLIDING WINDOW AWNING WINDOW SH DH SLD SLW AWN FIXED WINDOW POCKED DOOR FX PKD CSM COM STK 3080 2680 OPT. CASEMENT WINDOW COMBINATION WINDOWS STACKED WINDOW 3'-0"X8'-0" 2'-6"X8'-0" OPTIONAL TEMPERED GLASS

SCALE: 1/4"=1'-0"

LIVING AREA: 2119 SF PROPOSED 2ND FLOOR PLAN

ROOF PLATE HEIGHTS ARE REFERENCED FROM TOP OF SUB FLOOR AT ENTRY, U.N.O.

CLASS A ROOF COVERING SHALL BE

MANUFACTURER: OWENS CORNING ROOFING OR EQUAL QUALITY PRODUCT

COMP. SHINGLE ROOFING FOR SLOPED ROOF

COLOR:

GUTTERS ON ALL ELEVATIONS SHALL BE PROFILED ALUMINUM GUTTERS BY AMERIMAX OR

ROOF PITCH SHALL BE AS NOTED ON ROOF PLAN

DASHED LINES INDICATE WALL(STRUCTURE) BELOW.

OVERHANG DIMENSIONS SHALL BE AS NOTED ON ROOF PLAN

LOCATE GUTTERS AND DOWNSPOUTS AS SHOWN. NOTE: LOCATE DOWNSPOUTS MIN. 8" OFF

CORNER WHERE POSSIBLE (U.O.N.)

ALL ROOF DRAINAGE SHALL BE PIPED TO STREET OR APPROVED DRAINAGE FACILITY.

ALL PLUMBING VENTS SHALL BE COMBINED INTO A MINIMUM AMOUNT OF ROOF PENETRATIONS. ALL ROOF PENETRATIONS SHALL OCCUR TO THE REAR OF THE MAIN RIDGE (WHERE POSSIBLE) SEE DETAIL 11 /A-4.1


ATTIC VENTILATION SHALL BE PROVIDED PER SECTION 1505.3 OF THE UBC. (SEE CALCULATIONS, THIS SHEET)

LOCATE UPPER AND LOWER ROOF VENTS AS SHOWN ON PLAN.

UNDERLAYMENT FOR ASPHALT SHINGLES SHALL COMPLY WITH ASTM D226 TYPE I; ASTM D4869 TYPE I,II,III OR IV; ASTM D6757, AND SHALL BEAR A LABEL INDICATING COMPLIANCE TO THE STANDARD DESIGNATION. (R905.1.1)

FLASH ALL ROOF VALLEYS (INSTALL FLASHING OVER 30# FELT)


ALL FLASHING SHALL BE 26 GAUGE G.S.M.

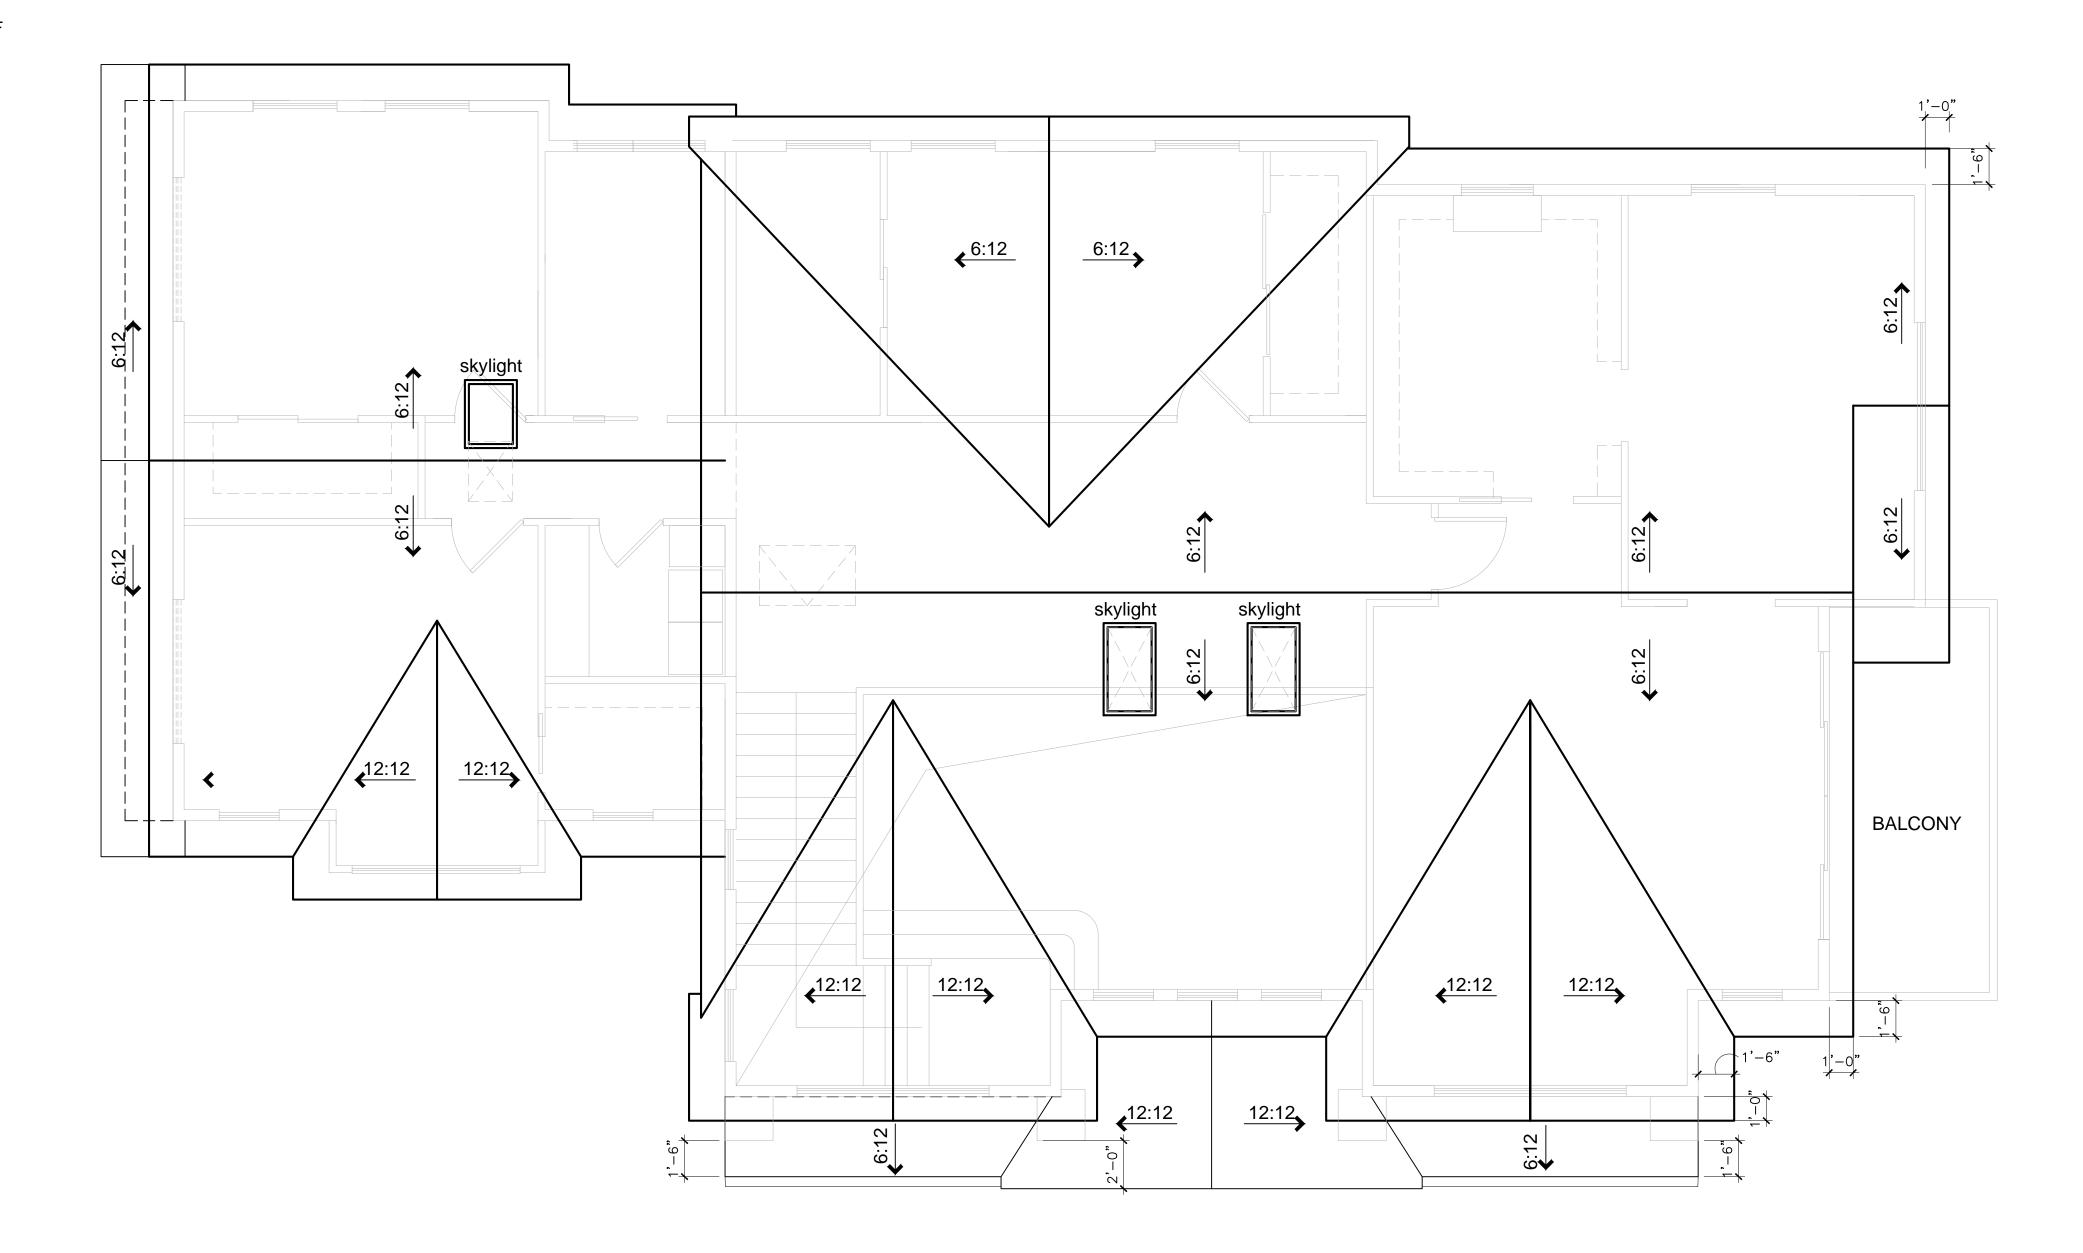

PROPOSED ROOF PLAN

SCALE: 1/4"=1'-0"



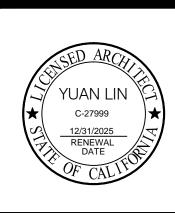

REVISIONS

PROJECT NAME


1524 MANNING LN., ALAMO, CA A HOME EXPANSION PROJECT

DATE: 06/11/2024 SCALE: AS SHOWN SHEET NAME

ROOF PLAN

SHEET NO.

A-2.3

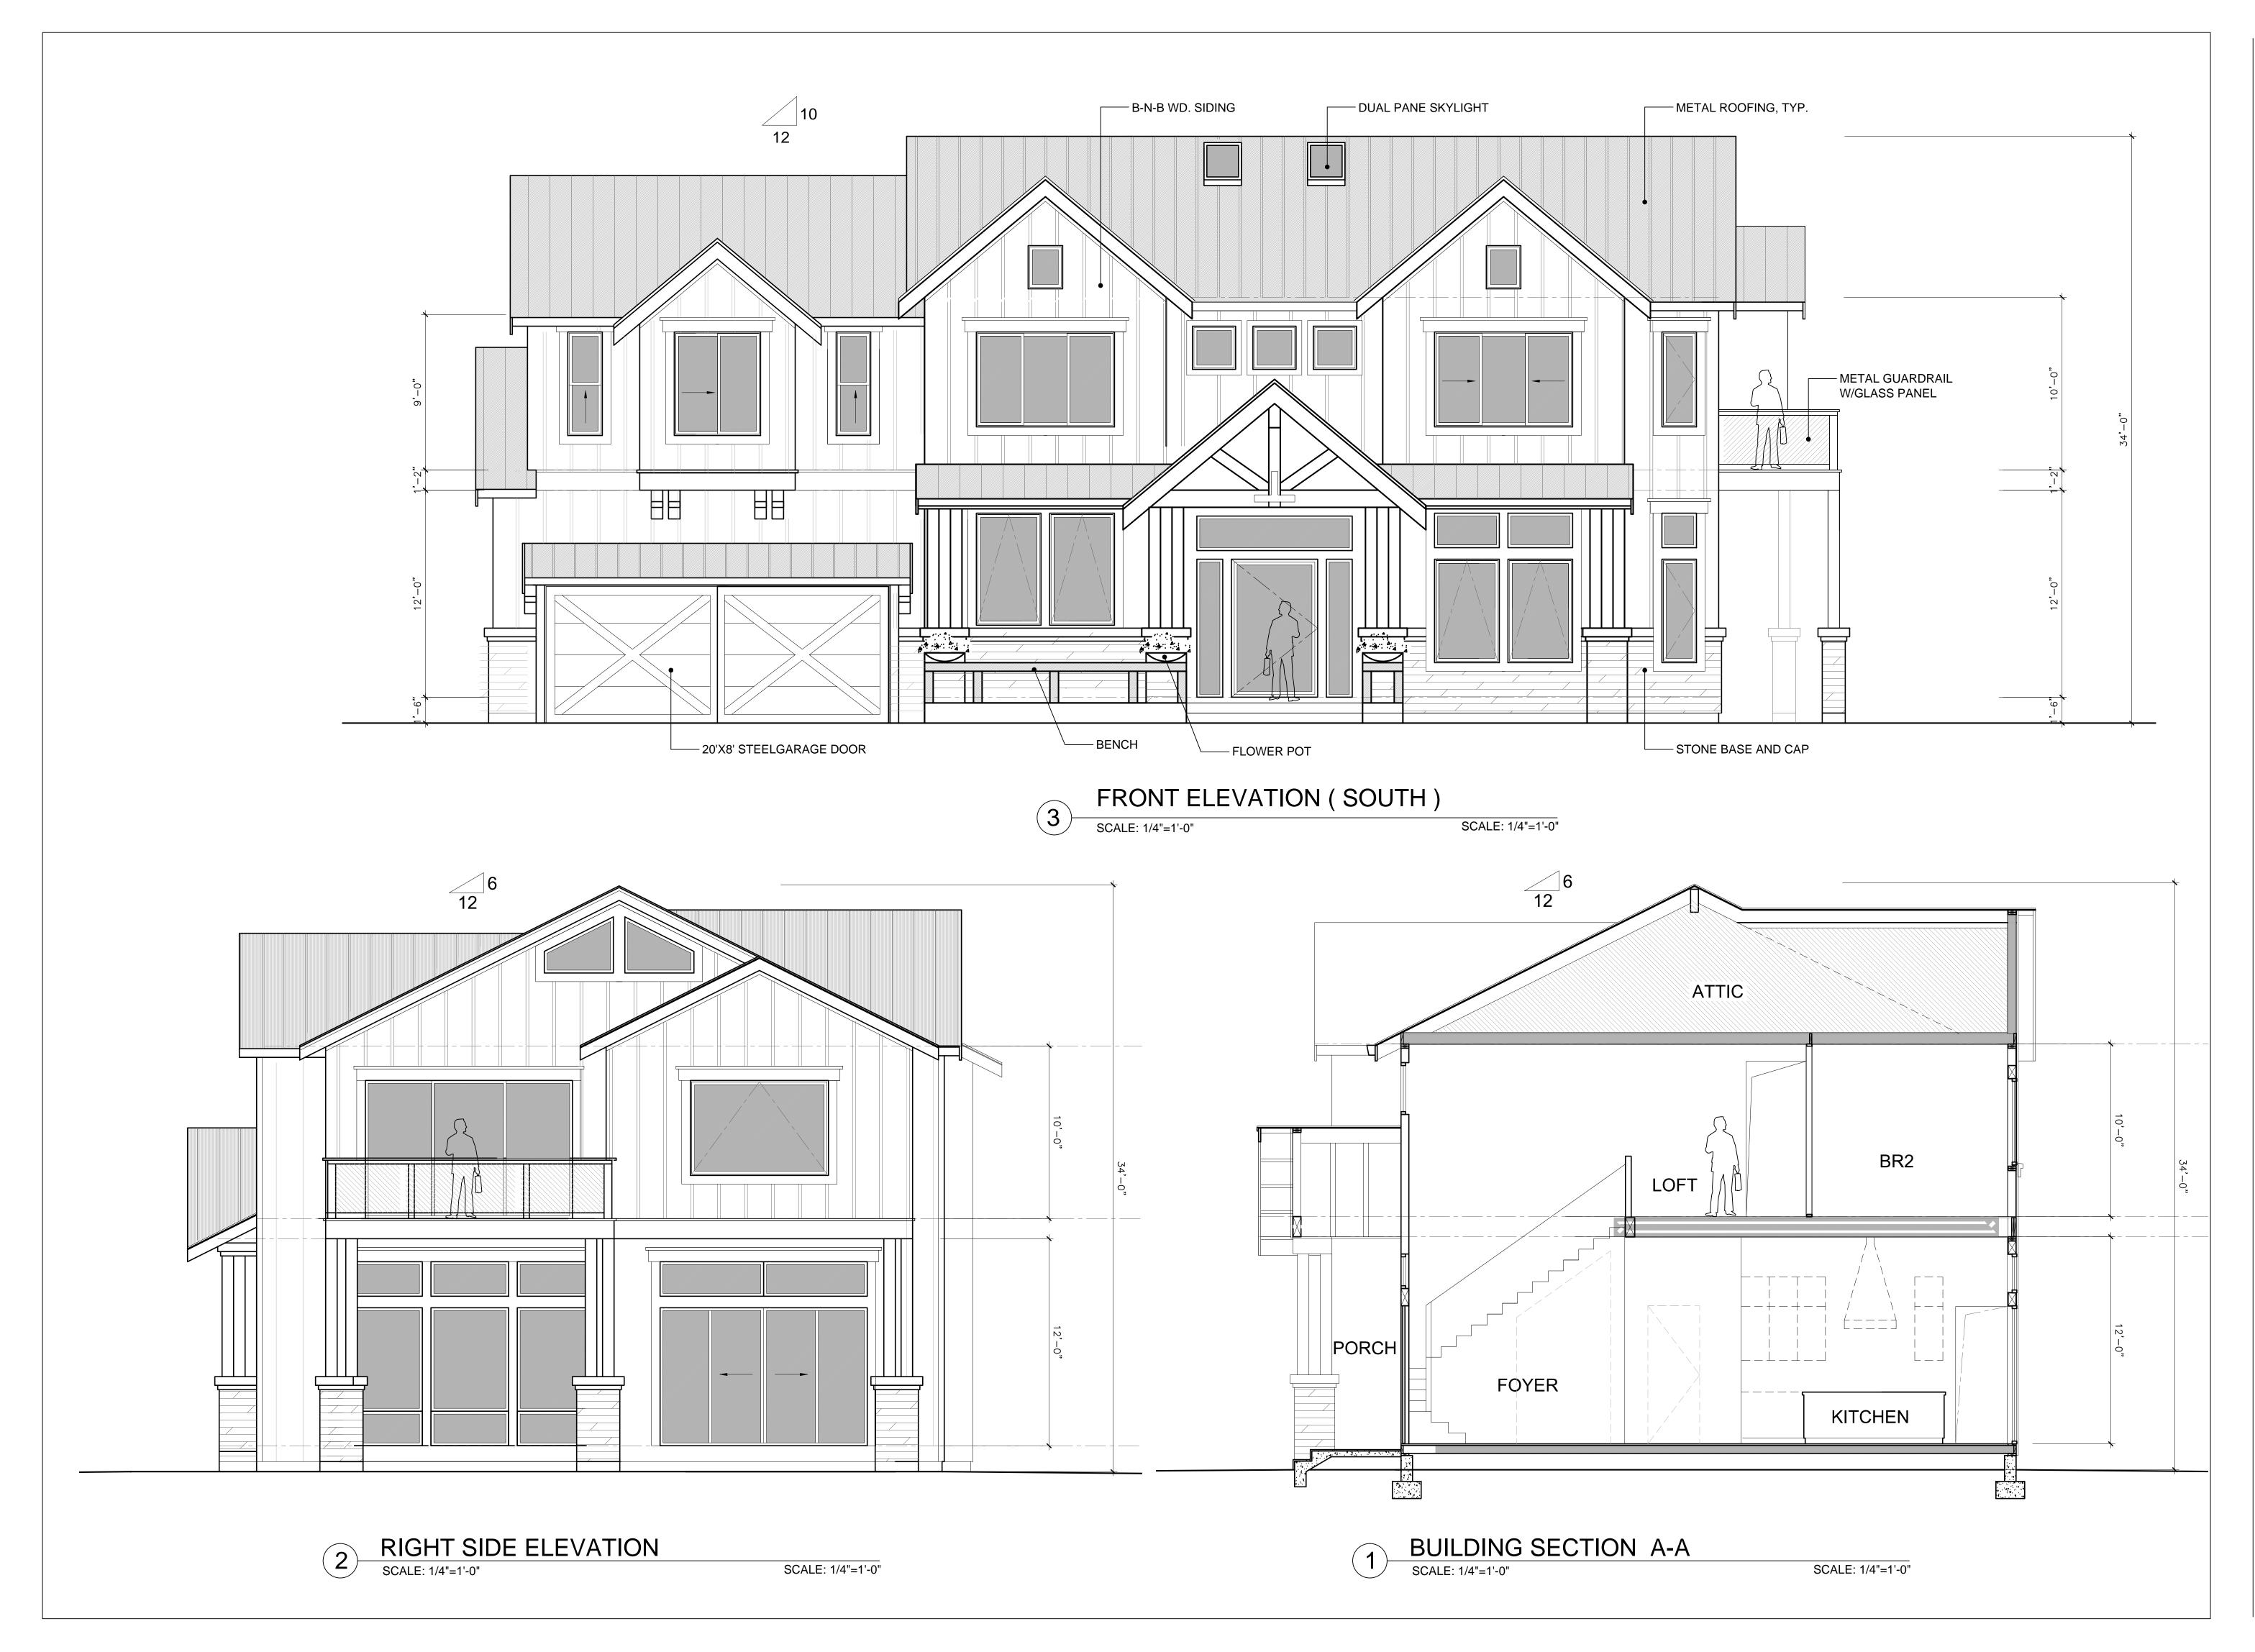



ARCHITECTURE INC.

6710 CORTE SANTA MARIA PLEASANTON, CA 94566



REVISIONS

PROJECT NAME

1524 MANNING LN., ALAMO, CA A HOME EXPANSION PROJECT

DATE: 06/11/2024
SCALE: AS SHOWN
SHEET NAME

BUILDING
ELEVATIONS
& SECTION

SHEET NO.

A-3.1



REVISIONS

PROJECT NAME

1524 MANNING LN., ALAMO, CA A HOME EXPANSION PROJECT OWNER: Mr. & Mrs. Javaid Noorzad

DATE: 06/11/2024 SCALE: AS SHOWN SHEET NAME BUILDING SECTIONS

A-3.2



# REAR ELEVATION

