## WINDHOVER TERRACE APARTMENTS


APN: 380-220-066

0 PACHECO BLVD, MARTINEZ, CA

PERMIT#: CDDP21-03031

# SUBJECT PROPERTY N27° 11'09''E WINDHOVER N27° 11'09''E ACHE

SUBJECT PROPERTY

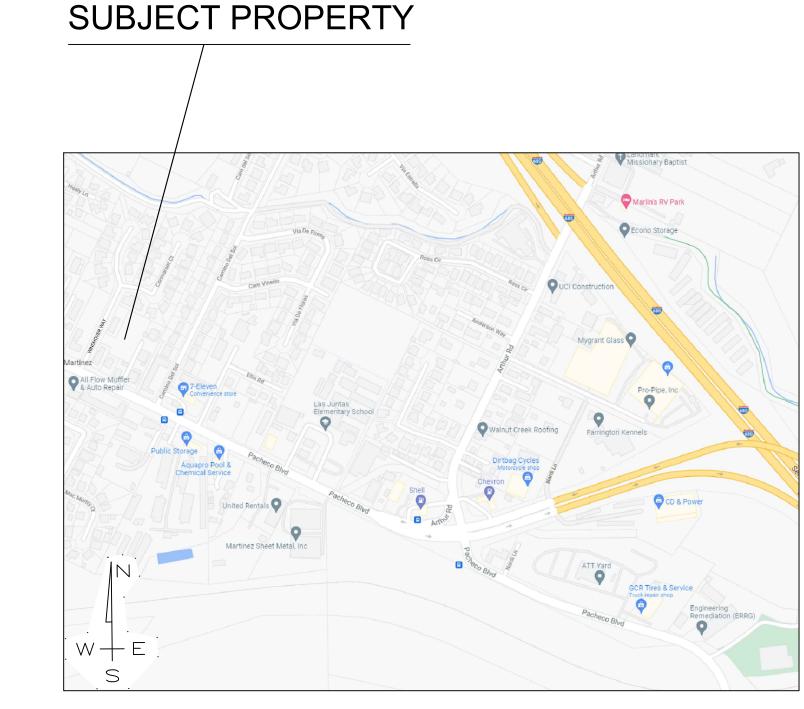

ASSESSOR'S PARCEL MAP

**AERIAL MAP** 

VICINITY MAP

West Coast Land and Development, Inc. 145 John Glenn Drive Concord, Ca (925)246-2870
Civil Engineer:
Calichi Design Group Civil Engineers 3240 Peralta Street, #3 Oakland, Ca 94560 (510)250-7877 www.calichi.com
Architectural Designer:
Norcal Design 1501 North Point Street San Francisco, Ca (415)295-2012
Landscape Architect:
Smith+Smith 1501 North Point Street San Francisco, Ca (415)543-0332
Soils Engineer:
Bear Engineering 3530 Kevin Place Concord, Ca

(925)978-9754

Owner:

		GENERA	L NOTES
		ABBREVIATIONS	1. INSTALL WATER RESISTANT GYPSUM BOARD
	&	AND	(FULL HEIGHT) AROUND ALL SHOWER ENCLOSURES AND BEHIND ALL PLUMBING
	<u>@</u>	AT	FIXTURES, EXCEPT BEHIND TILE, INSTALL
	ABV	AB OVE	DUROC, WONDERBOARD, OR SIM. PRODUCT.
	ADDL	ADDITIONAL	2. ALL WALLS WITH SHEAR PLYWOOD SHALL
	CBC	CALIFORNIA BUILDING CODE	HAVE A CONTINUOUS FLUSH FINISH. FURR
1	CLG	CEILING	WALLS OR CONTINUE PLYWD. TO MAINTAIN
	CONC	C ONC RETE	THE REQUIRED FLUSH FINISH
	CONT	CONTINUOUS	3. ALL EXTERIOR DOORS AND WINDOWS
	CNR	CORNER	SHALL CONFORM TO THE CITY OR COUNTY SECURITY ORDINANCE.
	DBL	DOUBLE	4. ALL WALLS OVER 10'0" TALL SHALL BE
	DEL	DELETE	2x6 STUDS @ 16" O.C. MINIMUM, WITH
	DET / DTL	DETAIL	FIRE BLOCKING @ 10'-0" INTERVALS
	DWG	DRAWING(S)	5. ALL ANGLES OTHER THAN 90°
	(E)	EXISTING	SHALL BE 45° U.O.N.
	EA	EAC H	
	ELEV	ELEVATION	6. PROVIDE BACKING FOR ALL TOWEL BARS AND TISSUE HOLDERS IN BATHROOMS, TYP.
	EXT	EXTERIOR	AND HISSUE HULDERS IN BAIHROUMS, HE.
۱	ETD	EXTEND	7. ALL DIMENSIONS ARE FROM FACE OF
	FIN	FINISH/FINISHING	STUD TO FACE OF STUD U.O.N.
	FLR	FLOOR	
	FND	FOUNDATION	8. VERIFY ALL FINISH MATERIALS WITH OWNER PRIOR TO INSTALLATION.
	HORIZ	HORIZONTAL	OWNER PRIOR TO INSTALLATION.
	HT	HEIGHT	9. CEILING HEIGHTS ARE MEASURED FROM
١	ICBO	INTERNATIONAL CONFERENCE OF	TOP OF SUBFLOOR, TYP.
		BUILDING OFFICIALS	10. ALL TEMPERED GLASS SHALL BE AFFIXED
	INT	INTERIOR, INTERSECTION	W/ A PERMANENT LABEL.
1	MAX	MAXIMUM	
	MIN	MINIMUM	11. SHOWERS AND TUB/SHOWER FIXTURES
	(N)	NEW	SHALL BE EQUIPPED W/ A PRESSURE
	NTS	NOT TO SCALE	BALANCE OR THERMOSTATIC MIXING VALVE.
	RF	ROOF	12. ALL WINDOWS IN SLEEPING ROOMS
	SQ	SQUARE	SHALL HAVE SILL HEIGHTS NOT MORE
1	STD	STANDARD	THAN 44-INCHES ABOVE THE FLOOR AND
	TBV	TO BE VERIFIED	OPEN DIRECTLY TO STREETS, PUBLIC
	UBC	UNIFORM BUILDING CODE	ALLEYS, YARDS, OR EXIT COUNTY.
1	UON	UNLESS OTHERWISE NOTED	13. ALL DOORS SHALL BE FRAMED WITH 4"
	UOS	UNLESS OTHERWISE SHOWN	JAMBS, TYP. U.O.N.
	VERT VIF	VERTICAL VERIEV	14. PROVIDE SAFETY GLAZING AT SPECIFIC
$\ $		VERIFY IN FIELD WITH	LOCATIONS ON PLANS WHERE BOTTOM OF
	W/ W/I	WITHIN	WINDOW WILL BE LESS THAN 60" ABOVE A
П	VV / I	WIIMIN	CTANDING CUDEAGE AND DDAIN INLET

DEVELOPMENT, INC. 145 JOHN GLEN DRIVE CONCORD, CA 94520 PROJECT ADDRESS 0 PACHECO BLVD MARTINEZ, CA 94553	BUILD BUILD COVE TRAS BIKE L	OING 3NE RED PAI H ENCLO LOCKER	- 76 SQ.FT.		
MARTINEZ, CA 94553	LOT S	SIZE			32,830 SQ.FT.
APN: 380-220-066 SIZE: 0.75 ACRES ZONING: M-29 EXISTING STRUCTURES:  PROPOSED STRUCTURES: 24 UNIT BUILDING WIIMPROVEMENTS		BUILDI COVEF	LOT COVE DSED LOT COVERAGE NG FOOTPRINT RED PARKING I ENCLOSURE TO	<u>SE</u> 	2,969 SQ. FT.
<b>SIZE</b> : 22,247 SG	RFT LIVING AREA	ALLC	WED 32830 x .35	= 1	1,490 SQ. FT.
SETBACK REQUESTED STRUCT  FRONT / SIDE / 25' MIN. / 20'-0" / PROPOSED FRONT / SIDE / 48' / 20'/82' /	CTURES REAR / PARKING 20'-0" / 25'-0"		MAX. ALLOWE 30'-0"	ING HEIG ED PR 3 SPACE PR	GHT
PARKING PROPOSED:	16 Covered (2 ADA 4 EV Spaces) 13 Uncovered 4 Guest Parking 33 Total Parking				

**BUILDING DATA** 

LEGAL OWNER:

WEST COAST LAND AND

TREES TO BE REMOVED: 9 Total, 1 Protected

TANDING SURFACE AND DRAIN INLET.

PROPOSED AREA:

BUILDING 1ST FLOOR --

	INDEX TO DRAWINGS										
	G1	GENERAL TITLE SHEET									
7,389 SQ.FT. 7,429 SQ.FT.	C1.0	SITE, PAVING, HORIZONTAL CONTROL PLAN									
	C1.1	FIRE PROTECTION EXHIBIT									
276 SQ.FT. 76 SQ.FT.	C2.0	GRADING AND DRAINAGE PLAN									
32,830 SQ.FT.	C3.0	UTILITY PLAN									
	C4.0	STORMWATER CONTROL PLAN									
7,389 SQ. FT.	A1	1ST FLOOR PLAN									
2,969 SQ. FT. <u>276 SQ. FT.</u>	A2	2ND FLOOR PLAN									
10,619 SQ.FT.	A3	3RD FLOOR PLAN									
11,490 SQ. FT.	A4	ELEVATIONS									
	L-1	LANDSCAPE PLAN									
REMENTS	L-2	LANDSCAPE FURNITURE & PLANTING IMAGES									
IGHT ROPOSED	CB1	COLOR BOARD									
37.5' -											

CODES	IN	EFFECT

•	2019 CALIFORNIA BUILDING CODE (CBC)
•	2019 CALIFORNIA ELECTRICAL CODE (CEC)


2019 MECAHNICAL CODE (CMC)


2019 PLUMBING CODE (CPC) 2019 CALIFORNIA FIRE CODE (CFC)


2019 CALIFORNIA ENERGY CODE (CEnC) CONTRA COSTA COUNTY MUNICIPAL CODE DATE: 10-19-2021 CALE: NONE

WINDHOVER 0 PACHECO MARTINEZ, C

RAWN BY: PQR

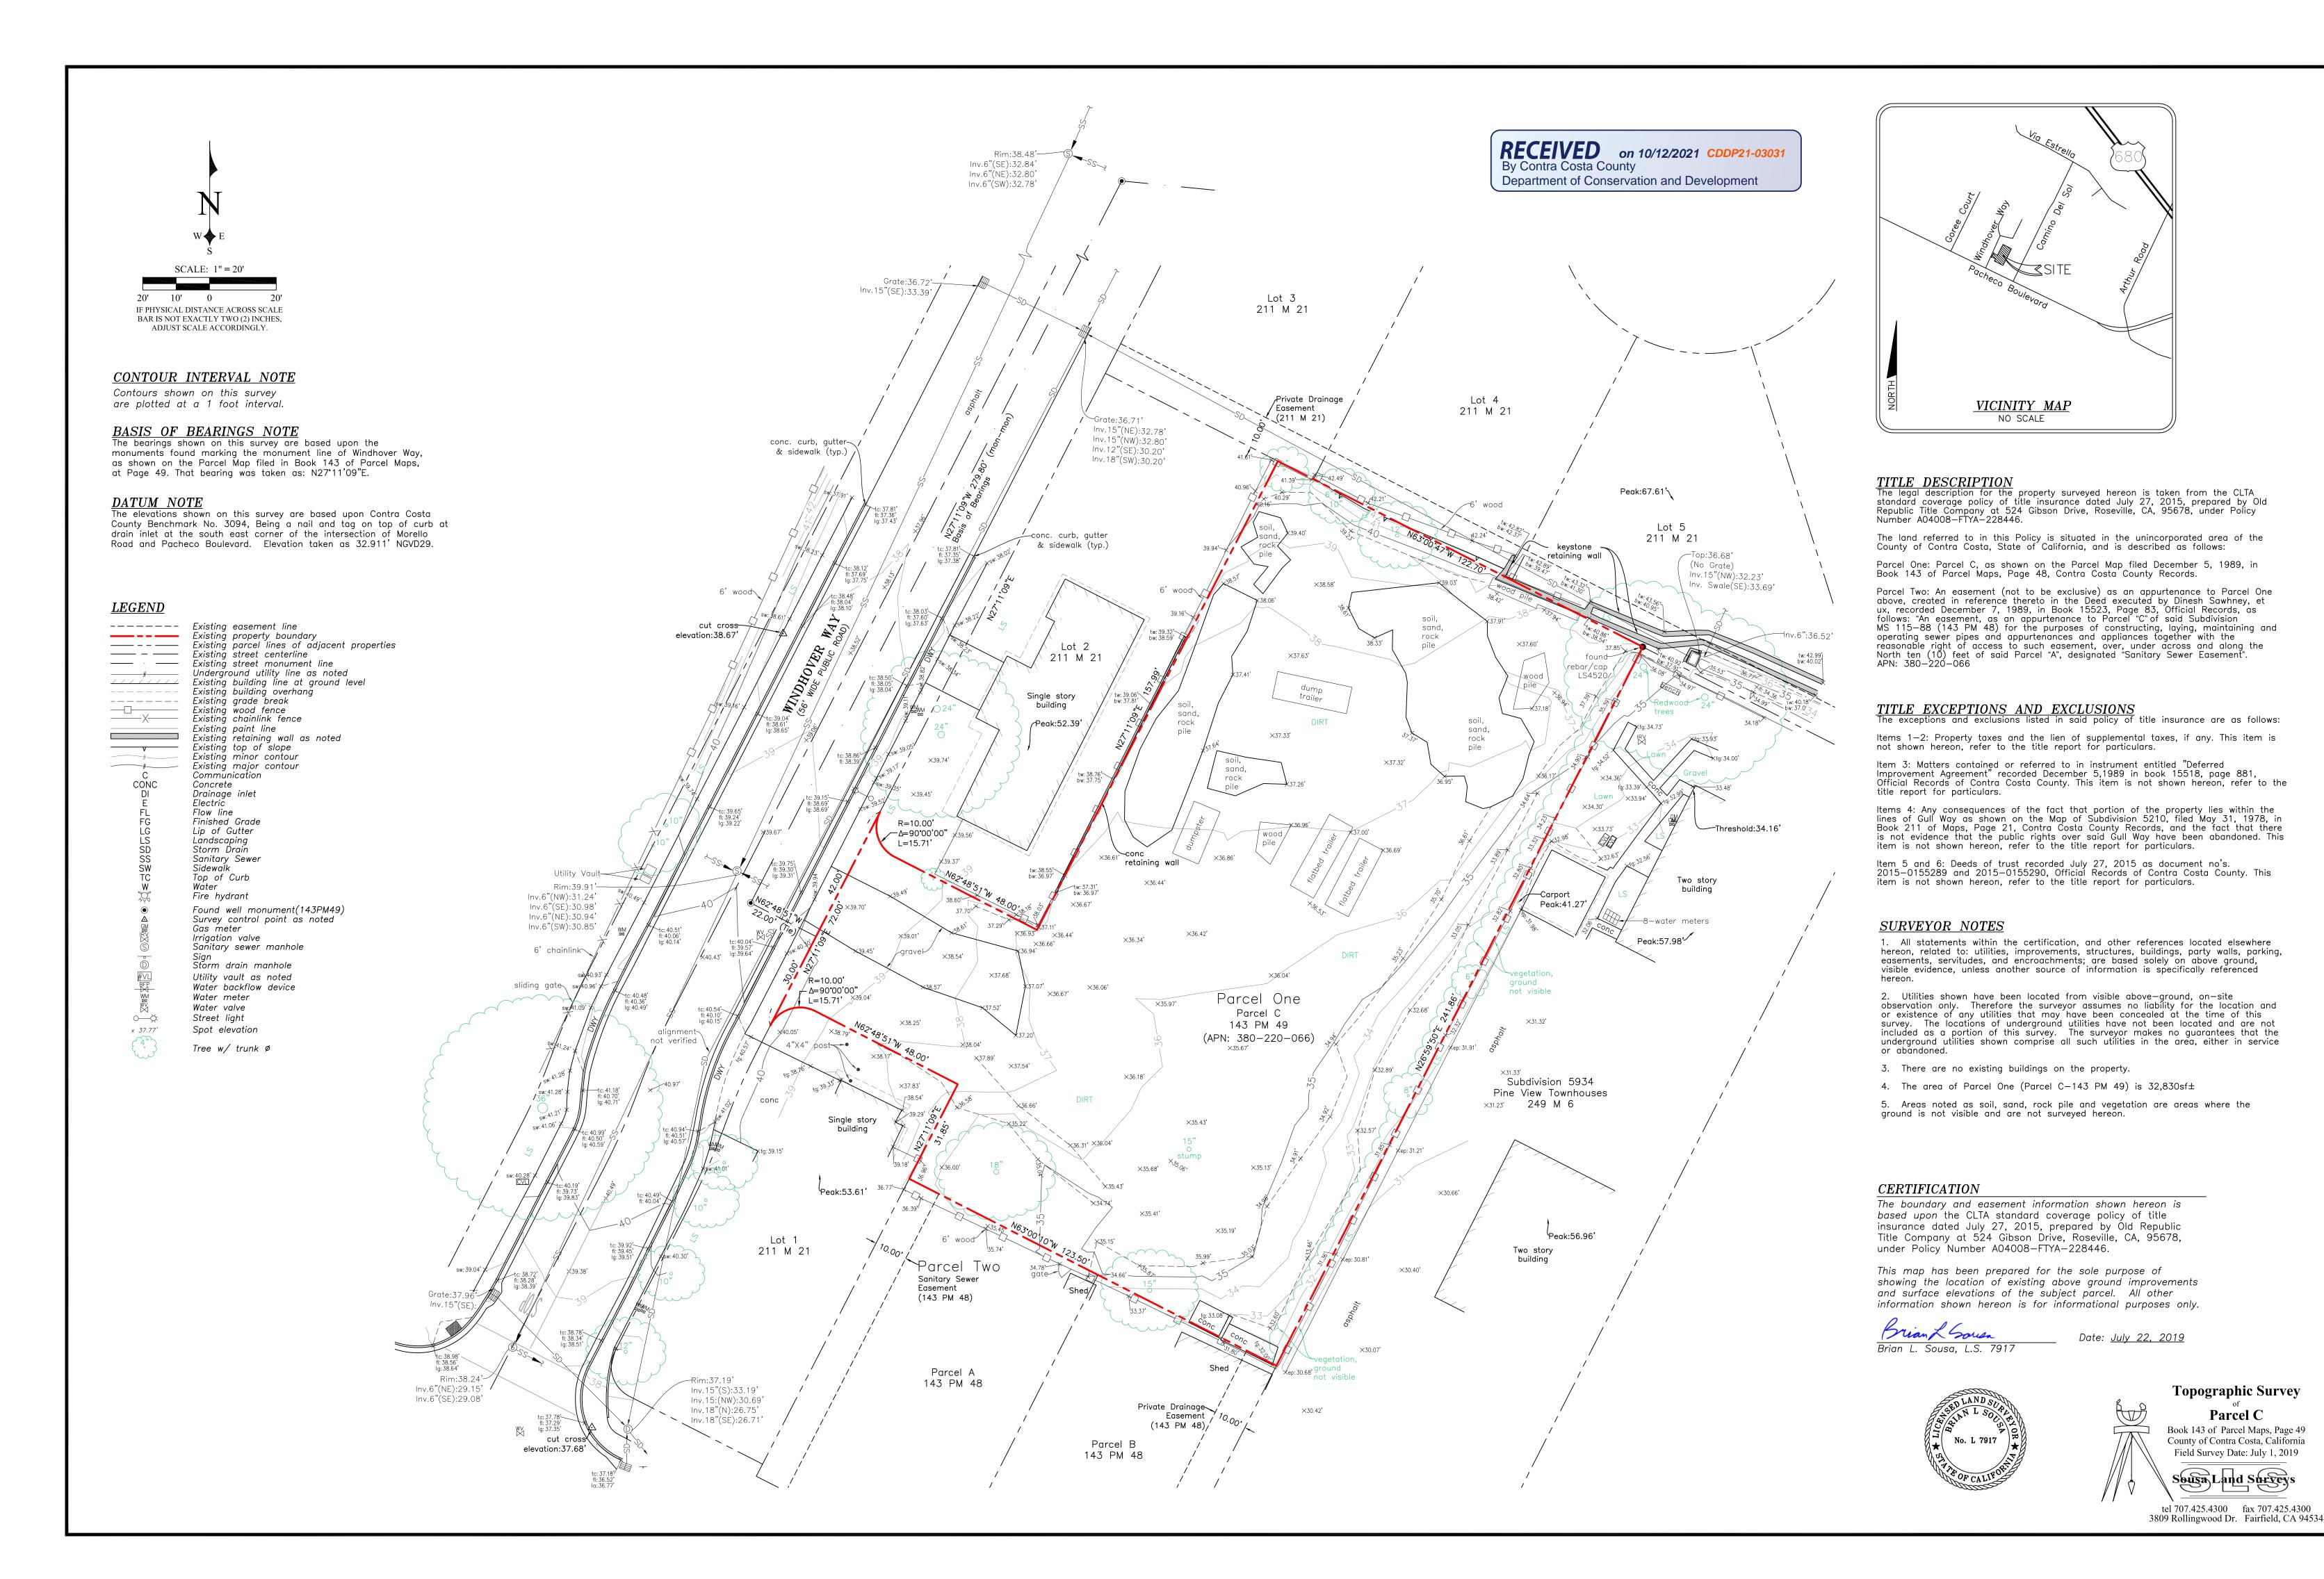

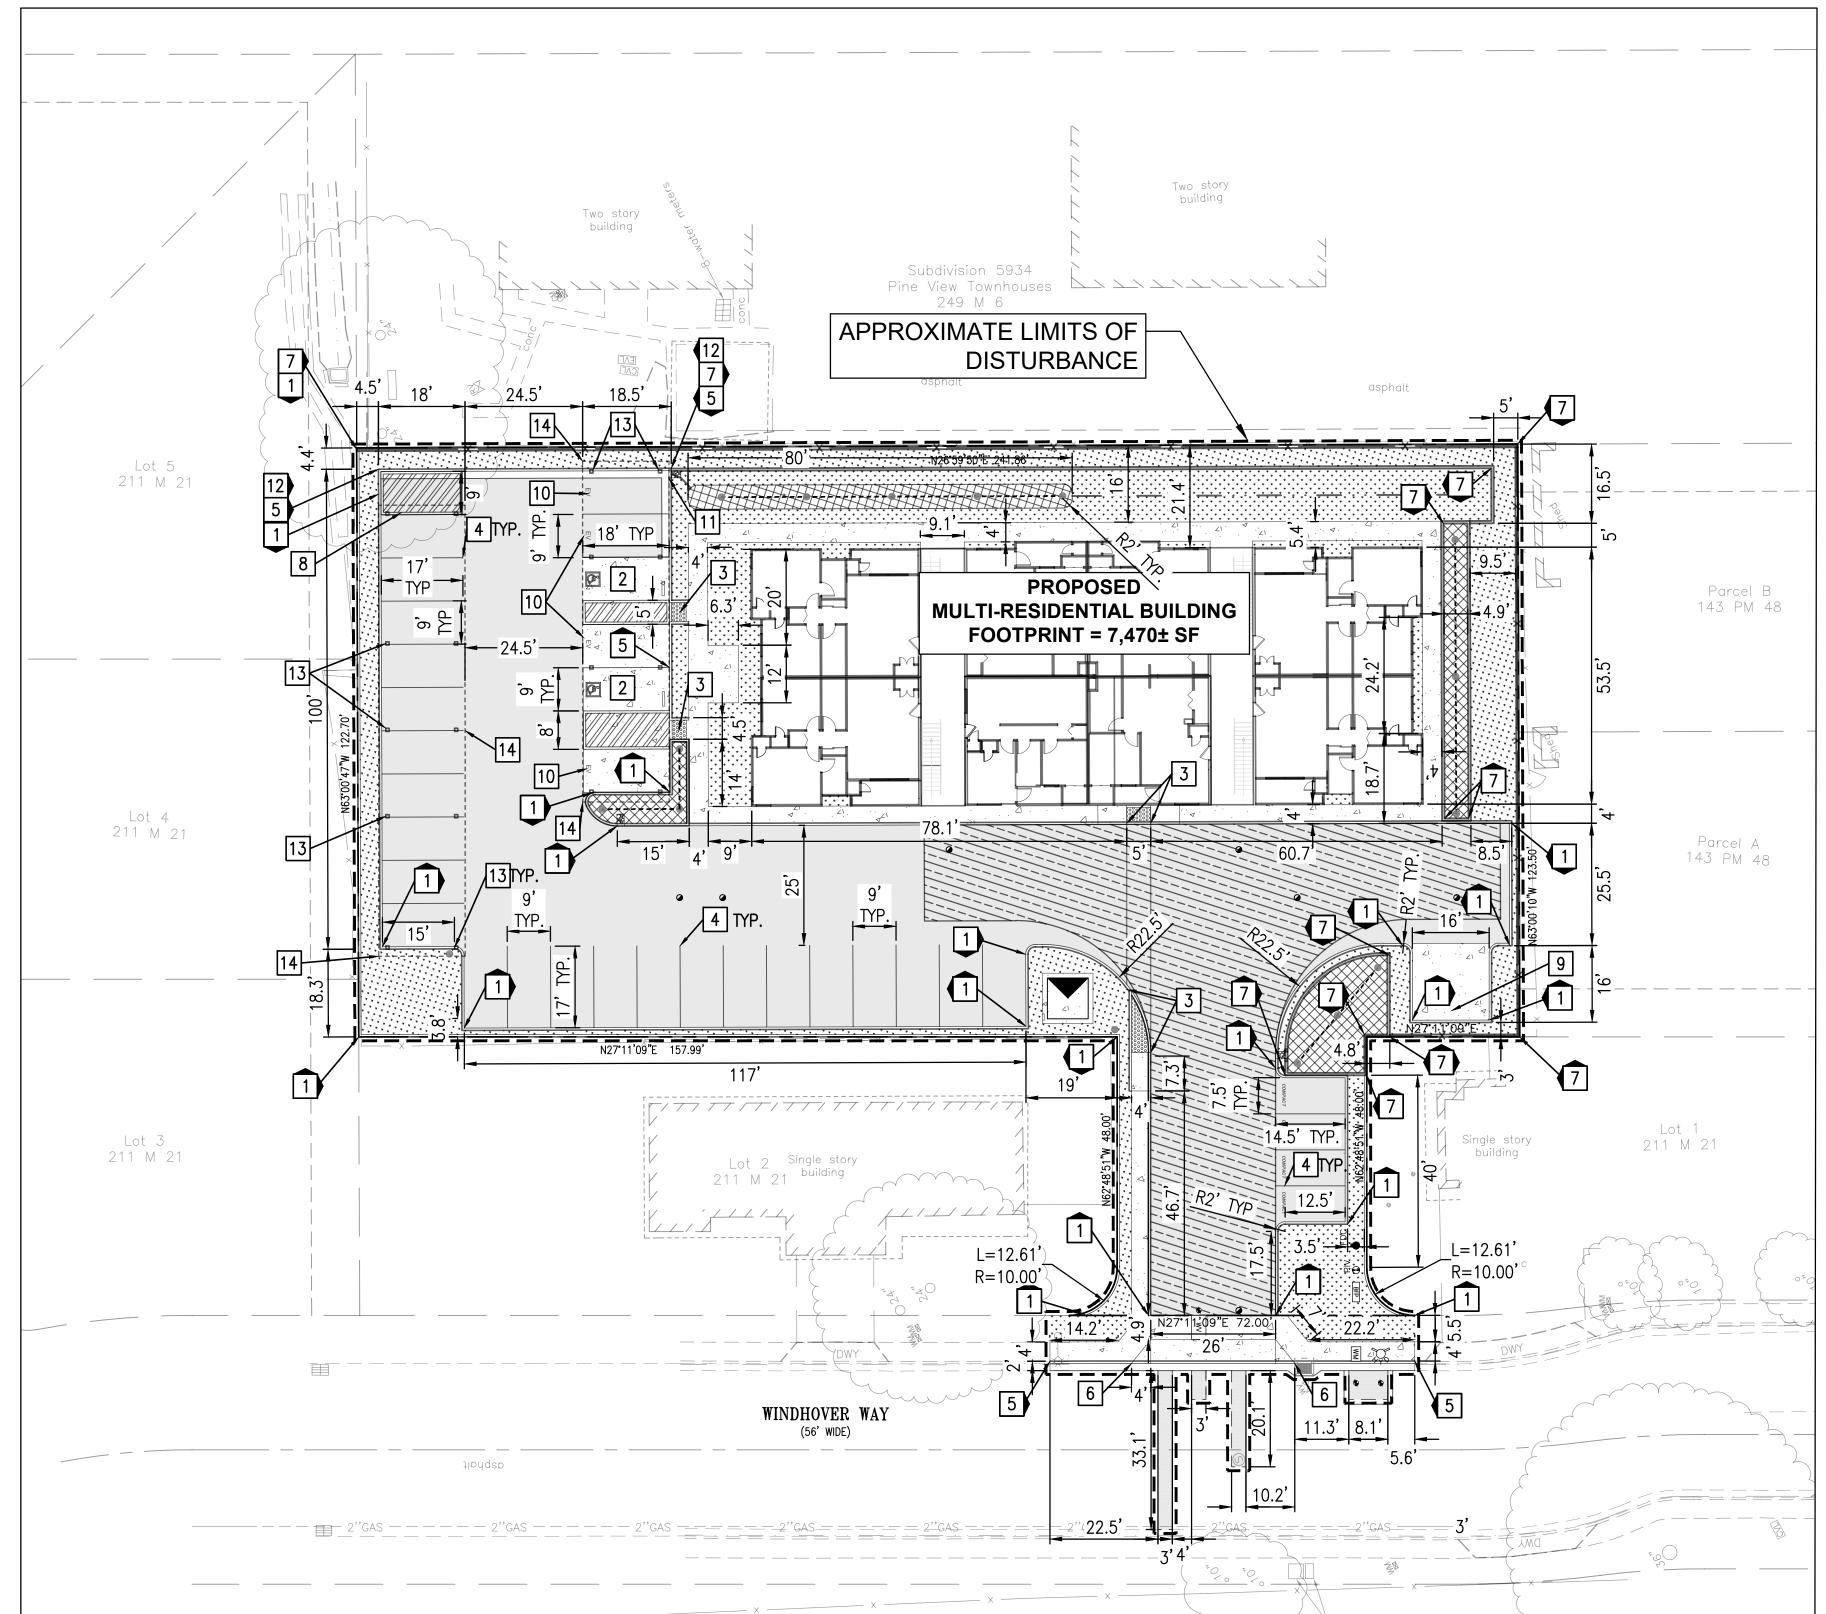

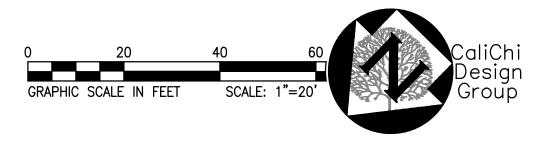



#### **ENGINEERS NOTE TO THE CONTRACTOR:**

THE EXISTENCE AND LOCATION OF ANY UNDERGROUND UTILITIES, PIPES AND/OR STRUCTURES SHOWN ON THESE PLANS WERE BTAINED BY A SEARCH OF AVAILABLE RECORDS O THE BEST OF OUR KNOWLEDGE. THERE ARE NO EXISTING UTILITIES EXCEPT AS SHOWN ON THESE PLANS. THE CONTRACTOR SHALL ASCERTAIN THE TRUE VERTICAL AND HORIZONTAL LOCATION AND SIZE OF ANY UNDERGROUND UTILITIES AND SHALL BE RESPONSIBLE FOR DAMAGE TO PUBLIC OR PRIVATE UTILITIES SHOWN CALL TWO WORKING DAYS BEFORE YOU DIG OR NOT SHOWN HEREON.

**GENERAL NOTES:** 

ALL CURBS ARE PCC VERTICAL BARRIER CURB 6" UNLESS

OTHERWISE NOTED. ALL CONSTRUCTION SHALL BE PERFORMED IN ACCORDANCE WITH THE LATEST SAN MATEO COUNTY AND CITY OF MILLBRAE STANDARDS.

ANY EXISTING INFRASTRUCTURE OR SITE ITEMS (ABOVE OR BELO GRADE, READILY VISIBLE OR NOT) OR PROPERTY DAMAGED AS A RESULT OF CONSTRUCTION SHALL BE REPAIRED BY THE CONTRACTOR TO THE SATISFACTION OF THE APPROPRIATE AGENCY ALL CONSTRUCTION SHALL CONFORM TO APPLICABLE STATE AND LOCAL CODES. WHEN CODES ARE IN CONFLICT, THE MORE STRINGENT SHALL APPLY. THE CONTRACTOR SHALL CAUSE A

ALL TIMES. ALL SIGNAGE AND PAINT MARKINGS SHALL COMPLY WITH THE MANUAL ON UNIFORM TRAFFIC CONTROL DEVICES (MUTCD), OR AS OTHERWISE SPECIFIED. INSTALLATION OF SIGNS SHALL BE GOVERNED BY LOCAL CODES.

THE CONTRACTOR IS RESPONSIBLE TO LOCATE AND PROTECT ALI EXISTING UTILITIES DURING CONSTRUCTION. THE CONTRACTOR SHALL NOTIFY THE UTILITY PROTECTION CENTER AT LEAST THREE DAYS PRIOR TO ANY SITE WORK FOR PROPER IDENTIFICATION OF EXISTING UTILITIES.

THE CONTRACTOR SHALL VERIFY ALL EXISTING ITEMS AND DIMENSIONS AND REPORT ANY DISCREPANCIES TO THE ENGINEER PRIOR TO BEGINNING CONSTRUCTION.

#### **ENGINEER'S ADA NOTES:**

ALL SITE WORK SHALL BE IN CONFORMANCE WITH THE CURRENT AMERICANS WITH DISABILITIES ACT ACCESSIBILITY GUIDELINES (ADAAG), THE AMERICANS WITH DISABILITIES ACT (ADA), AND MUNICIPAL AND STATE ADA REGULATIONS.

RAMPS SHALL NOT EXCEED A RUNNING SLOPE OF 1:12 (8.33%). RAMPS ARE DEFINED AS ANY WALKWAY BETWEEN SLOPES 1:20 (5%) AND 1:12 (8.33%) AND SHALL HAVE A MINIMUM WIDTH OF 3 FEET (EXCEPT AT DOORWAYS) AND A MAXIMUM CROSS-SLOPE OF 2%. RAMPS EXCEEDING 30 INCHES VERTICAL CHANGE SHALL HAVE INTERMEDIATE (2% MAX SLOPE) LANDINGS HAVING A MINIMUM LENGTH IN THE DIRECTION OF TRAVEL OF 60 INCHES.

MAXIMUM CROSS-SLOPE ON ANY WALK OR RAMPS SHALL BE 2%. ALL ACCESSIBLE PARKING SPACES AND LOADING ZONES SHALL HAVE A MAXIMUM SLOPE OF 2% IN ANY DIRECTION.

TRUNCATED DOMES AS DETECTABLE WARNINGS ARE REQUIRED ON ALL WALKS THAT CROSS OR ADJOIN A VEHICULAR WAY WITHOUT A VERTICAL SEPARATION BETWEEN WALKWAY AND VEHICULAR WAY.

ANY REQUEST BY A MUNICIPALITY OR INSPECTOR TO MODIFY THE ACCESSIBILITY DETAILS OR DESIGN SHOWN ON THESE PLANS AND SPECIFICATIONS MUST BE APPROVED BY THE ENGINEER PRIOR TO INSTALLATION. ANY CHANGES MADE BY A PRIMARY OR SUB-CONTRACTOR WITHOUT APPROVAL FROM THE ENGINEER AND LATER FOUND TO BE NON-COMPLIANT WITH THE DETAILS AS SHOWN IN THE THESE PLANS AND SPECIFICATIONS AND FEDERAL, STATE AND LOCAL LAW WILL BE REMOVED AND REPLACED AND MADE FULLY COMPLIANT REGARDLESS OF MAGNITUDE AT THE EXPENSE OF THE CONTRACTOR. THE CONTRACTOR SHALL FOLLOW THE RFI PROCESS IN ESTABLISHING THE APPROVAL OR DENIAL OF CHANGES TO ADA RELATED DETAILS OR MOUNTING DIMENSIONS.

1/8" MAXIMUM DEPTH TO TOP OF SEALANT AND 1/8" MAXIMUM PROTRUSION TO TOP OF SEALANT ALONG ADA ACCESS ROUTES.

#### **SITE INFORMATION:**

380-220-066

M-29 (MULTIPLE FAMILY RESIDENTIAL DISTRICT) THE PROPERTY LIES WITHIN FLOOD ZONE 'X' PER FIRM PANEL NO: 06001C0059G, DATED AUGUST 3, 2009. ZONE X IS DEFINED AS "AREAS OF 0.2% ANNUAL CHANCE FLOOD.

**SUMMARY:** PARCEL AREA  $= \pm 32,830 \text{ SF } (\pm 0.772 \text{ ACRES})$ TOTAL DISTURBED AREA  $= \pm 32,830 \text{ SF } (\pm 0.772 \text{ ACRES})$ PROPOSED BUILDING FOOTPRINT AREA =  $\pm$  7,470 SF

ON-SITE AREA SUMMARY: TOTAL DISTURBED ONSITE AREA  $= \pm 32,830$  SF EXISTING IMPERVIOUS AREA  $= \pm 0$  SF EXISTING PERVIOUS AREA  $= \pm 32,830$  SF PROPOSED IMPERVIOUS AREA  $= \pm 26,167 \text{ SF } (80\%)$ PROPOSED PERVIOUS AREA  $= \pm 6,663$  SF (20%) PROPOSED PLANTED AREA  $= \pm 6,663$  SF CHANGE IN IMPERVIOUS AREA  $= \pm 26,167$  SF INCREASE

PAVED PARKING AREA SUMMARY: = 33PROPOSED PARKING COUNT PROPOSED PARKING AREA  $= \pm 5,608$  SF REQUIRED LANDSCAPE AREA  $= \pm 280 \text{ SF}$ PROPOSED LANDSCAPE AREA  $= \pm 1,621 \text{ SF}$ 

**LEGEND EXISTING** PROPERTY LINE \_\_\_\_\_\_ EASEMENT LINE — — — APPROXIMATE LIMIT OF DISTURBANCE 1-FOOT CONTOUR 5-FOOT CONTOUR WATER LINE FIRE PROTECTION WATER LINE ----- WTR ---IRRIGATION WATER LINI SANITARY SEWER LINE STORM DRAIN LINE OVERHEAD ELECTRIC CURRENT COPY OF SAID CODES TO BE MAINTAINED ON SITE AT GAS LINE UNDERGROUND ELECTRIC UNDERGROUND TELEPHONE FENCE TREE WATER VALVE/BACK FLOW PREVENTER FIRE HYDRANT WATER METER OR BOX SEWER MANHOLE S SANITARY SEWER CLEANOUT sço STORM DRAIN MANHOLE CATCH BASIN/AREA DRAIN STORM CLEANOUT GAS METER/BOX GAS VALVE STREET LIGHT/LIGHT POLE/YARD ELECTRIC PEDESTAL/BOX/VAULT EM 🗆 🖺 o ELECTRIC TRANSFORMER STANDARD PCC PAVEMENT STANDARD PERVIOUS AC PAVEMENT STANDARD AC PAVEMENT PROPOSED FIRE LANE LANDSCAPE AREA. SEE LANDSCAPE FOR DETAILS. BIORETENTION FLOW THROUGH PLANTER

#### SITE PLAN KEY NOTES

DIRECTIONAL SHEET FLOW LINE

- PROPOSED CONCRETE RETAINING CURB, PER CONTRA COSTA COUNTY STANDARD DETAIL CA71. SEE GRADING PLAN FOR ELEVATIONS.
- PROPOSED ACCESSIBLE PARKING STALL, WITH PCC WHEELSTOP,
- ACCESSIBLE LOADING AND ACCESSIBLE MARKING.
- PROPOSED ADA ACCESSIBLE RAMP WITH DEPRESSED CURB AND DETECTIBLE WARNING, PER CALTRANS STANDARD DETAILS A88A AND A88B.
- PROPOSED 4" WIDE PARKING STRIPE. TRAFFIC WHITE PAINT, MINIMUM TWO COATS.
- PROPOSED CONCRETE CURB AND GUTTER, PER CONTRA COSTA COUNTY STANDARD DETAIL CA71.
- PROPOSED CONCRETE DRIVEWAY RAMP, PER CONTRA COSTA COUNTY STANDARD DETAIL CA72.
- PROPOSED RETAINING WALL. SEE GRADING PLAN FOR ELEVATIONS AND
- $\stackrel{\prime}{-}$  structural plans for detail. 8 PROPOSED DEAD END PARKING TURN-AROUND SPACE
- PROPOSED TRASH ENCLOSURE LOCATION. SEE ARCHITECTURAL PLANS FOR DETAILS.
- 10 PROPOSED ELECTRICAL VEHICLE CHARGING SPACE.
- 11 PROPOSED CURB CUT FOR DRAINAGE.
- 12 PROPOSED GUTTER.
- PROPOSED PARKING CANOPY SUPPORT COLUMN. SEE ARCHITECTURAL PLANS.
- 14 PROPOSED PARKING CANOPY OVERHANG. SEE ARCHITECTURAL PLANS.

ARCHITECTURAI CONCEPTS **ARCHITECTURE INTERIOR DESIGN** 

**MASTER PLANNING** 509 Ramona Avenue Albany, Ca 94706 -1431 T/F 510-525-9630 jcowee8@gmail.com www.architectural-concepts.ne

NOT FOR CONSTRUCTION

CONSULTANT



3240 PERALTA STREET, #3 OAKLAND, CA 9460 (510) 250-7877 WWW.CALICHI.COM

**PLANNING** 22/03/15 **PLANNING** 19/10/08 RESUBMITTAL


SUBMITTAL REVISIONS JOB:


**DATE:** 2022/03/15

SHEET TITLE:

SITE, PAVING, AND HORIZONTAL **CONTROL PLAN** 

SHEET NO.

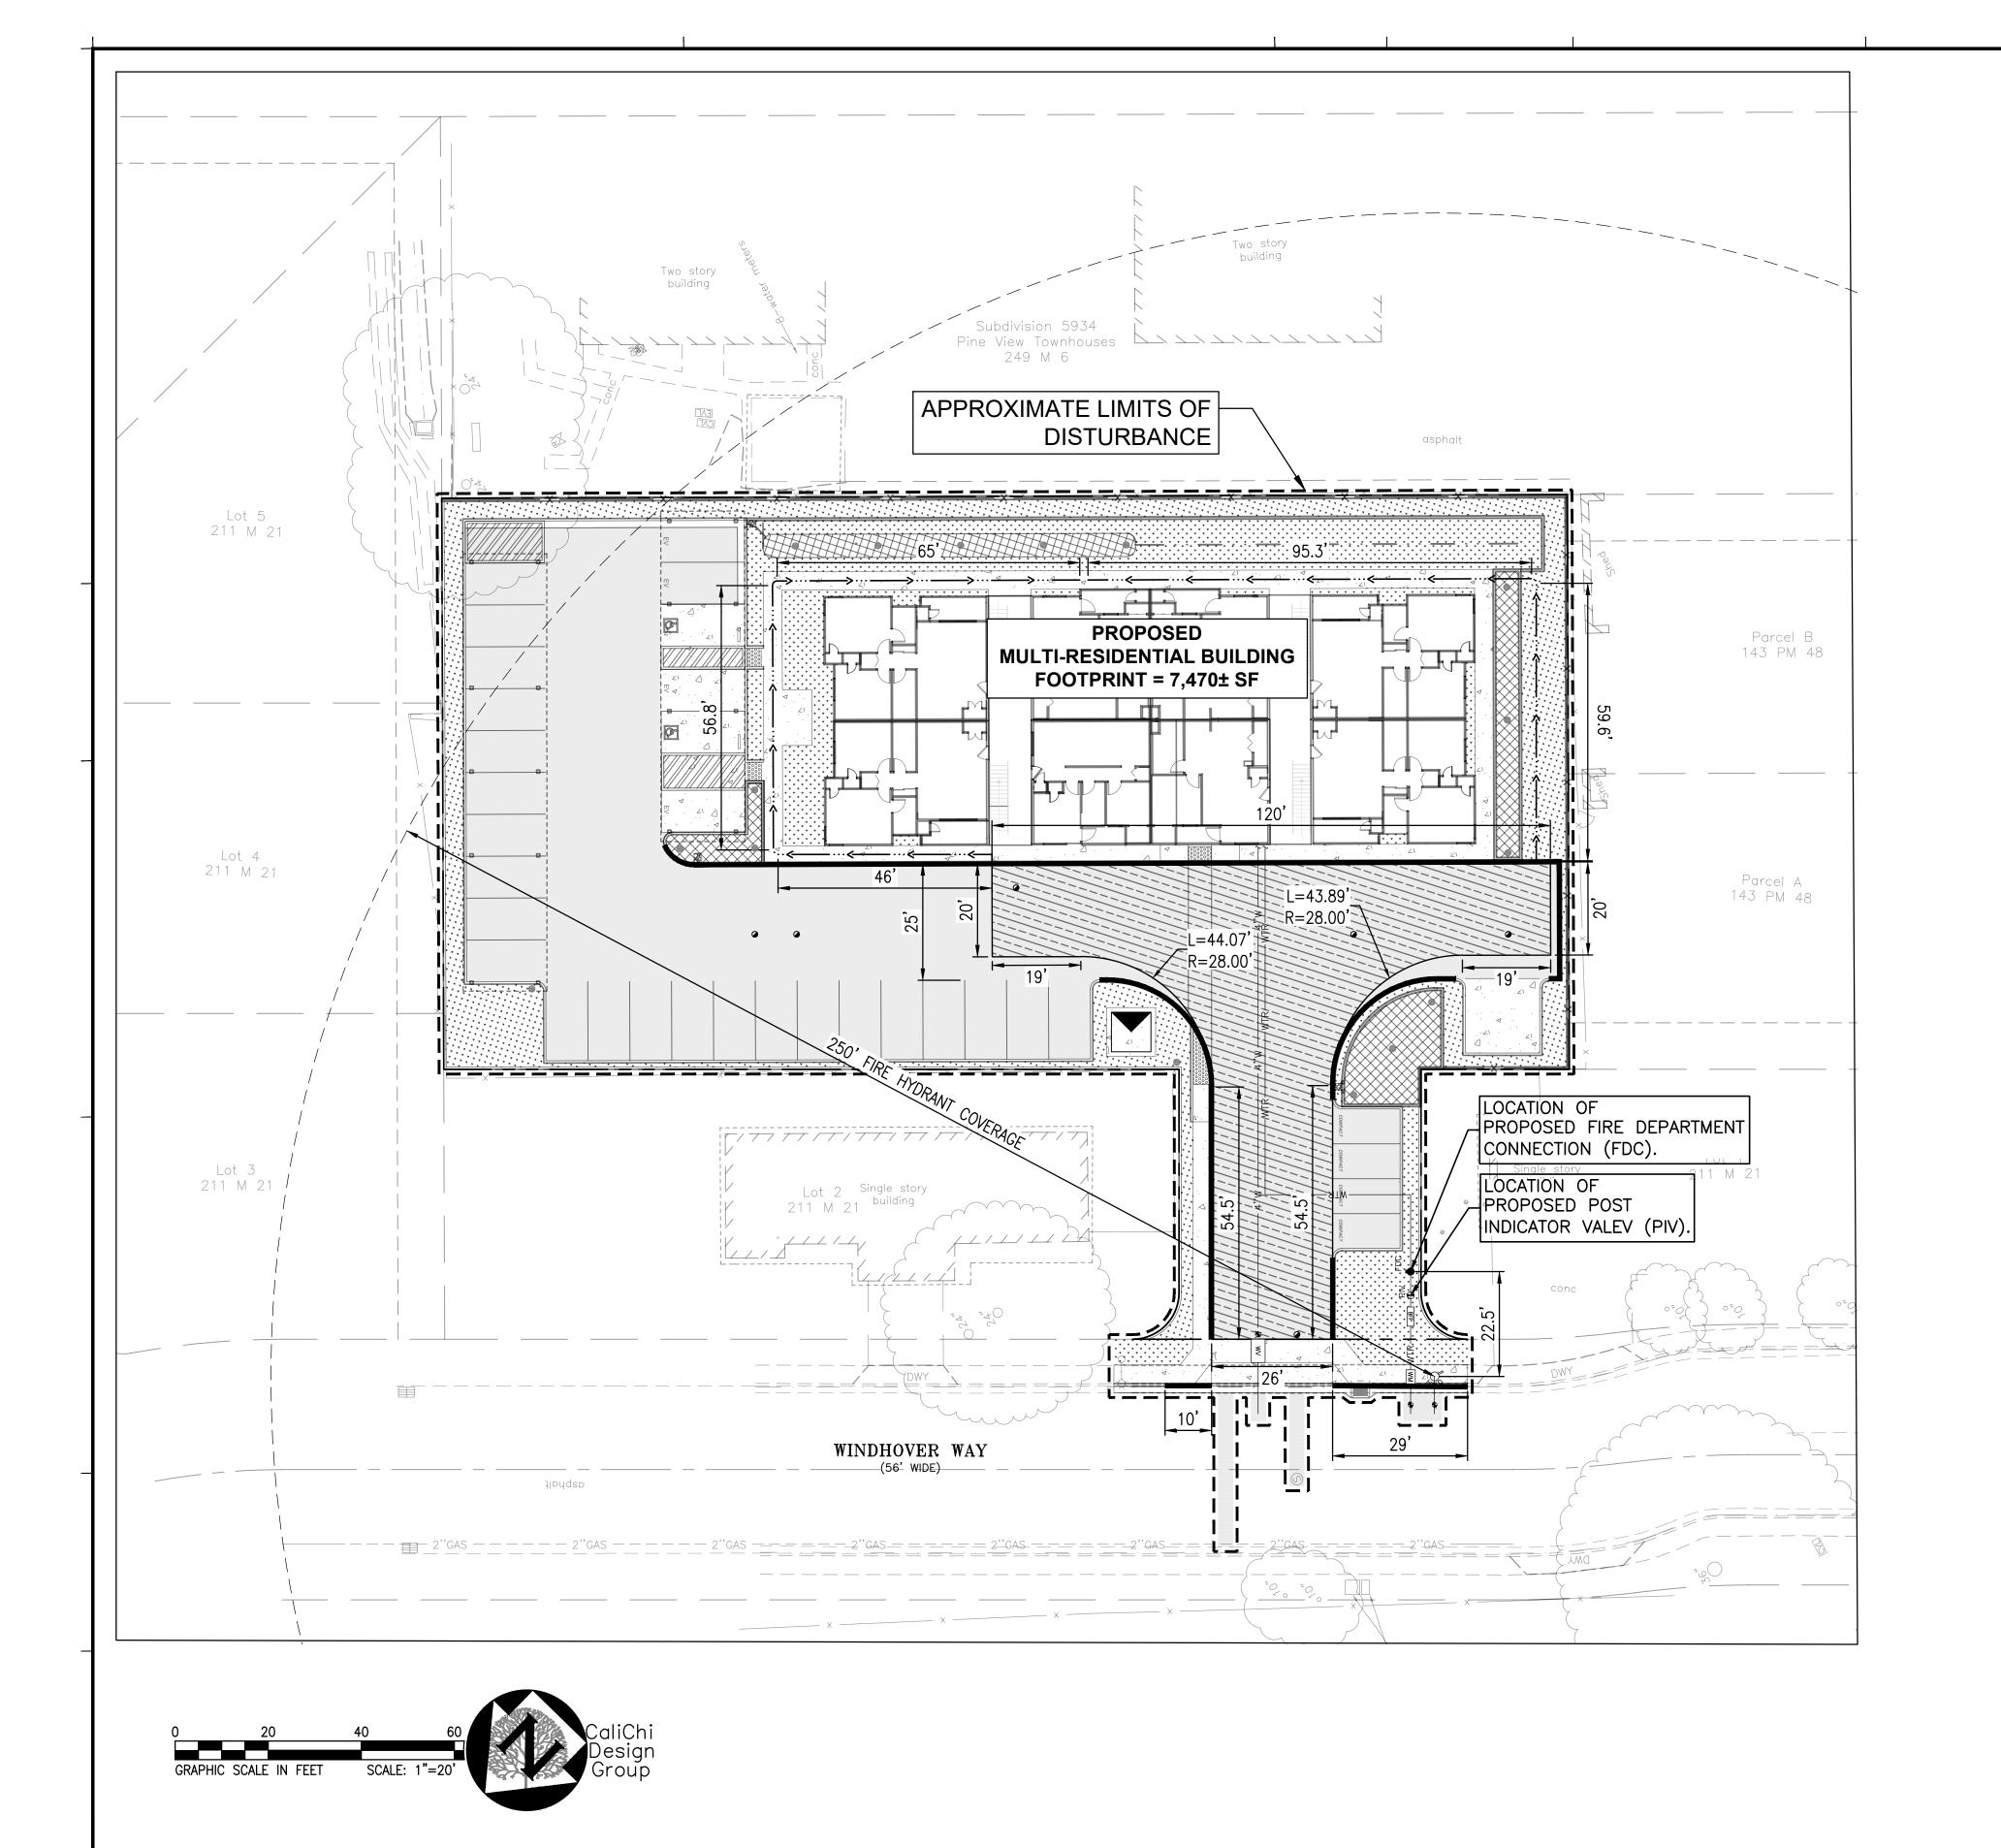

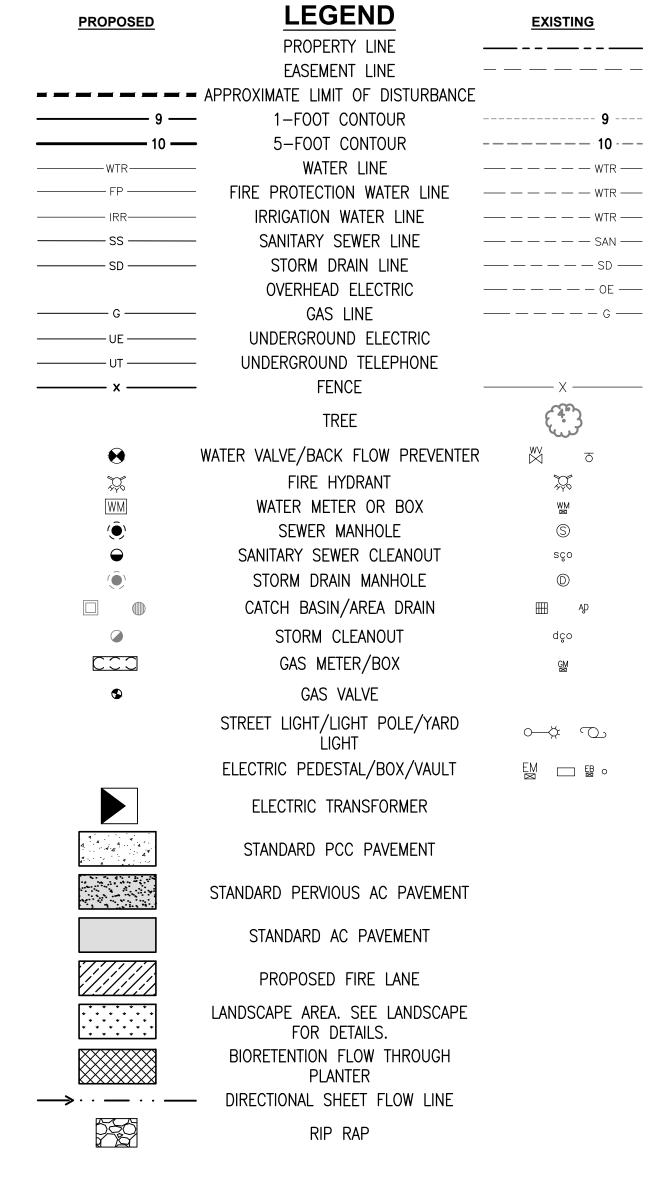

#### FIRE PLAN LEGEND

RED CURB DENOTING NO PARKING — FIRE LANE (SEE PLAN FOR DIMENSIONS). NOTE THAT ALL RED CURBS SHALL HAVE "NO PARKING - FIRE LANE" SIGNS EVERY 100—LF

ULWAY APARTME WINDHOVER WA APN: 380-220-066

**ARCHITECTURAL** 

CONCEPTS

ARCHITECTURE

**INTERIOR DESIGN** 

**MASTER PLANNING** 

509 Ramona Avenue

Albany, Ca 94706 -1431 T/F 510-525-9630

jcowee8@gmail.com

www.architectural-concepts.ne

NOT FOR

CONSTRUCTION

ALICHI DESIGN GROU

**CIVIL ENGINEERS** 

3240 PERALTA STREET, #3 OAKLAND, CA 9460 (510) 250-7877 WWW.CALICHI.COM

CONSULTANT:

PLANNING
R2
PLANNING
RESUBMITTAL
SCP
SUBMITTAL
19/08/22

REVISIONS D

**DATE:** 2022/03/15

SHEET TITLE:


FIRE


PROTECTION EXHIBIT


SHEET NO.


C1.1

EVISION NO. 0

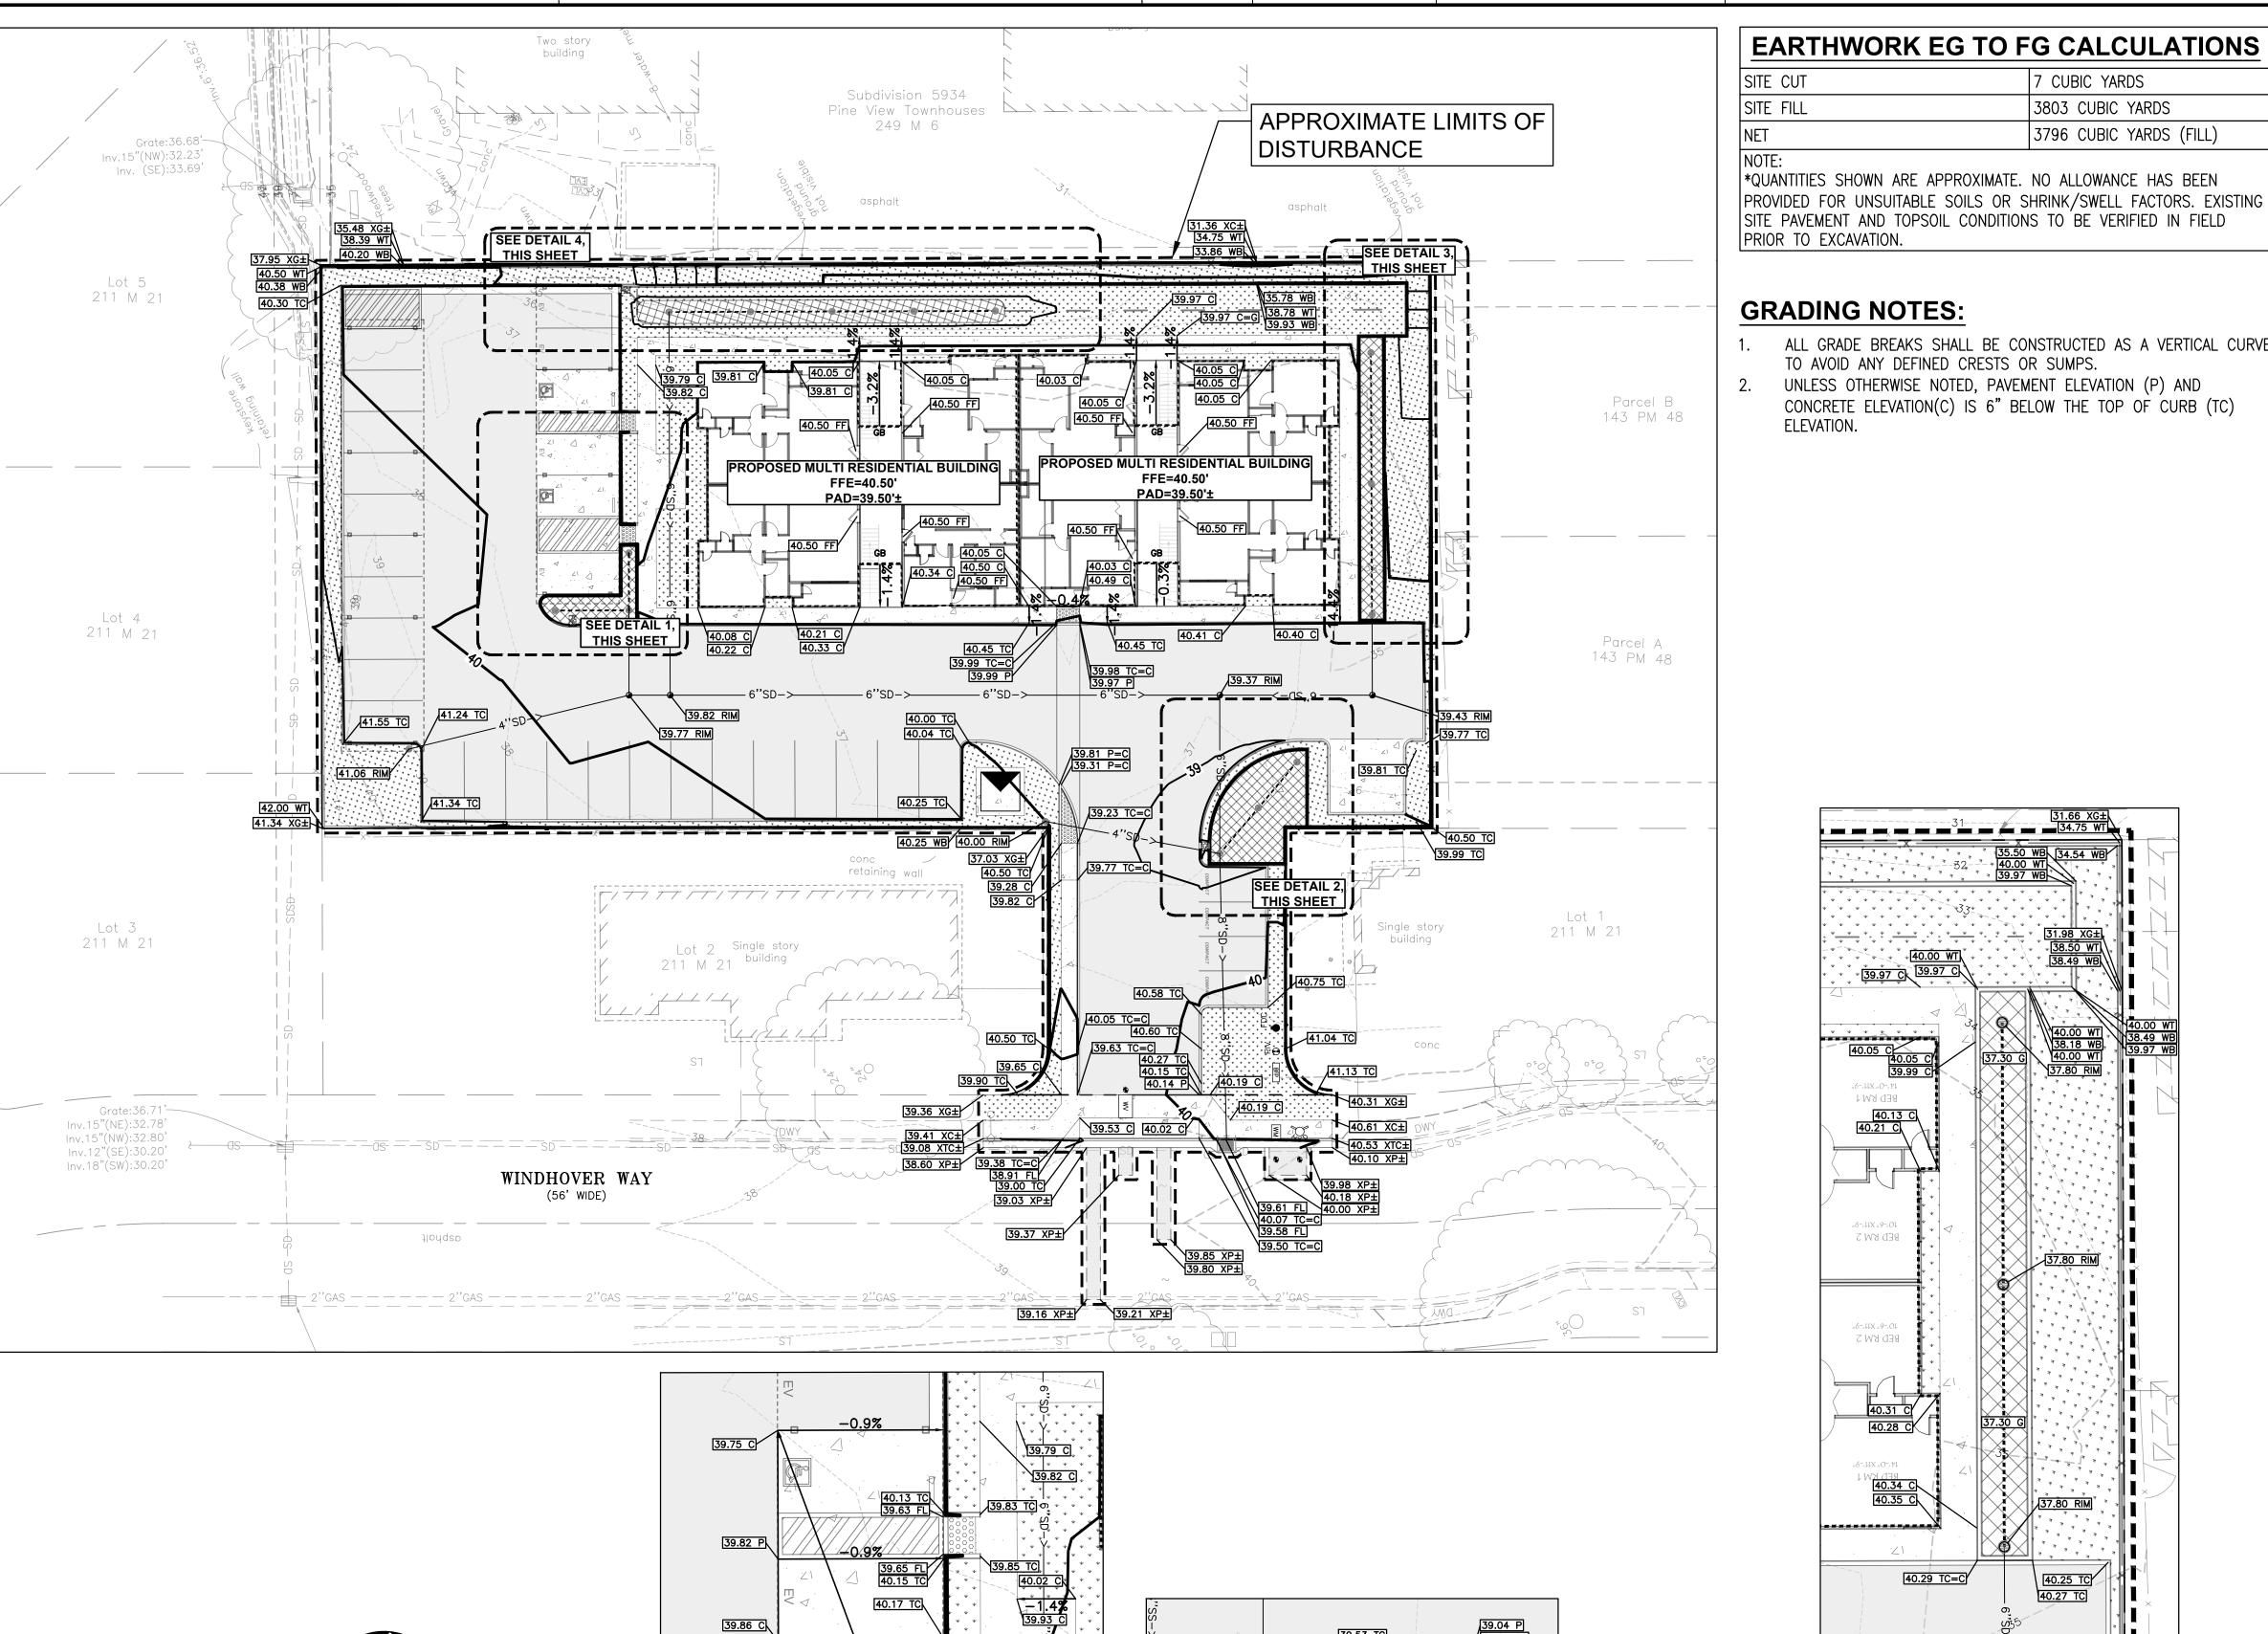

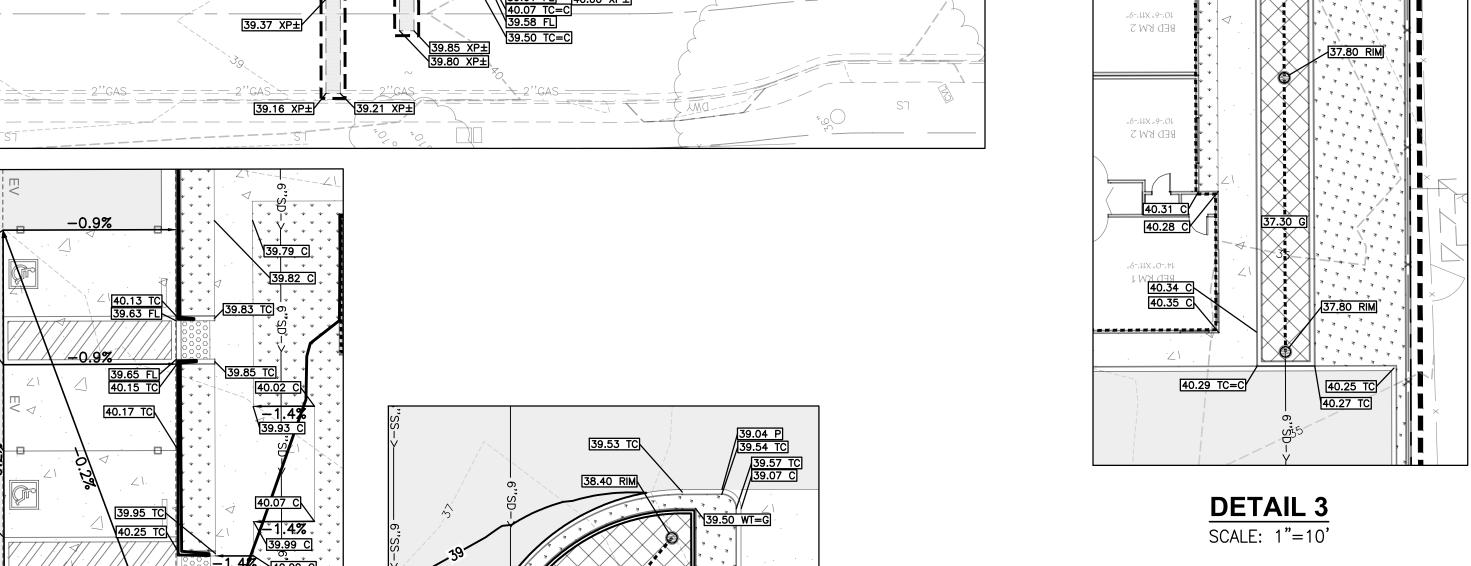

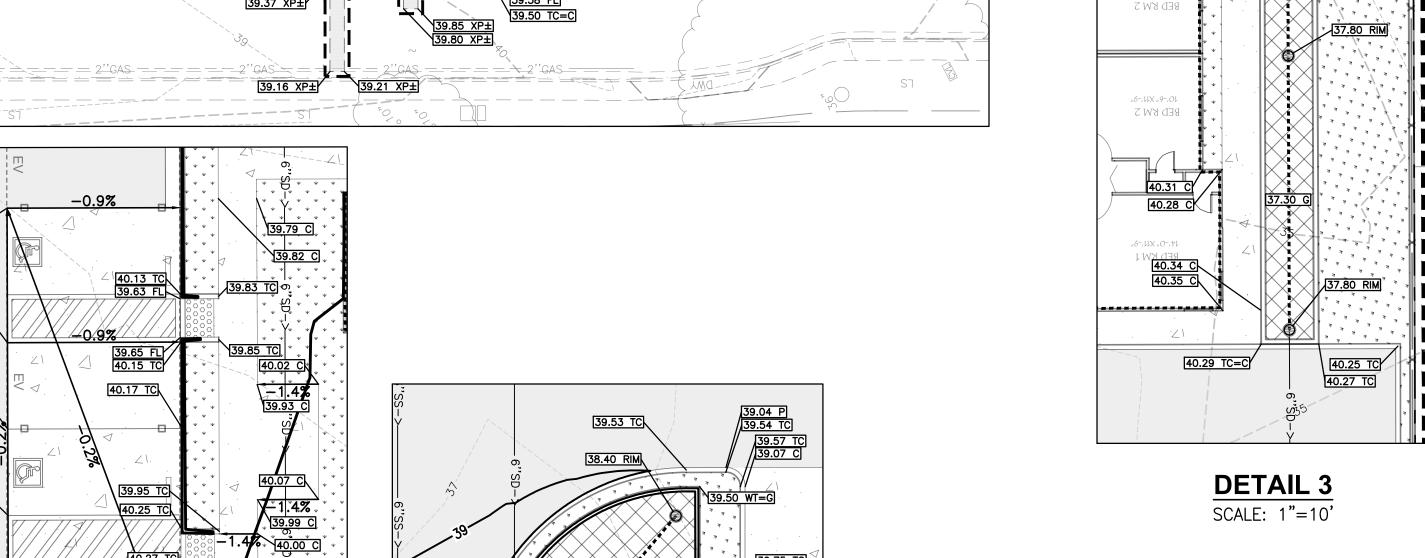

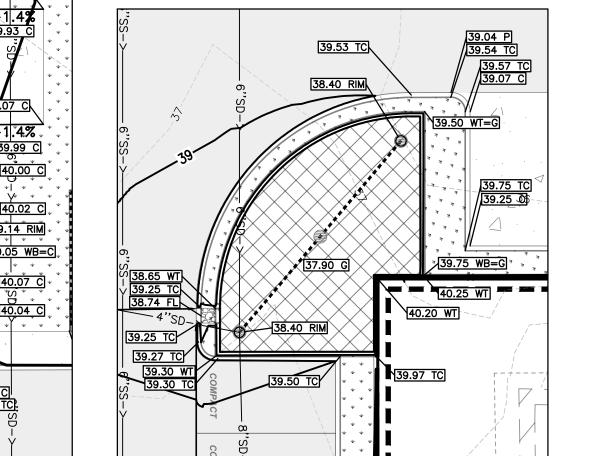

**DETAIL 1** SCALE: 1"=10'

39.91 TC

39.85 C

39.84 C

39.83 C

**ENGINEERS NOTE TO THE** 

**CONTRACTOR:** 

THE EXISTENCE AND LOCATION OF ANY

UNDERGROUND UTILITIES, PIPES AND/OR

STRUCTURES SHOWN ON THESE PLANS WERE

DBTAINED BY A SEARCH OF AVAILABLE RECORDS. TO THE BEST OF OUR KNOWLEDGE, THERE ARE


NO EXISTING UTILITIES EXCEPT AS SHOWN ON THESE PLANS. THE CONTRACTOR SHALL

ASCERTAIN THE TRUE VERTICAL AND HORIZONTAL LOCATION AND SIZE OF ANY UNDERGROUND UTILITIES AND SHALL BE RESPONSIBLE FOR

WWW.USANORTH.ORG DAMAGE TO PUBLIC OR PRIVATE UTILITIES SHOWN

CALL TWO WORKING DAYS BEFORE YOU DIG OR NOT SHOWN HEREON.

**DETAIL 2** SCALE: 1"=10'

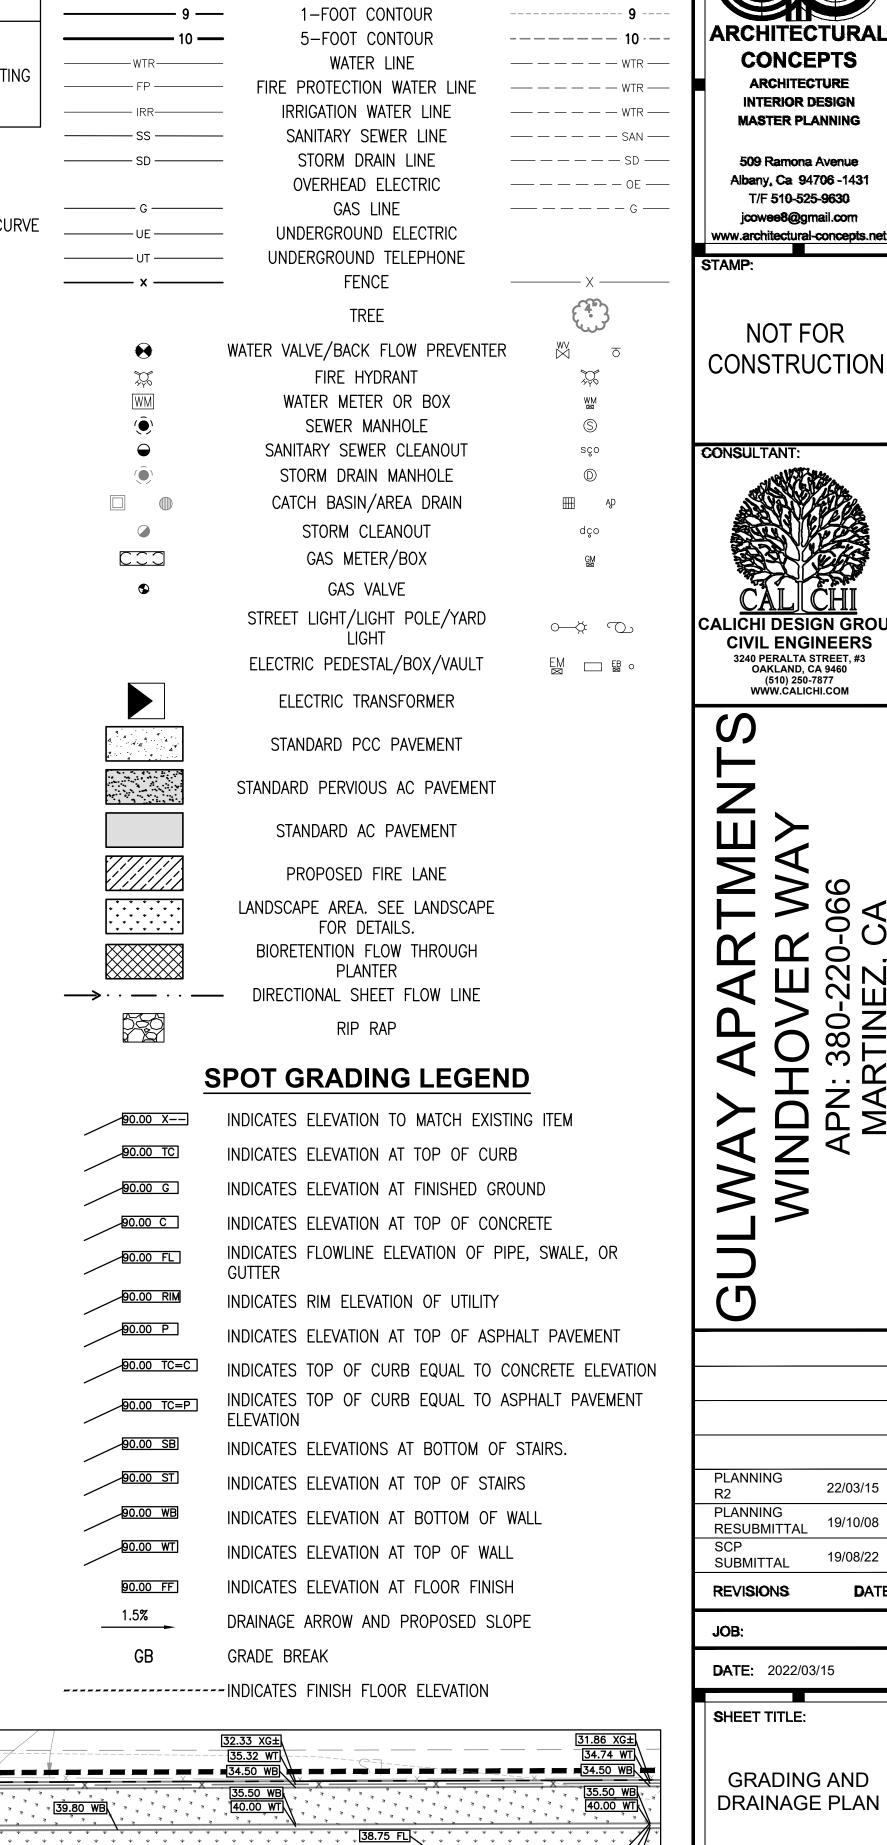

**LEGEND** 

PROPERTY LINE

EASEMENT LINE

- APPROXIMATE LIMIT OF DISTURBANCE

**PROPOSED** 

7 CUBIC YARDS

3803 CUBIC YARDS

3796 CUBIC YARDS (FILL)

**EXISTING** \_\_\_\_\_ ARCHITECTURAI

CONCEPTS ARCHITECTURE **INTERIOR DESIGN MASTER PLANNING** 

509 Ramona Avenue

Albany, Ca 94706 -1431


T/F 510-525-9630 jcowee8@gmail.com www.architectural-concepts.ne

NOT FOR CONSTRUCTION



**CIVIL ENGINEERS** 

3240 PERALTA STREET, #3 OAKLAND, CA 9460 (510) 250-7877 WWW.CALICHI.COM

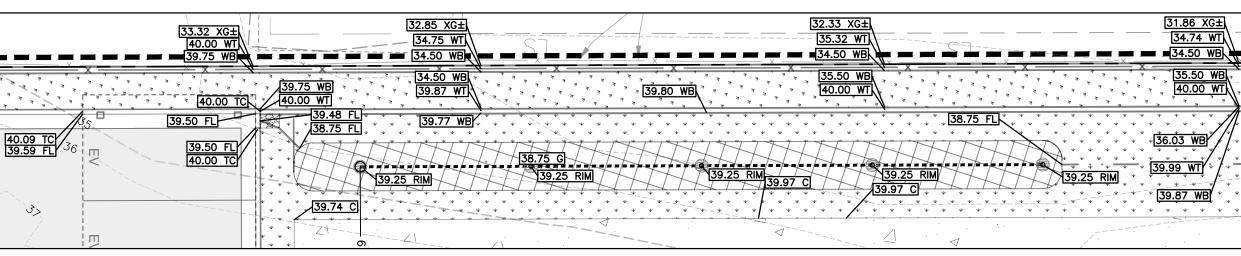

**DETAIL 4** SCALE: 1"=10'


40.00 WT) 39.97 C 39.97 C

REVISION NO. 0

SHEET NO.

**GRADING AND** 

22/03/15

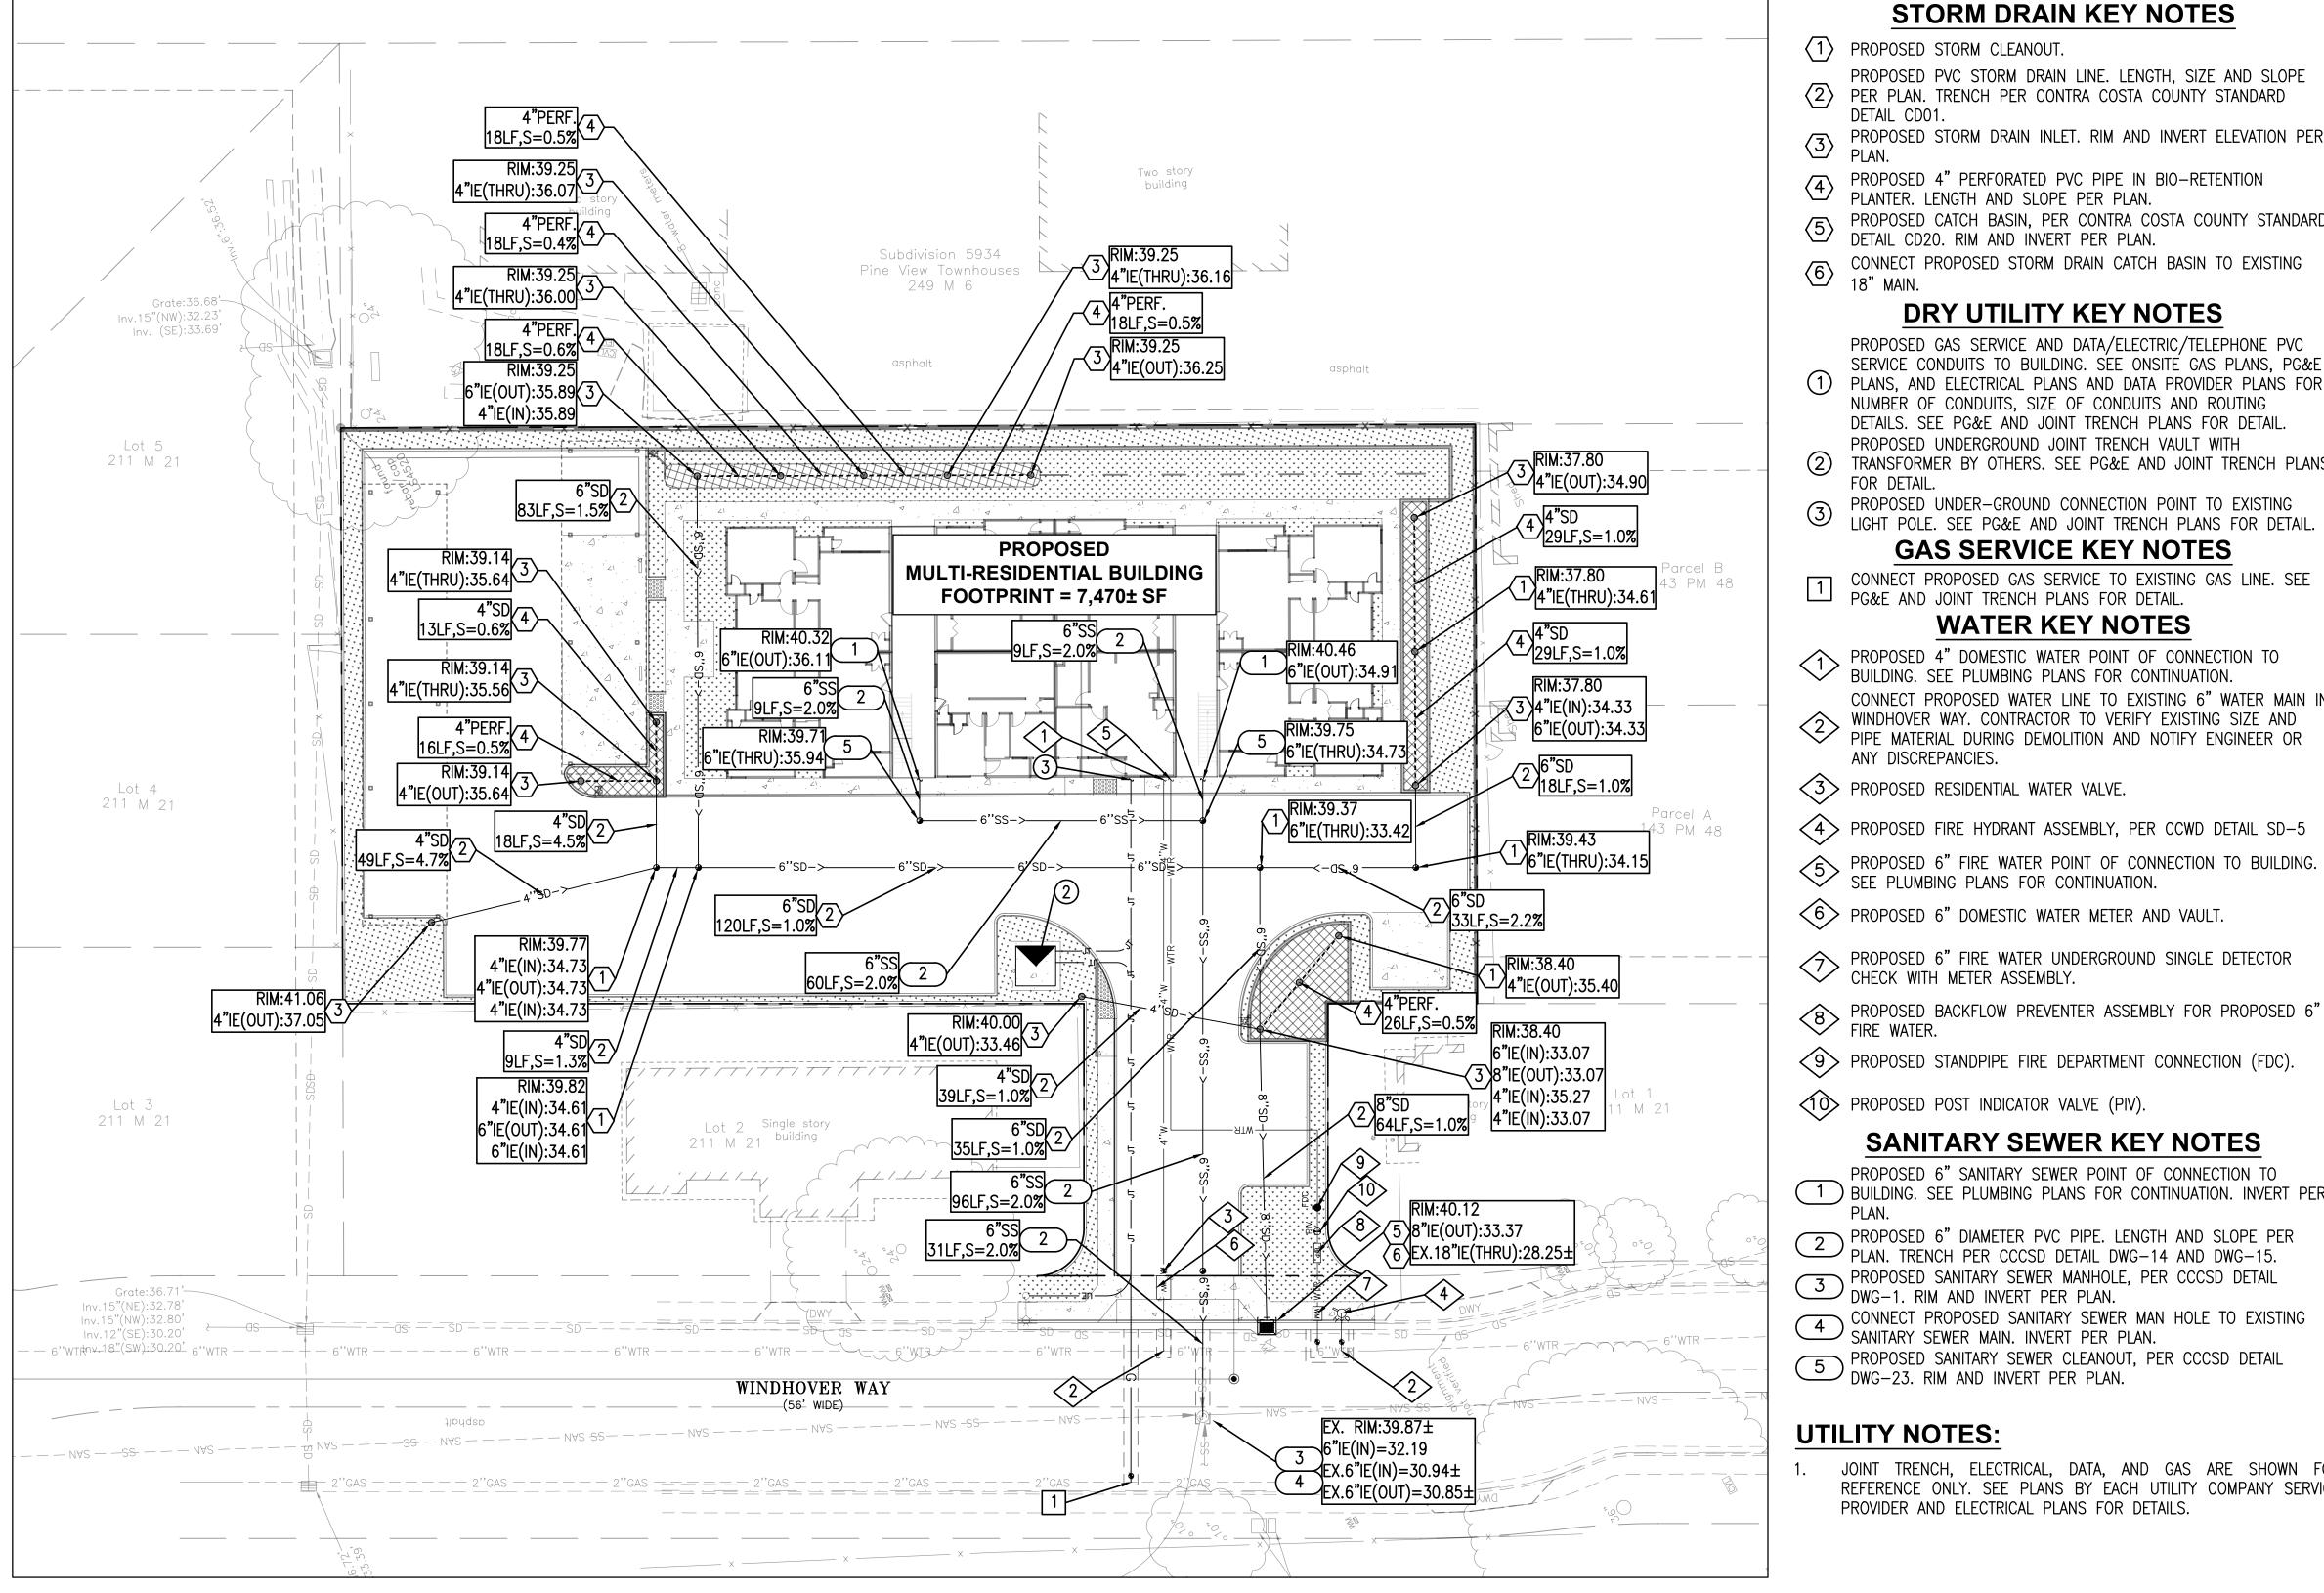

**LEGEND EXISTING** PROPERTY LINE \_\_\_\_\_ EASEMENT LINE PROPOSED PVC STORM DRAIN LINE. LENGTH, SIZE AND SLOPE - - - APPROXIMATE LIMIT OF DISTURBANCE 1-FOOT CONTOUR PROPOSED STORM DRAIN INLET. RIM AND INVERT ELEVATION PER 5-FOOT CONTOUR WATER LINE FIRE PROTECTION WATER LINE —— — — — WTR — IRRIGATION WATER LINI PROPOSED CATCH BASIN, PER CONTRA COSTA COUNTY STANDARD SANITARY SEWER LINE STORM DRAIN LINE CONNECT PROPOSED STORM DRAIN CATCH BASIN TO EXISTING OVERHEAD ELECTRIC GAS LINE UNDERGROUND ELECTRIC PROPOSED GAS SERVICE AND DATA/ELECTRIC/TELEPHONE PVC UNDERGROUND TELEPHONE SERVICE CONDUITS TO BUILDING. SEE ONSITE GAS PLANS, PG&E FENCE PLANS, AND ELECTRICAL PLANS AND DATA PROVIDER PLANS FOR TREE WATER VALVE/BACK FLOW PREVENTER TRANSFORMER BY OTHERS. SEE PG&E AND JOINT TRENCH PLANS FIRE HYDRANT WATER METER OR BOX SEWER MANHOLE S LIGHT POLE. SEE PG&E AND JOINT TRENCH PLANS FOR DETAIL. SANITARY SEWER CLEANOUT sço STORM DRAIN MANHOLE CONNECT PROPOSED GAS SERVICE TO EXISTING GAS LINE. SEE CATCH BASIN/AREA DRAIN STORM CLEANOUT GAS METER/BOX GAS VALVE CONNECT PROPOSED WATER LINE TO EXISTING 6" WATER MAIN IN STREET LIGHT/LIGHT POLE/YARD WINDHOVER WAY, CONTRACTOR TO VEINITE ENGINEER OR PIPE MATERIAL DURING DEMOLITION AND NOTIFY ENGINEER OR WINDHOVER WAY. CONTRACTOR TO VERIFY EXISTING SIZE AND ELECTRIC PEDESTAL/BOX/VAULT EM 🗆 🖺 o ELECTRIC TRANSFORMER

STANDARD PCC PAVEMENT

STANDARD PERVIOUS AC PAVEMENT

STANDARD AC PAVEMENT

PROPOSED FIRE LANE

LANDSCAPE AREA. SEE LANDSCAPE

FOR DETAILS.

BIORETENTION FLOW THROUGH

PLANTER

DIRECTIONAL SHEET FLOW LINE

STORM DRAIN KEY NOTES

(2) PER PLAN. TRENCH PER CONTRA COSTA COUNTY STANDARD

PROPOSED 4" PERFORATED PVC PIPE IN BIO-RETENTION

DRY UTILITY KEY NOTES

NUMBER OF CONDUITS, SIZE OF CONDUITS AND ROUTING

PROPOSED UNDERGROUND JOINT TRENCH VAULT WITH

DETAILS. SEE PG&E AND JOINT TRENCH PLANS FOR DETAIL

PROPOSED UNDER-GROUND CONNECTION POINT TO EXISTING

**GAS SERVICE KEY NOTES** 

**WATER KEY NOTES** 

BUILDING. SEE PLUMBING PLANS FOR CONTINUATION.

PROPOSED 6" FIRE WATER UNDERGROUND SINGLE DETECTOR CHECK WITH METER ASSEMBLY.

**SANITARY SEWER KEY NOTES** 

PROPOSED 6" SANITARY SEWER POINT OF CONNECTION TO 1 ) BUILDING. SEE PLUMBING PLANS FOR CONTINUATION. INVERT PER

PROPOSED 6" DIAMETER PVC PIPE. LENGTH AND SLOPE PER PLAN. TRENCH PER CCCSD DETAIL DWG-14 AND DWG-15.

PG&E AND JOINT TRENCH PLANS FOR DETAIL.


PLANTER. LENGTH AND SLOPE PER PLAN.

DETAIL CD20. RIM AND INVERT PER PLAN.

1 PROPOSED STORM CLEANOUT.

FOR DETAIL.

ANY DISCREPANCIES.

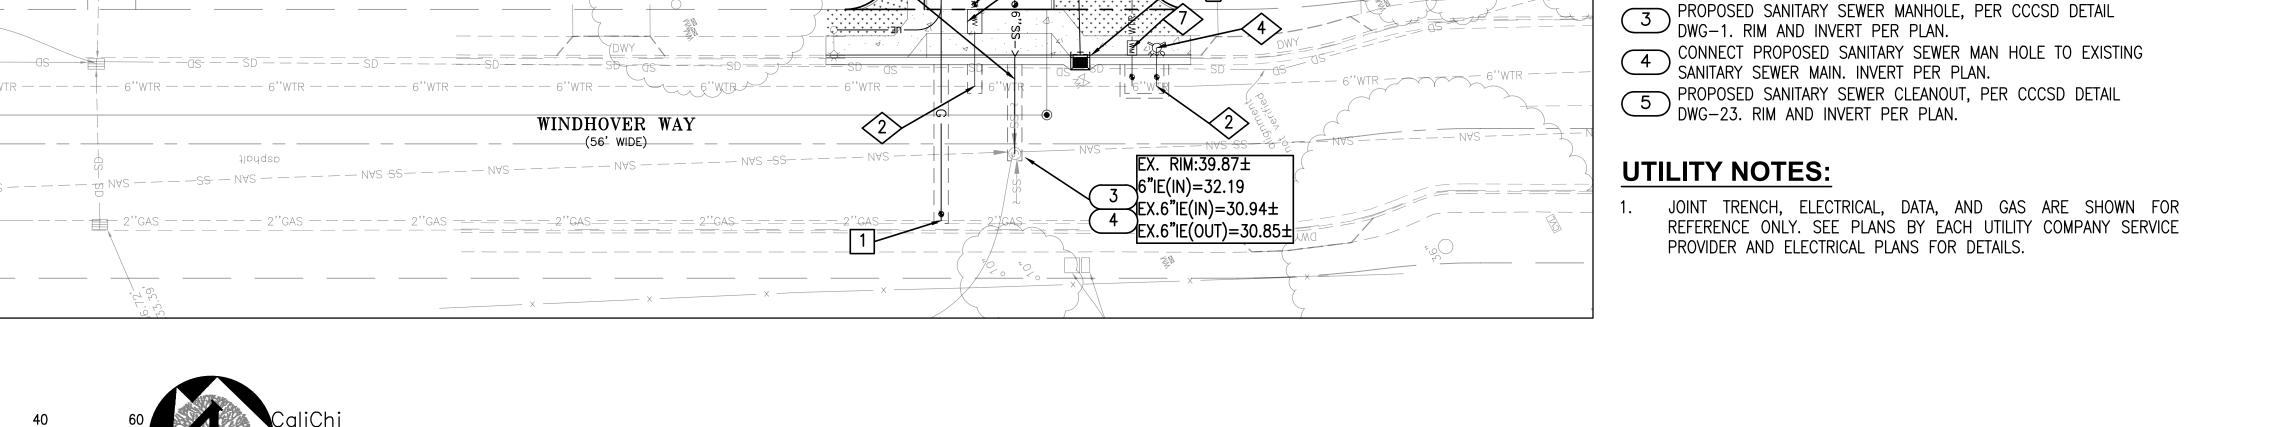

ARCHITECTURAI CONCEPTS **ARCHITECTURE INTERIOR DESIGN MASTER PLANNING** 509 Ramona Avenue Albany, Ca 94706 -1431 T/F 510-525-9630 jcowee8@gmail.com www.architectural-concepts.ne NOT FOR CONSTRUCTION CONSULTANT ALICHI DESIGN GROU **CIVIL ENGINEERS** 3240 PERALTA STREET, #3 OAKLAND, CA 9460 (510) 250-7877 WWW.CALICHI.COM 0

PLANNING 22/03/15 PLANNING 19/10/08 RESUBMITTAL SUBMITTAL


**REVISIONS** JOB:

**DATE:** 2022/03/15

SHEET TITLE:

**UTILITY PLAN** 


SHEET NO.

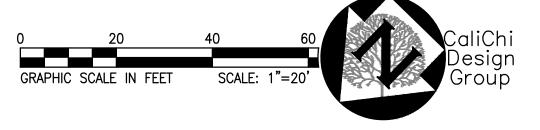




#### **ENGINEERS NOTE TO THE CONTRACTOR:**

THE EXISTENCE AND LOCATION OF ANY UNDERGROUND UTILITIES, PIPES AND/OR STRUCTURES SHOWN ON THESE PLANS WERE DBTAINED BY A SEARCH OF AVAILABLE RECORDS. TO THE BEST OF OUR KNOWLEDGE, THERE ARE NO EXISTING UTILITIES EXCEPT AS SHOWN ON THESE PLANS. THE CONTRACTOR SHALL ASCERTAIN THE TRUE VERTICAL AND HORIZONTAL LOCATION AND SIZE OF ANY UNDERGROUND UTILITIES AND SHALL BE RESPONSIBLE FOR WWW.USANORTH.ORG DAMAGE TO PUBLIC OR PRIVATE UTILITIES SHOWN

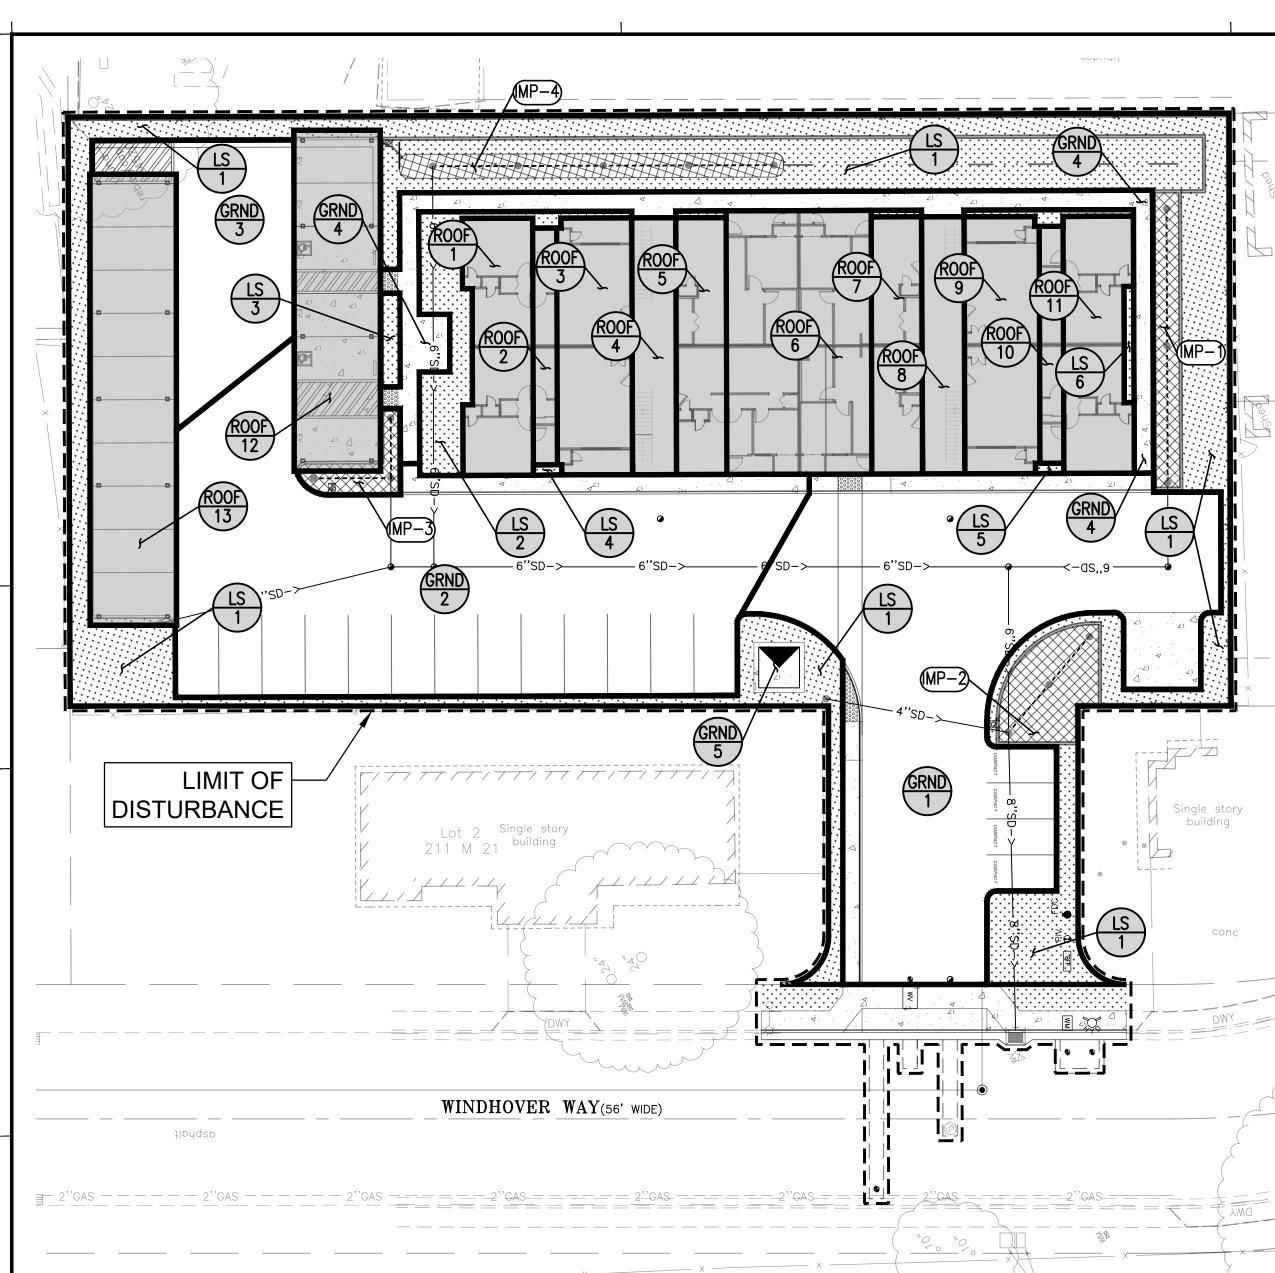

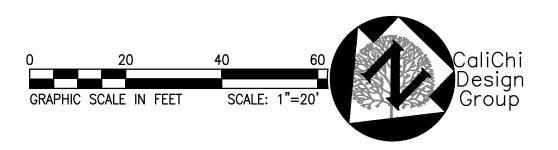

#### ON-SITE BIORETENTION FACILITY MAINTENANCE PLAN

ROUTINE MAINTENANCE (MONTHLY INSPECTIONS, OR AS NEEDED AFTER STORM EVENTS):

- INSPECT THE PLANTER SURFACE AREA, INLETS AND OUTLETS FOR OBSTRUCTIONS AND TRASH; CLEAR AND OBSTRUCTIONS AND REMOVE TRASH, FALLEN LEAVES, AND DEBRIS.
- INSPECT PLANTER BOX AFTER STORMS TO ENSURE STRUCTURAL INTEGRITY OF THE BOX AND THAT THE PLANTER IS NOT CLOGGING, AND IS DRAINING WITHIN 3-4 HOURS AFTER STORM EVENTS. IF PONDED WATER DOES NOT DRAIN, THE SURFACE SOILS SHOULD BE TILLED OR REPLACED AND REPLANTED AS NECESSARY. IF MOSQUITO LARVAE ARE OBSERVED, CONTACT THE COUNTY VECTOR CONTROL DISTRICT AT (510) 567-6800.
- INSPECT THE ENERGY DISSIPATION AT THE INLET TO ENSURE IT IS FUNCTIONING ADEQUATELY, AND THAT THERE IS NO SCOUR OF THE SURFACE MULCH AND REMOVE ANY ACCUMULATION OF SEDIMENT.
- CHECK THAT MULCH IS AT APPROPRIATE DEPTH (2 INCHES PER SOIL SPECIFICATIONS) AND REPLENISH AS NECESSARY.

BI-ANNUAL INSPECTION (AT LEAST TWICE A YEAR):

- PRUNE AND WEED THE PLANTER AREA. REMOVE AND REPLACE ANY DEAD OR DYING PLANTS.
- TREAT DISEASED PLANTS, AS NEEDED, USING PREVENTATIVE AND LOW-TOXIC MEASURES TO
- THE EXTENT POSSIBLE. AVOID THE USE OF PESTICIDES AND QUICK—RELEASE SYTHETIC FERTILIZERS AND FOLLOW
- THE PRINCIPLES OF INTEGRATED PEST MANAGEMENT (IPM). CHECK WITH THE LOCAL JURISDICTION FOR ANY LOCAL POLICIES REGARDING THR USE OF PESTICIDES AND FERTILIZERS.
- MAINTAIN THE IRRIGATION SYSTEM AND ENSURE THAT PLANTS ARE RECEIVING THE CORRECT AMOUNT OF WATER (IF APPLICABLE).
- ANNUAL INSPECTION (JUST PRIOR TO THE WET SEASON):
- APPLY 1" TO 2" OF COMPOSED MULCH TO BE APPLIED ONCE A YEAR AND WHEN EROSION IS EVIDENT; SPOT MULCHING MAY BE SUFFICIENT FOR RANDOM VOID AREAS.

#### **INSPECTION AND MAINTENANCE**

RESPONSIBLE PARTY FOR BMP MAINTENANCE: TBD

**Project Name: Gulway Apartment Project Type: Treatment Only** APN: 380-220-066 Drainage Area: 32,830 **Mean Annual Precipitation: 16.3** 

#### **II. Self-Retaining Areas**

Self-Retaining DMA						
DMA Name	Area (sq ft)					
LS-6	49					
LS-5	13					
LS-4	13					
LS-3	80					
LS-2	530					
LS-1	5,968					

**III. Areas Draining to Self-Retaining Areas** 

DMA Name	Area (sq ft)	Surface Type	Runoff Factor	<b>\</b>	Receiving Self Retaining DMA		Ratio [A]/[B]
GRND-5	110	Concrete or Asphalt	1.0	110.0	LS-1	5.968	0.02

#### IV. Areas Draining to IMPs

IMP Name: IMP1

**IMP Type: Bioretention Facility** Soil Group: IMP1

DMA Name	Area (sq ft)	Post Project	<b>DMA Runoff</b>	DMA Area x				
		Surface Type	Factor	Runoff Factor	IMP Sizing			
ROOF-11	736	Conventional Roof	1.00	736	IMP Sizing Factor	Rain Adjustment	Minimum Area or	Proposed Area or
			Total	736	1 dotoi	Factor	Volume	Volume
				Δrea	0.040	1,000	29	306

IMP Name: IMP2 **IMP Type: Bioretention Facility** 

Soil Group: IMP2

<b>DMA Name</b>	Area (sq ft)	Post Project			IMD Sizing			
		Surface Type	Factor	Runoff Factor	IMP Sizing			
GRND-1	5,785	Concrete or	1.00	5,785	IMP Sizing	Rain	Minimum	Proposed
		Asphalt			Factor	Adjustment	Area or	Area or
ROOF-6	1,659	Conventional Roof	1.00	1,659		Factor	Volume	Volume
ROOF-7	564	Conventional Roof	1.00	564				
ROOF-8	471	Conventional Roof	1.00	471				
ROOF-9	834	Conventional Roof	1.00	834				
ROOF-10	246	Conventional Roof	1.00	246				
			Total	9,559				
				Area	0.040	1.000	382	385

**IMP Name: IMP3** 

IMP Type: Bioretention Facility

Soil Group: IM	IP3							
<b>DMA Name</b>	Area (sq ft)	<b>Post Project</b>	<b>DMA Runoff</b>	DMA Area x				
	, ,	<b>Surface Type</b>	Factor	<b>Runoff Factor</b>	IMP Sizing			
GRND-2	6,042	Concrete or	1.00	6,042	IMP Sizing	Rain	Minimum	Proposed
		Asphalt			Factor	Adjustment	Area or	Area or
			Total	6,042		Factor	Volume	Volume

1.000

242

\* NOTE: IMP3 PONDING DEPTH TO BE 12" (6" STANDARD). THEREBY

**IMP Name: IMP4 IMP Type: Bioretention Facility** = Soil Croup, IMD4

IMP Type: Bio Soil Group: IM		lity				HE VOLUMETRIC			
DMA Name	Area (sq ft)	Post Project Surface Type	DMA Runoff Factor	DMA Area x Runoff Factor	IMP Sizing				<u>, , , , , , , , , , , , , , , , , , , </u>
GRND-4	1,196	Concrete or Asphalt	1.00	1,196	IMP Sizing Factor	Rain Adjustment	Minimum Area or	Proposed Area or	
GRND-3	1,366	Concrete or Asphalt	1.00	1,366		Factor	Volume	Volume	
ROOF-1	736	Conventional Roof	1.00	736					
ROOF-2	246	Conventional Roof	1.00	246					
ROOF-3	834	Conventional Roof	1.00	834					
ROOF-4	489	Conventional Roof	1.00	489					
ROOF-5	561	Conventional Roof	1.00	561					
ROOF-12	1,278	Conventional	1.00	1,278					

8,643


Area

0.040

Report generated on 2/14/2022 12:00:00 AM by the Contra Costa Clean Water Program IMP Sizing Tool software (version 1.3.1.0).

Total

Conventional

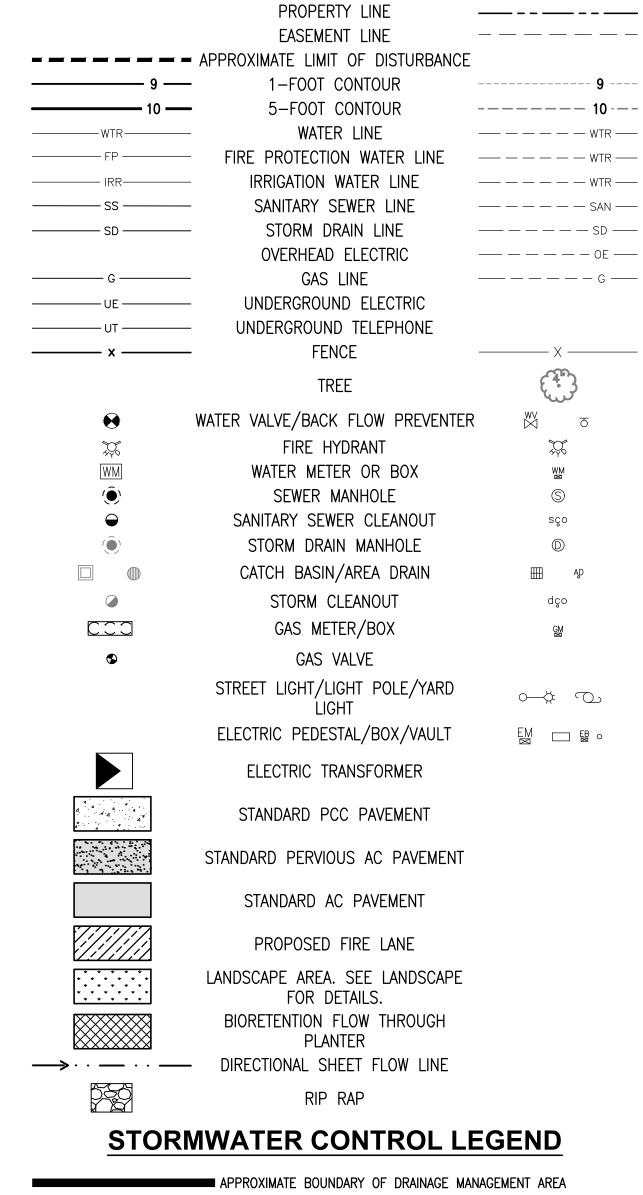


**LEGEND** 

**PROPOSED** 

PROPOSED OVERFLOW DRAIN1



APPROXIMATE BOUNDARY OF ROOF DRAINAGE MANAGEMENT AREA

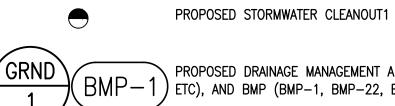

PROPOSED DRAINAGE MANAGEMENT AREA (ROOF-1, GROUND-2, (BMP-1) etc), and BMP (BMP-1, BMP-22, ETC) DESIGNATION



PROPOSED STORM DRAIN INLET STENCILING "NO DUMPING! DRAINS TO BAY" PER CITY SPECIFICATIONS



#### **ENGINEERS NOTE TO THE CONTRACTOR:**

THE EXISTENCE AND LOCATION OF ANY UNDERGROUND UTILITIES, PIPES AND/OR STRUCTURES SHOWN ON THESE PLANS WERE OBTAINED BY A SEARCH OF AVAILABLE RECORDS. TO THE BEST OF OUR KNOWLEDGE, THERE ARE NO EXISTING UTILITIES EXCEPT AS SHOWN ON THESE PLANS. THE CONTRACTOR SHALL ASCERTAIN THE TRUE VERTICAL AND HORIZONTAL LOCATION AND SIZE OF ANY UNDERGROUND UTILITIES AND SHALL BE RESPONSIBLE FOR DAMAGE TO PUBLIC OR PRIVATE UTILITIES SHOWN

CALL TWO WORKING DAYS BEFORE YOU DIG OR NOT SHOWN HEREON.



**EXISTING** 

**MASTER PLANNING** 

509 Ramona Avenue Albany, Ca 94706 -1431

T/F 510-525-9630 jcowee8@gmail.com www.architectural-concepts.ne

NOT FOR CONSTRUCTION

CONSULTANT



3240 PERALTA STREET, #3 OAKLAND, CA 9460 (510) 250-7877 WWW.CALICHI.COM

LANNING 2	22/03/15
LANNING ESUBMITTAL	19/10/08
CD	

19/08/22 SUBMITTAL REVISIONS JOB:

**DATE:** 2022/03/15

SHEET TITLE:

STORM WATER CONTROL PLAN

SHEET NO.

REVISION NO. 0

- REFER TO GENERAL NOTES SHEET "C-1' FOR ADDITIONAL INFORMATION
- REFER TO ELECTRICAL PLANS FOR LOCATIONS OF ALL SWITCHES, LIGHTS, RECEPTACLES, SMOKE DETECTORS, ETC.
- SMOKE DETECTORS SHALL BE PERMANENTLY WIRED AND SHALL BE EQUIPPED WITH 24 HOUR BATTERY
- DUCT PIERCING WALL BETWEEN HOUSE LIVING AREA AND GARAGE SHALL BE 26GA G.I. MATERIAL IN THE GARAGE, SEALED AT EDGES, AND NO OPENINGS INTO
- EMERGENCY ESCAPE/RESCUE. IT SHALL HAVE THE FOLLOWING:

  A. A MINIMUM NET CLEAR OPENING OF 5.7 SQ. FT.

  B. A. MINIMUM CLEAR OPENING HEIGHT OF 24
- B. A MINIMUM CLEAR OPENING HEIGHT OF 24 INCHES.
  C. A MINIMUM CLEAR OPENING WIDTH OF 20
- INCHES.

  D. A MAXIMUM FINISHED SILL HEIGHT OF 44
  INCHES.

  E. BARS, GRILLES OR GRATES SHALL HAVE

APPROVED RELEASE MECHANISMS (UBC 310.4)

- 6 EXTERIOR WALL EXTERIOR FACE: 7/8" 3-COAT STUCCO OVER TYVEK, ½ CDX PLYWOOD, 2X6 WOOD STUDS @ 16" O.C., R-22 HIGH DENSITY INSULATION, INTERIOR FACE: 5/8 GYP, BD, TAPE & TEXTURE LEVEL
- 7 INTERIOR WALLS 2X4 STUDS @ 16" O.C. WITH 5/8 GYP, BD, EACH SIDE. TAPE & TEXTURE LEVEL 5 FINISH. R-13 AT BATHROOM U.O.N.
- PLUMBING WALL 2X6 STUDS @ 16" O.C. WITH 5/8" WP. GYP. BD. ON WET SIDE AND 5/8 GYP. BD. ON DRY SIDE TAPE & TEXTURE LEVEL 5 FINISH. PROVIDE CEMENT BACKER BD AT TILE INSTALLATIONS R-19 BATT INSULATION AT BATHROOM.
- 9 FLOOR PLAN NOTES:
- THE FOLLOWING ARE PROVIDED IN EACH UNIT:
- 24" DEEP BASE CABINET WITH 36" HIGH COUNTERTOP AND SPLASH.
- 36" HIGH ISLAND CABINET WITH COUNTERTOP.
- 12 13" DEEP OVERHEAD CABINET.
- TWO COMPARTMENT SINK WITH GARBAGE DISPOSAL
   VERIFY DIMENSIONS IN MANUFACTURER'S
  SPECIFICATIONS.
- 30" SLIDE- IN RANGE/OVEN WITH MICROWAVE LIGHT AND EXHAUST FAN ABOVE (DUCT TO OUTSIDE AIR) VERIFY DIMENSIONS & REQUIRED CLEARANCES WITH MANUFACTUERE'S SPECIFICATIONS PRIOR TO FABRICATING CABINETS.
- 36" CLEAR REFRIGERATOR SPACE PROVIDE PLUMBING FOR ICEMAKER (RELEASED ON WALL).
- (16) 24" DEEP COUNTERTOP AND SPLASH.
- BUILT-IN PANTRY W/ SHELEVES.
- 32" X 60" ENAMELED STEEL TUB AND SHOWER WITH APPROVED FINISH (3) WALLS TO 80" ABOVE FLOOR PROVIDE CLEAR TEMPERED GLASS ENCLOSURE AND DOOR (DOOR SHALL HAVE INTEGRAL TOWER BAR) ALL SHOWER AND TUB/SHOWER COMBINATIONS ARE REQUIRED TO HAVE A THERMOSTATIC MIXING VALVE TYPE OR INDIVIDUAL CONTROL VALVES OF THE PRESSURE BALANCE TYPE PER (UPC 410.7).
  - WASHER SPACE PROVIDE PLUMBING CONNECTIONS (WASTE AND WATER) RECESSED WALL.

    DRYER SPACE- PROVIDE SMOOTH METAL DRYER VENT WITH BACKDRAFT DAMPER VENT TO OUTSIDE AIR
- DRYER SPACE- PROVIDE SMOOTH METAL DRYER VENT WITH BACKDRAFT DAMPER VENT TO OUTSIDE AIR. LENGTH OF CLOTHES DRYER VENT NOT TO EXCEED 14 FT. WITH MAXIMUM OF TWO 90 DEGREE TURNS. TERMINATION TO BE 4"-0" MINIMUM CLEAR FROM PROPERTY LINE.
- SHELF AND POLE.
- 21 SHELF AND DOUBLE POLE.
- PROVIDE (1) LAYER OF 5/8" TYPE "X" GYP. BD. AT ALL WALLS AND CEILING OF GARAGE.
- PROVIDE MECHANICAL VENTILATION THIS ROOM CAPABLE OF PROVIDING FIVE AIR CHANGES PER HOUR REFER TO ELCTRICAL DRAWINGS.
- GAS WATER HEATER ON 18" HIGH PLYWOOD PLATFORM PROVIDE SEISMIC STRAPS AT POINTS WITHIN THE UPPER AND LOWER ONE THIRD OF ITS VERTICAL DIMENSION. THE LOWER ANCHOR/STRAP LOCATED TO MAINTAIN A DISTANCE OF 4 INCHES ABOVE THE CONTROLS AND INSULATION PER TITLE -24 ENERGY CALCS- PROVIDE PRESSURE RELIEF VALVE WITH 1/2" COPPER DRAIN TO OUTSIDE. (PRIDE WATER HEATER VENT THROUGH ROOF) & 12"X12" LOUVER T&B.
- FORCED AIR UNIT IN ATTIC- PROVIDE LIGHT, SWITCH, 110V RECEPTABLE AND FUEL GAS PER CMC SEC 319. PROVIDE 22"X30" ATTIC ACCESS

REVISION DESCRIPTION BY DATE

EVELOPMENT, INC.
145 JOHN GLENN DRIVE
CONCORD, CA 94520
25) 246-2870 WWW.WCLANDS.COM

1

WINDHOVER PROJECT
MARTINEZ, CA 94553

FLOOR PLAN

DATE: 11-16-2021

DRAWN BY: RWW



LAN WINDHOVI
MARTINEZ


ECOND FLOOR F

DATE: 11-16-2021

SCALE: 3/16"=1'-0"

DRAWN BY: RWW


JOB:
Sheet

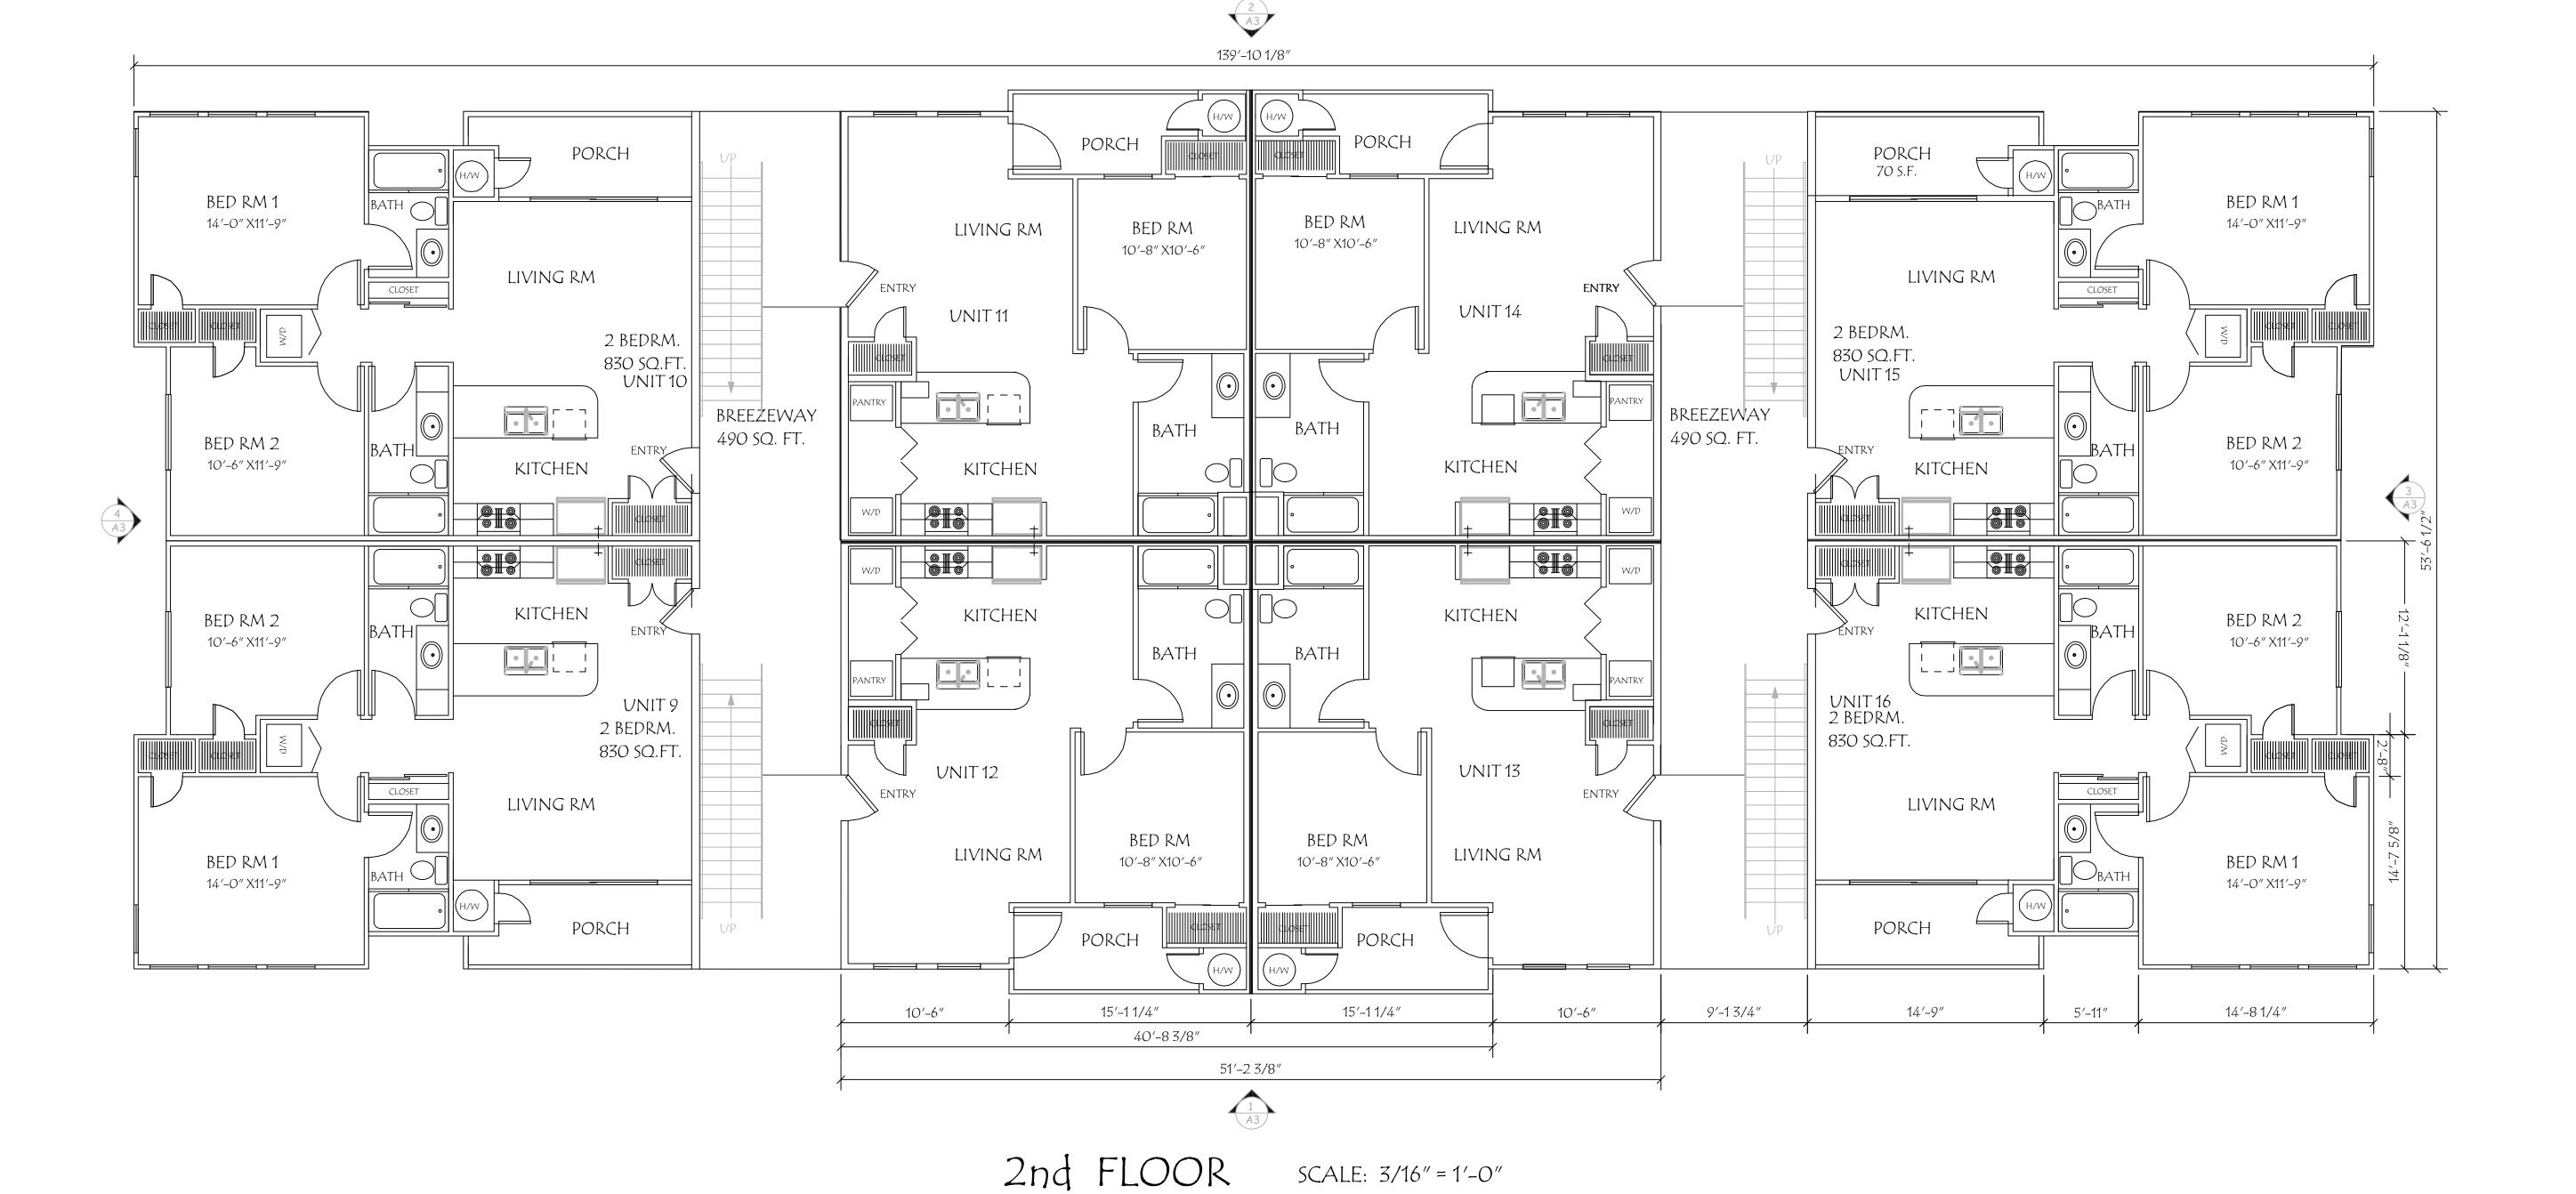



DATE: 11-16-2021

SCALE: 3/16"=1'-0" RAWN BY: RWW

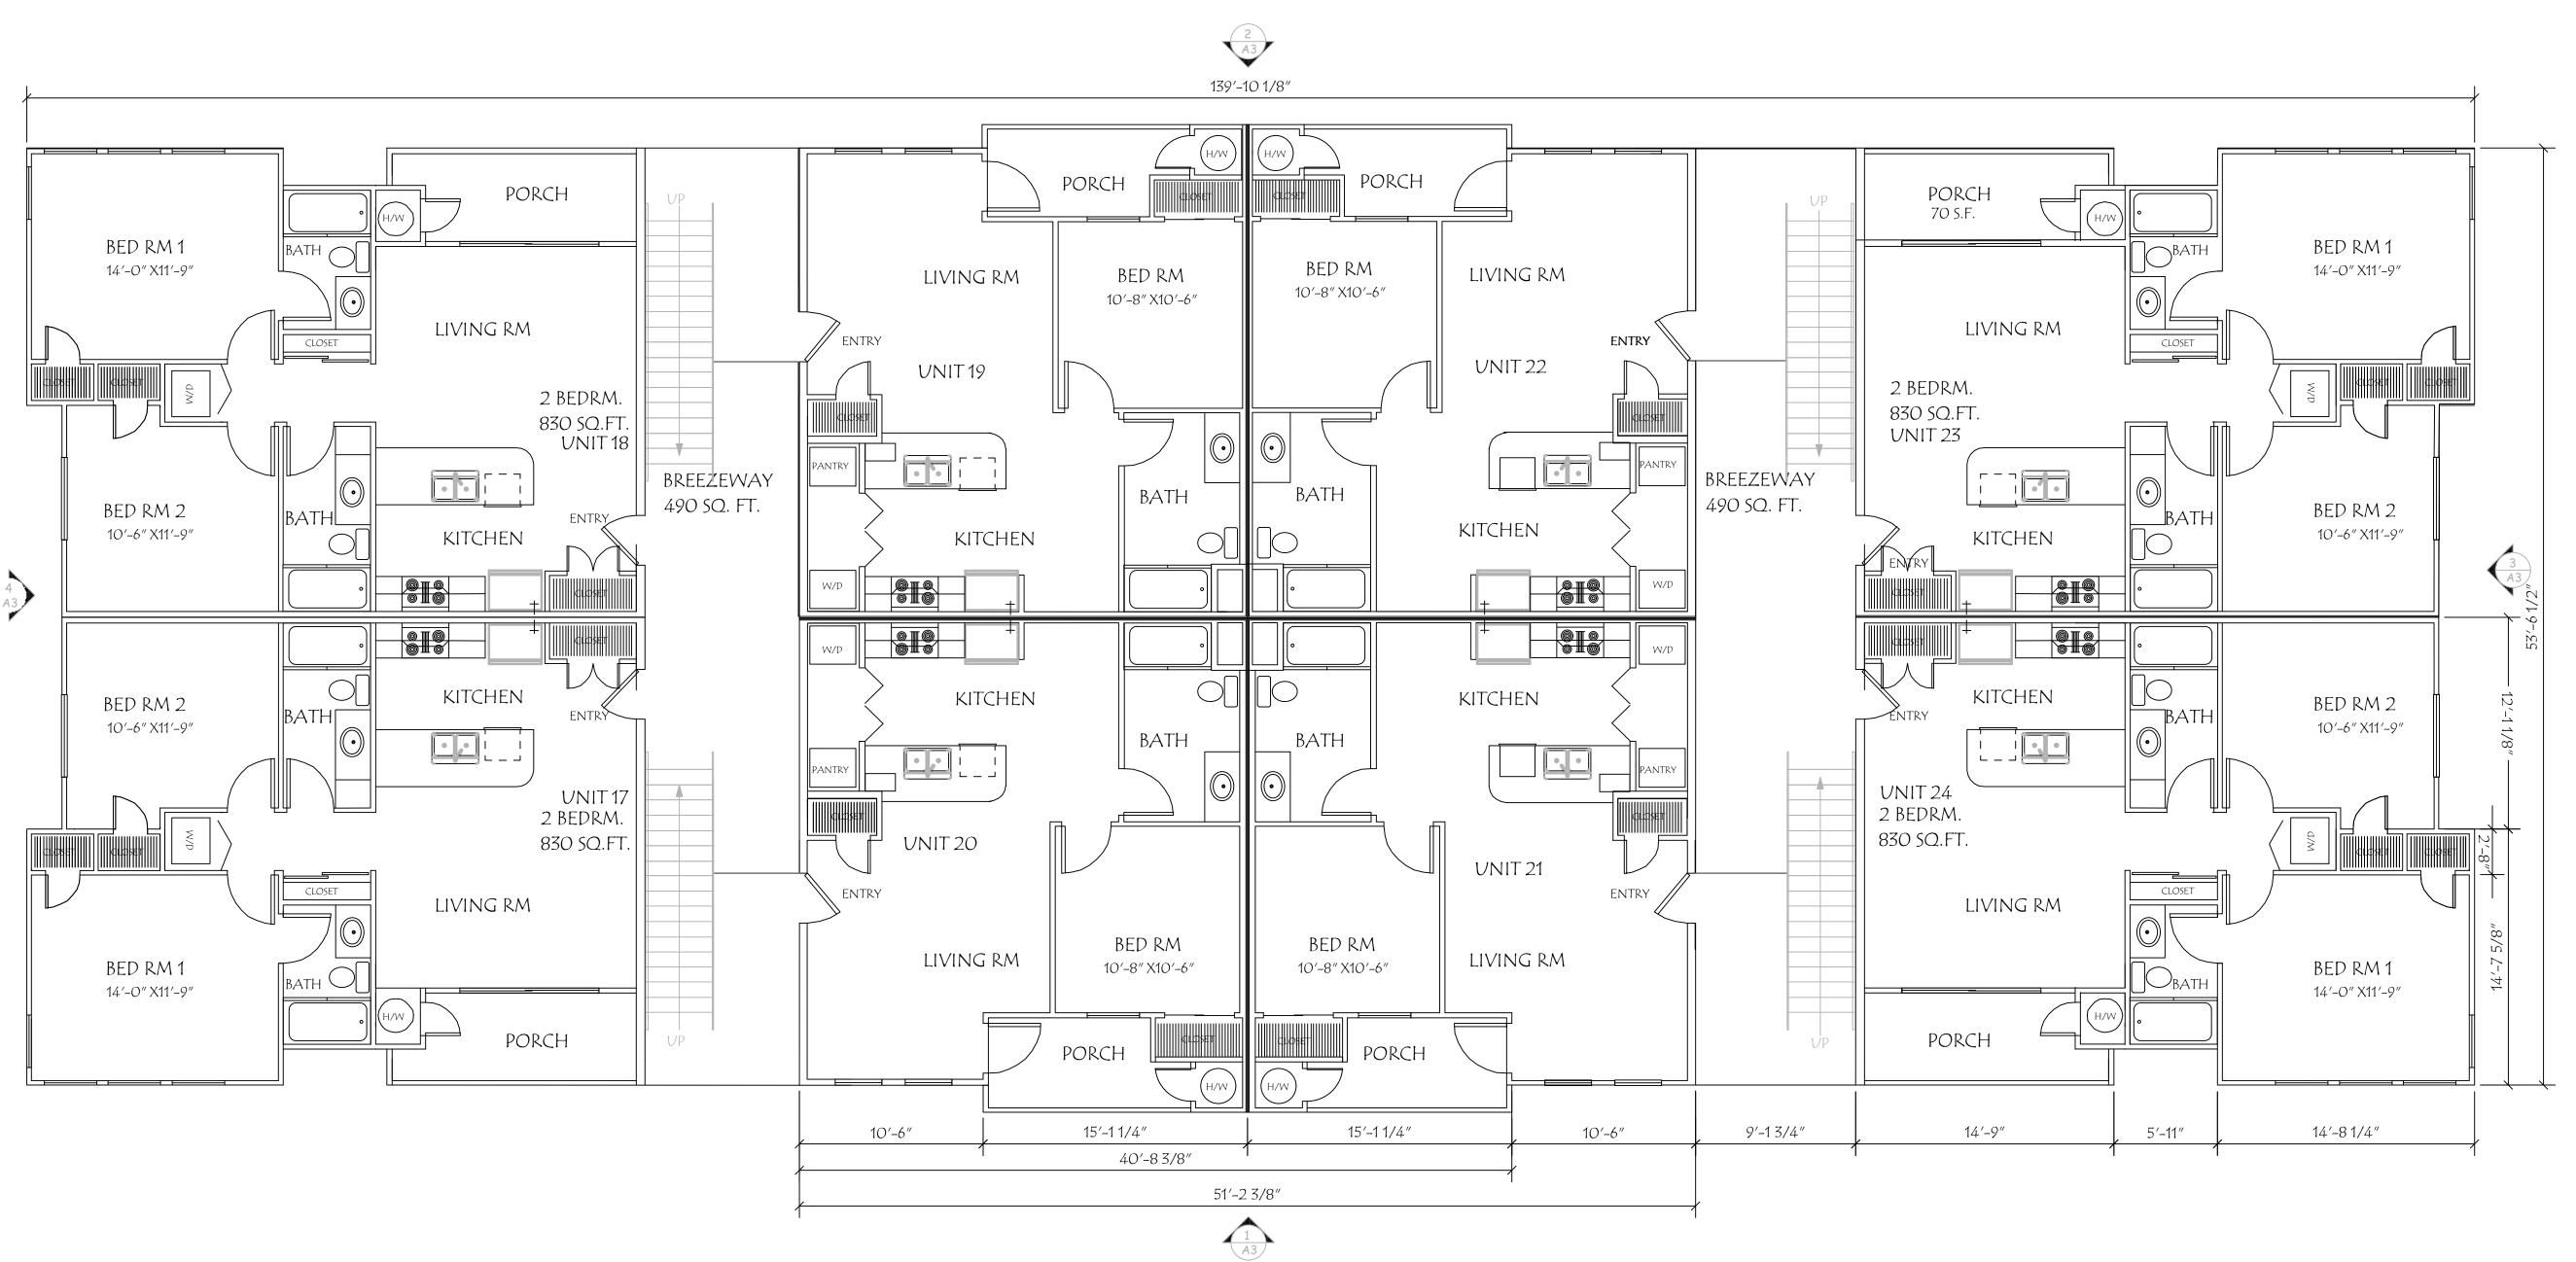

3rd FLOOR SCALE: 3/16" = 1'-0"



16'-2"

TRASH ENCLOSURE FRONT

6 COVERED PARKING CANOPY & TRASH ENCLOSURE SCALE 1/8" = 1'-0"

16'-2"

TRASH ENCLOSURE REAR (SIDE SIM.)

COVERED PARKING END

finish grade - see grading plan

42" HIGH WROUGHT IRON RAILING WITH CAP


SHEET NOTES

NOTE: \*STUD WALLS OVER 12 FT. HIGH TO HAVE STUDS SPACED AT 12" MAXIMUM OR STUD SIZE INCREASED TO 2X6. PROVIDE FIRE BLOCKING AT 10'-0" EACH DIRECTION MAXIMUM.

5 PARTY WALL

RAWN BY: RW

WINDHOVER PROJECT MARTINEZ, CA 94553

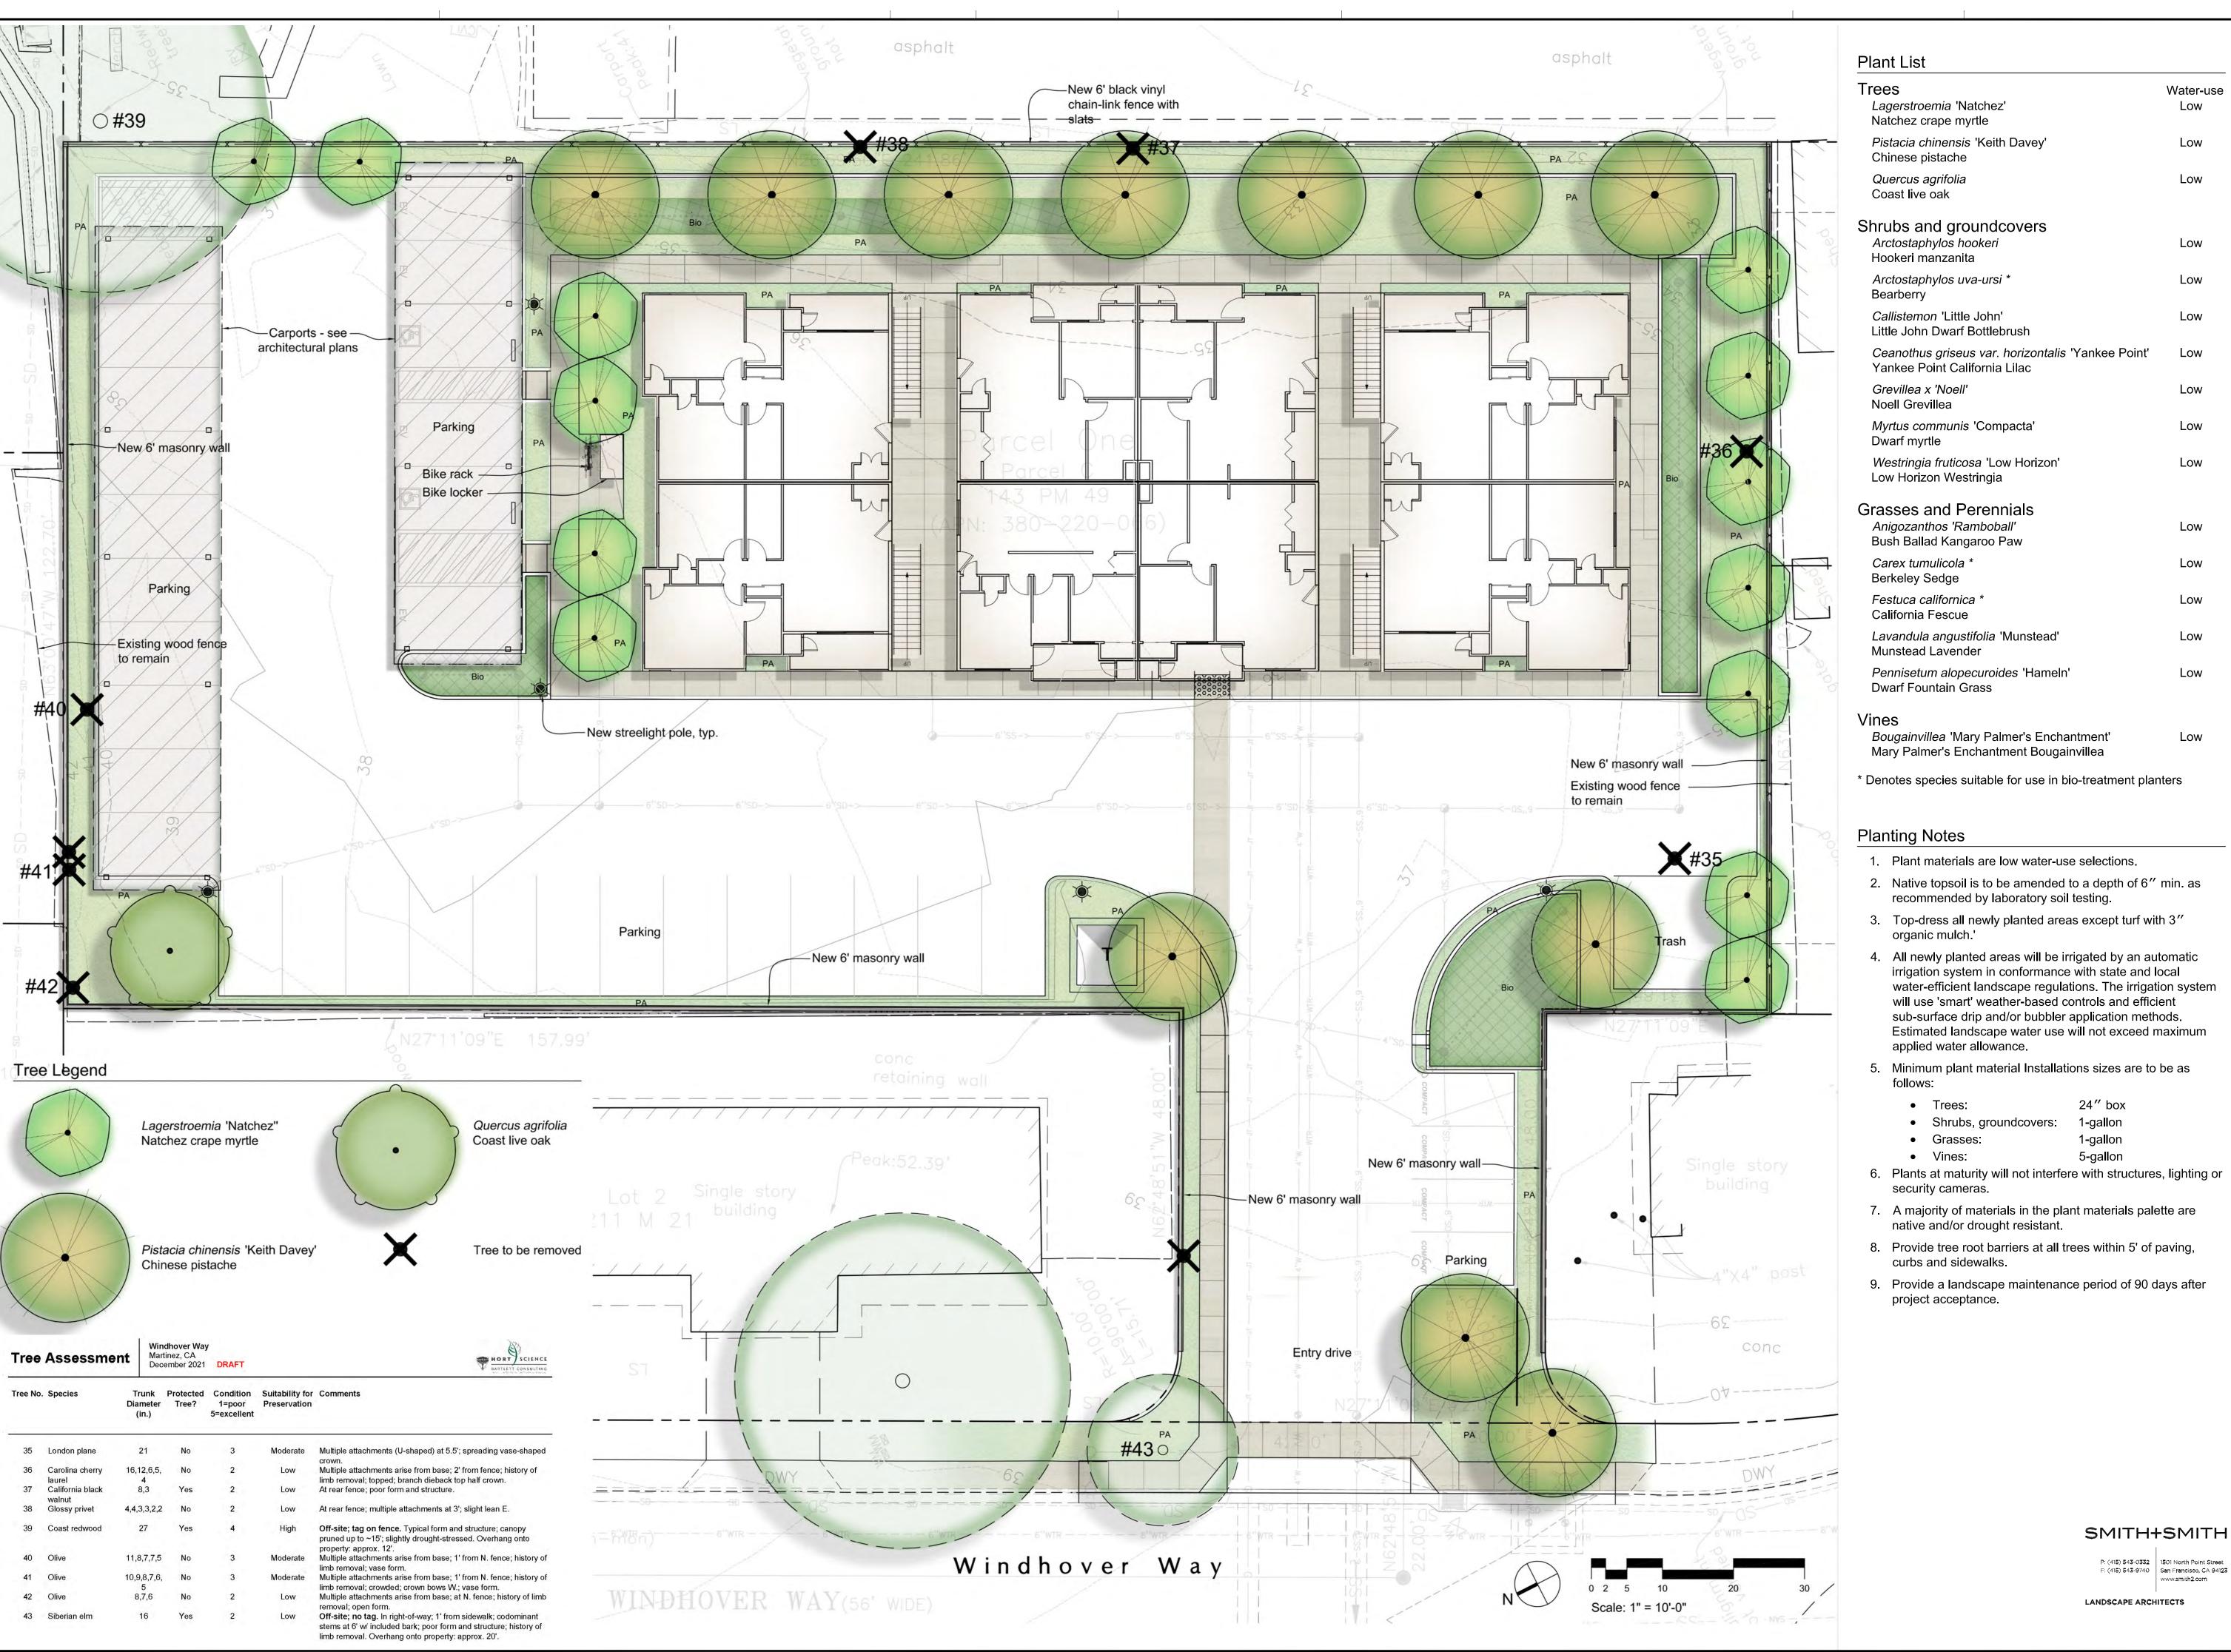

**ARCHITECTURAL** CONCEPTS ARCHITECTURE INTERIOR DESIGN

> **MASTER PLANNING** 509 Ramona Avenue Albany, Ca 94706 -1431 T/F 510-525-9630

jcowee8@gmail.com www.architectural-concepts.net

NOT FOR CONSTRUCTION

CONSULTANT:

CALICHI DESIGN GROUP 3240 PERALTA STREET, #3 OAKLAND, CA 9460

**CIVIL ENGINEERS** (510) 250-7877 WWW.CALICHI.COM

JDHOV APN: 380-MARTINE

(1)

water-efficient landscape regulations. The irrigation system

Estimated landscape water use will not exceed maximum

- 9. Provide a landscape maintenance period of 90 days after

DATE: 2022/03/14

Plan

PLANNING

SUBMITTAL

REVISIONS

JOB:

2022/03/14

SHEET TITLE: Landscape

SHEET NO.

\_\_1

REVISION NO. 0

### Shurbs and Groundcovers



Arctostaphylos hookeri Hookeri manzanita

Callistemon 'Little John'

Grevillea x 'Noell'

Noell Grevillea

Little John Dwarf Bottlebrush



Arctostaphylos uva-ursi Bearberry



Ceanothus griseus var. horizontalis 'Yankee Point'



Myrtus communis 'Compacta' Dwarf myrtle



Lagerstroemia 'Natchez' Natchez crape myrtle

Trees

Quercus agrifolia

Coast live oak



Pistacia chinensis 'Keith Davey' Chinese pistache



Westringia fruticosa 'Low Horizon' Low Horizon Westringia

## **Grasses and Perennials**



Carex tumulicola Berkeley Sedge




Pennisetum alopecuroides 'Hameln' Dwarf Fountain Grass

## Vines



Bougainvillea 'Mary Palmer's Enchantment' Mary Palmer's Enchantment Bougainvillea

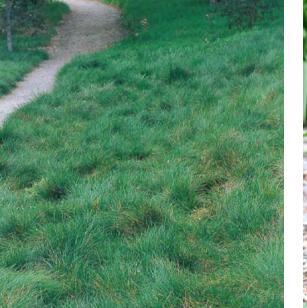


Festuca californica California Fescue




Anigozanthos 'Ramboball' Bush Ballad Kangaroo Paw



Lavandula angustifolia 'Munstead' Munstead Lavender

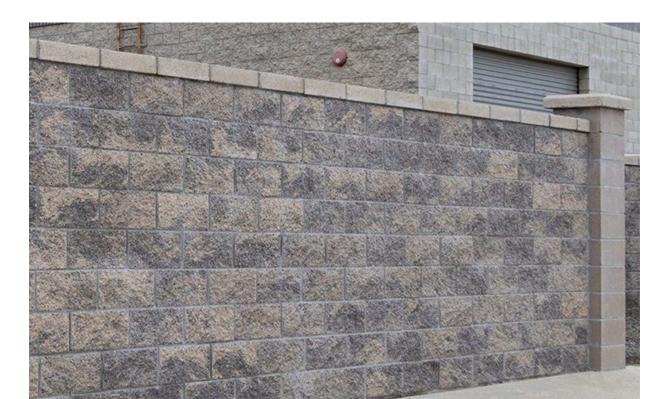

6' ht. masonry wall

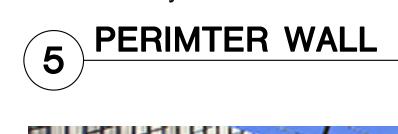




6' ht. black vinyl fence



## PERIMTER FENCE

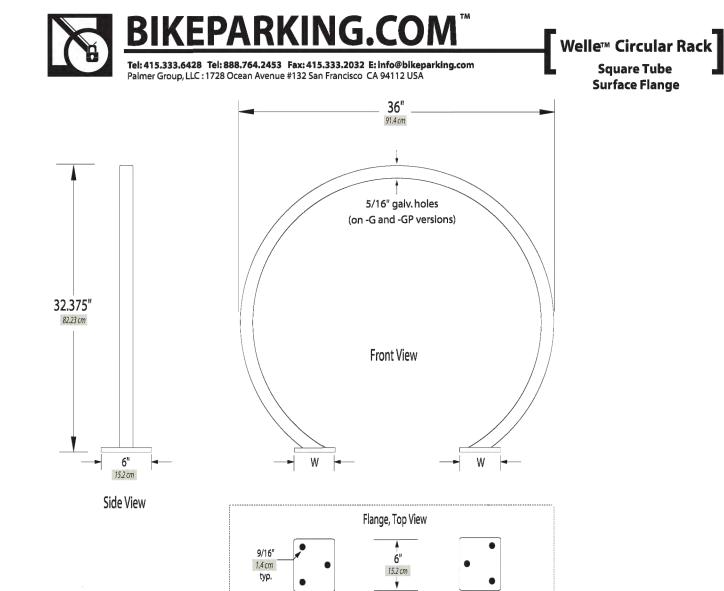

Welle <sup>™</sup> Circular Rack Square Tube Surface Flange							
Tubing	Model	Weight	Finish Options		Ноор	Surface Mount Flanges (Same material as Hoop)	Anchors (Not Provided)
Square Tube	WCR02-SQ-SF	38 lbs	<ul> <li>-G Hot Dipped Galvanized</li> <li>-P Powder Coated (color)</li> <li>-GP Hot Dipped Galvanized with Powder Coat (color) Top-Coat</li> <li>-SS Stainless #4 Brush Finish</li> </ul>	-G, -P, -GP -SS	2" x 2" x 0.188" Square Tube (Regular Steel) 12.7 cm 5.1 cm x 5.1 cm x 5 mm 2" x 2" x 0.188" Square Tube (304 SS Alloy) 5.1 cm x 5.1 cm x 5 mm	(2) 5" x 6" x 3/8" Plates, 12.7 cm x 15.2 cm x 10 mm each with (3) 9/16" Holes	(2) 1/2" x 2.75" 13 mm x 7 ci Rawl Spike (4) 1/2" x 3.75" 13 mm x 9.5 ci Wedge Anchor Bolt

© 2012 Palmer Group, LLC - - All Rights Reserved. Welle Square Tube Circular Rack

3 BIKE RACK







Lumec UrbanScape



2012.04.11

SMIT	H+S	MI	Tŀ

LANDSCAPE ARCHITECTS

REVISION NO. 0

CONCEPTS ARCHITECTURE **INTERIOR DESIGN MASTER PLANNING** 

509 Ramona Avenue Albany, Ca 94706 -1431 T/F 510-525-9630 jcowee8@gmail.com

NOT FOR

CONSTRUCTION

CALICHI DESIGN GROUP
CIVIL ENGINEERS

3240 PERALTA STREET, #3
OAKLAND, CA 9460
(510) 250-7877
WWW.CALICHI.COM


CONSULTANT:

PLANNING SUBMITTAL 2022/03/14 REVISIONS

DATE: 2022/03/14 SHEET TITLE:

Landscape Furniture & Planting Images

SHEET NO. L-2

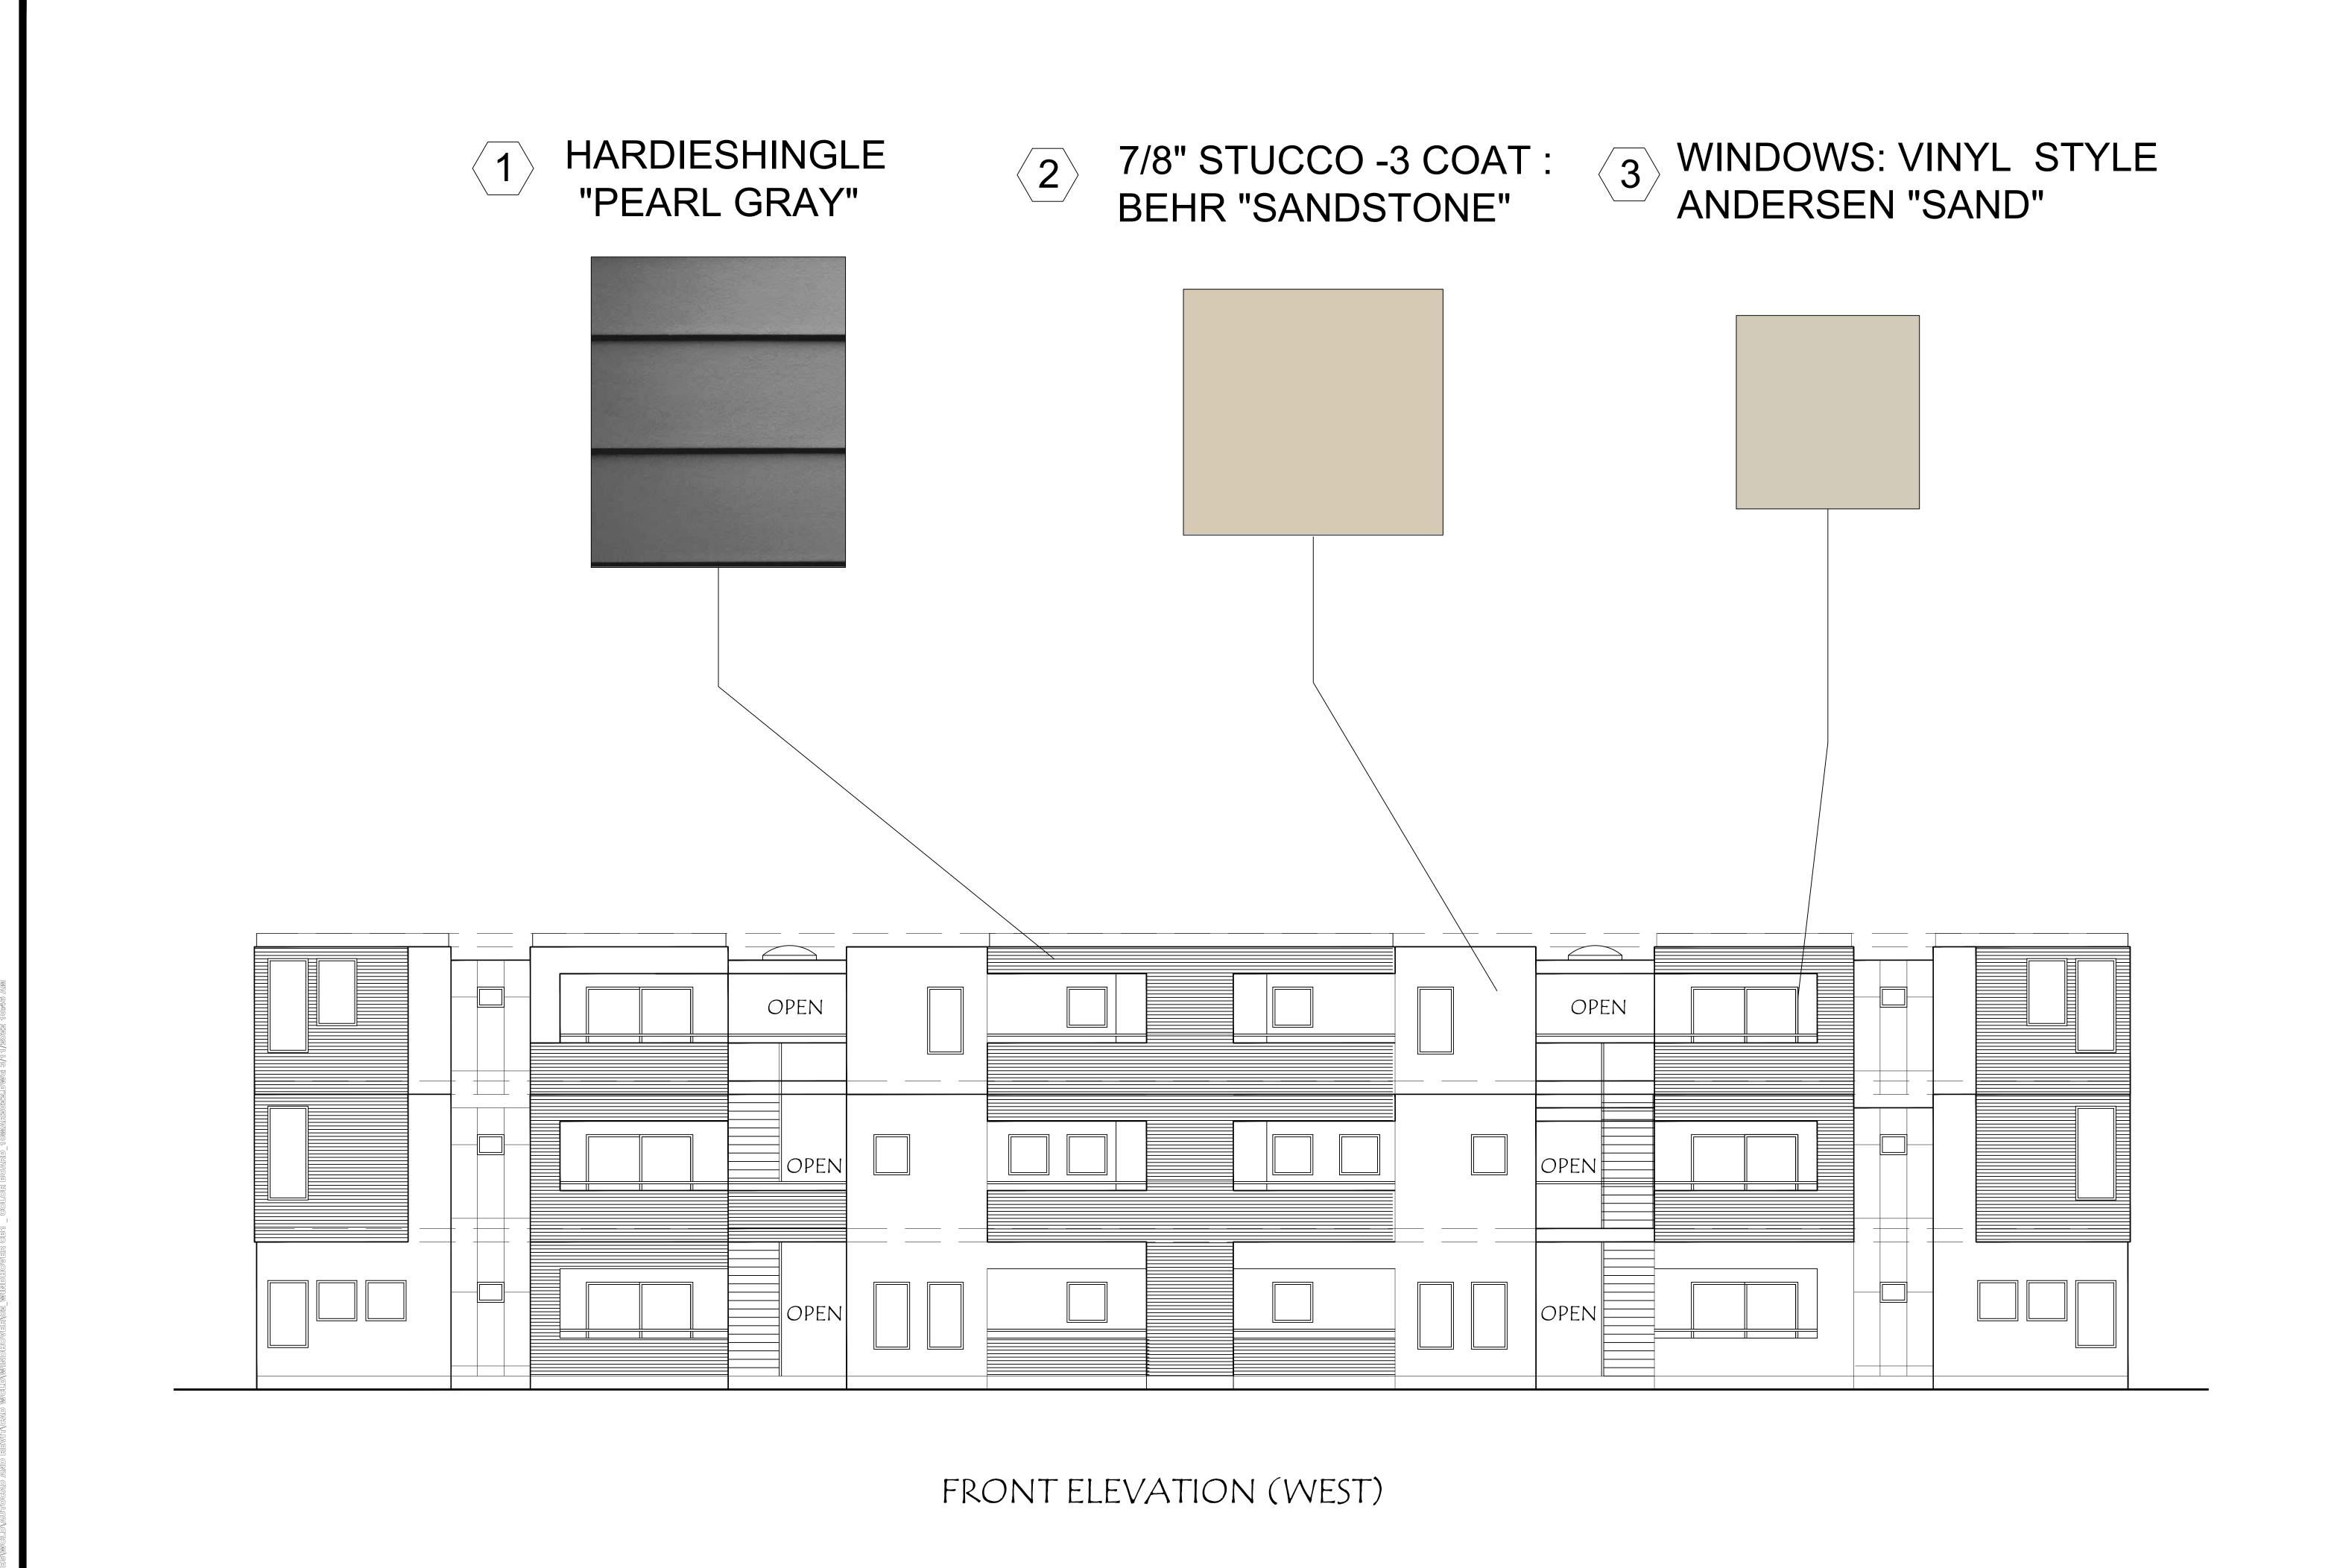

REVISION DESCRIPTION BY DATE

MEST COAST LAND A
DEVELOPMENT, INC
145 JOHN GLENN DRIVE
CONCORD, CA 94520
(925) 246-2870 www.wclands.com



JSTOM APARTMENTS FROJECT

©USTOM △PA WINDHOVER PROJECT MARTINEZ, CA 94553

COLOR BOARD

ATE 3-10-2022

SCALE NTS

Drawn By: PQF

Job Sheet

CB1