CONTRA COSTA COUNTY DEPARTMENT OF CONSERVATION AND DEVELOPMENT

COMMUNITY DEVELOPMENT DIVISION

30 Muir Road

Martinez, CA 94553-4601 Phone: 925-655-2700 Fax: 925-655-2758



AGENCY COMMENT REQUEST

Ve request your comments regarding the attached appl	Date 09/05/25
DISTRIBUTION INTERNAL ✓ Building Inspection Grading Inspection ✓ Advance Planning Housing Programs Trans. Planning Telecom Planner ✓ ALUC Staff ✓ HCP/NCCP Staff County Geologist HEALTH SERVICES DEPARTMENT	
 ✓ Environmental Health Hazardous Materials PUBLIC WORKS DEPARTMENT ✓ Engineering Services Special Districts	We have found the following special programs apply to this application: Landslide Active Fault Zone (A-P) Liquefaction Flood Hazard Area 60-dBA Noise Control CA EPA Hazardous Waste Site High or Very High FHSZ **** **** **** **** ***** **** ****
Reclamation District # East Bay Regional Park District Diablo/Discovery Bay/Crockett CSD ✓ MAC/TAC_Byron Improvement/Community Association ✓ CC Mosquito & Vector Control Dist (email) OTHERS/NON-LOCAL ✓ CHRIS (email only: nwic@sonoma.edu) ✓ CA Fish and Wildlife, Region 3 – Bay Delta Native American Tribes ADDITIONAL RECIPIENTS District 3 Delta Protection Commission/ Conservancy Board	Print Name Signature DATE Agency phone #



Planning Application Summary

County File Number: CDLP25-02033 File Date: 9/3/2025

Applicant:

John Milochik Hubbard Farming & Forestry LLC

PO BOX 2996 LIVERMORE, CA 94551

Property Owner:

FARMING & FORES HUBBARD PO BOX 2996

LIVERMORE, CA 94551 299

JMILOCHIK@YAHOO.COM (925) 575-4842

JMILOCHIK@YAHOO.COM (925) 575-4842

Project Description:

The applicant requests approval of a Land Use Permit for the construction and operation of the Hubard Farming & Forestry Clean Power Project, a 6.6 megawatt solar generation facility with a battery storage system. The solar farms will be ground mounted single axis tracker system. The project would use approximately 30-acres of land.

Project Location: (Address: 5675 HOPE WAY, BYRON, CA 94514), (APN: 002210021)

Additional APNs: 002-210-020

General Plan Designation(s): AL Zoning District(s): "A-3, -SG"

Flood Hazard Areas: See Map AP Fault Zone:


60-dBA Noise Control: MAC/TAC:

Sphere of Influence: Fire District: CONSOLIDATED FIRE Former ECC

Sanitary District: Housing Inventory Site: NO

Specific Plan:

Fees:				
Fee Item	Description	Account Code	Total Fee	Paid
048F	Fish & Wildlife Fee (\$75)	002606-9660-REV-000-5B048F	75.00	75.00
052B	Notification Fee (\$30)	002606-9660-REV-000-5B052B	30.00	30.00
HSDR	Environmental Health Fee (\$57)	002606-9660-REV-000-5BHSDR \$5.00	57.00	57.00
LPS0029	Land Use Permit-Other DCD	002606-9660-REV-000-5B0029	5500.00	5500.00
LPS0029P	Land Use Permit-Other PW	000651-9660-REV-000-6L0029	2000.00	2000.00
		Total:	7662.00	7662.00

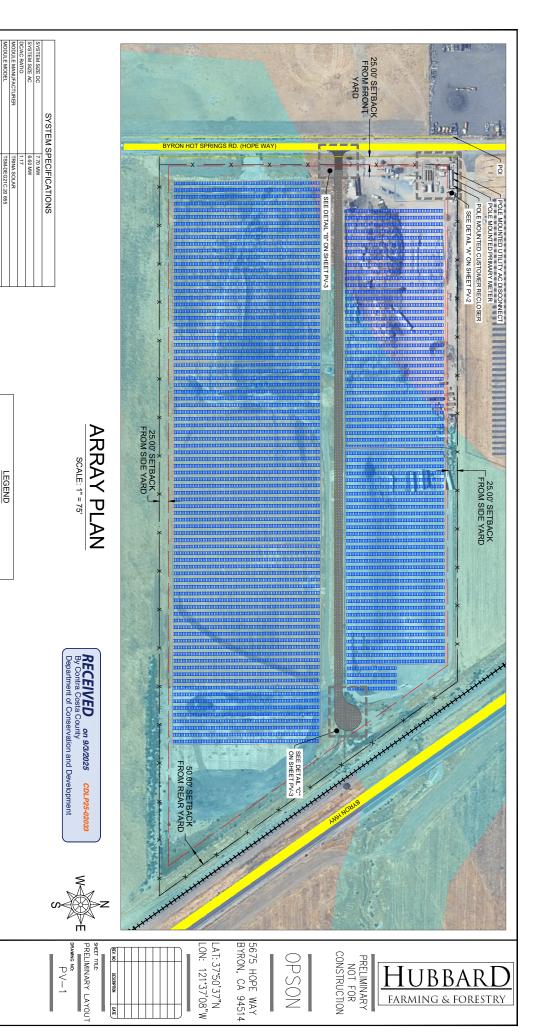

NTER-ROW SPACING PITCH

NEXTRACKER NX HORIZON XTR OR EQUAL

RAILWAY TRACK

DIMENSIONS TO PROPERTY LINES AND EXISTING FEATURES ARE APPROXIMATE PENDING SURVEY.

1"=75'

20' ACCESS ROADS SHALL BE DESIGNED TO ACCOMMODATE ALL CONSTRUCTION, OPERATIONS, MAINTENANCE, EMERGENCY VEHICLES, AND UTILITY TRAFFIC THROUGHOUT THE SITE.

EQUIPMENT SHALL BE LABELED PER NEC 690 AND UTILITY REGULATIONS. INSTALLATION TO COMPLY WITH NEC 2014 ARTICLE 690 AND ALL APPLICABLE LOCAL, STATE AND NATIONAL CODES.

DRAWN BY:

JRG

REVIEWED BY:

JRG 2025.08.17

REFER TO SINGLE LINE DIAGRAM FOR DETAILS.

GENERAL NOTES

PROJECT SITE SECURITY FENCE

PROPERTY LINE PUBLIC ROAD (E) FLOOD HAZARD AREA PROPOSEDHMA

SCH275KTL-DO/US-800

0505050

20' WIDE SITE ACCESS

TICH TRACKER - 50 MAX ANGLE


0.43

0.63

0.11E AREA INSIDE FENCE TRD

NEAR FEET OF GRAVEL ROAD

G POWERLIMITED BY PLANT CONTROLLER | NIA

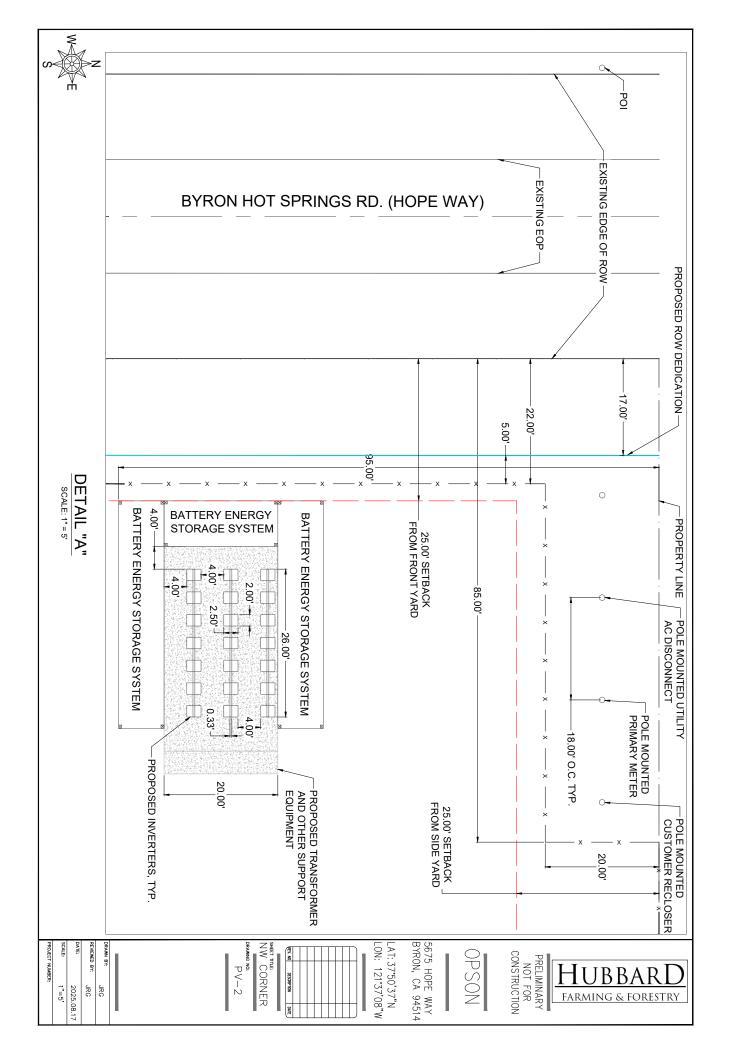

APPLICANT INTENDS TO PROVIDE SIGHT DISTANCE AT THE ON-SITE DRIVEWAYS AND BYRON HOT SPRINGS ROAD FOR A DESIGN SPEED OF 35 MILES PER HOUR. THE APPLICANT WILL TRIM VEGETATION, AS NECESSARY, TO PROVIDE SIGHT DISTANCE AT THE DRIVEWAY. ANY NEW FENCING AT THE DRIVEWAYS WILL BE SETBACK TO ENSURE THAT THE SIGHT LINES ARE CLEAR. APPLICANT INTENDS TO LOCATE THE VEHICULAR ENTRANCE GATE A MINIMUM OF 40 FEET FROM THE EDGE OF PAVEMENT TO ALLOW VEHICLES TO QUEUE WITHOUT OBSTRUCTING THROUGH TRAFFIC. SUFFICIENT AREA WILL BE PROVIDED OUTSIDE ANY GATE TO ALLOW A VEHICLE TO TURNAROUND AND RE-ENTER BYRON HOT SPRINGS ROAD IN A FORWARD DIRECTION. APPLICANT INTENDS TO PAVE THE FIRST 50 FEET OF THE ACCESS DRIVEWAY, MEASURED FROM THE EXISTING EDGE OF PAVEMENT OF BYRON HOT SPRINGS ROAD INTO THE PROPERTY, TO ALLOW VEHICLES TO PULL COMPLETELY OFF OF THE ROADWAY AND STILL REMAIN ON A PAVED SURFACE, AND TO PREVENT DUST, GRAVEL, AND DEBRIS FROM SPILLING ON TO BYRON HOT SPRINGS ROAD APPLICANT INTENDS TO CONSTRUCT A STREET TYPE CONNECTION WITH 20-FOOT RADII RETURNS IN LIEU OF STANDARD DRIVEWAY DEPRESSIONS AT BYRON HOT SPRINGS ROAD. EOP EXISTING EXISTING CL ROW DETAIL "B" R20.00' TYP. SCALE: 1" = 10' -50.00'--17.00'-EXISTING EDGE OF ROW PROPOSED ROW DEDICATION PROPOSED GATE 20.00'-10.00' R35.00'-000000 SETBACK 20 WIDE SITE ACCESS PROJECT SITE SECURITY FENCE PROPERTY LINE PROPOSED HMA **DETAIL** "C" LEGEND SCALE: 1" = 10' REFER TO SINGLE LINE DIAGRAM FOR DETAILS. 4. 20' ACCESS ROADS SHALL BE DESIGNED TO ACCOMMODATE ALL CONSTRUCTION, OPERATIONS, MAINTENANCE, EMERGENCY VEHICLES, AND UTILITY TRAFFIC THROUGHOUT THE SITE. EQUIPMENT SHALL BE LABELED PER NEC 690 AND UTILITY REGULATIONS. DIMENSIONS TO PROPERTY LINES AND EXISTING FEATURES ARE APPROXIMATE PENDING SURVEY. INSTALLATION TO COMPLY WITH NEC 2014 ARTICLE 690 AND ALL APPLICABLE LOCAL, STATE AND NATIONAL CODES. -R35.00' GENERAL NOTES 25,00' 5675 HOPE WAY BYRON, CA 94514 VEHICLE CIRCULATION PLAN PROJECT NUMBER: REVIEWED BY: DRAWN BY: LON: 121°37'08"W LAT: 37°50'37"N HEET TITLES NOT FOR CONSTRUCTION OPSON PRELIMINARY PV-3 **JBBA** 1"=10' JRG 2025.08.17 JRG FARMING & FORESTRY





ITEM
FENCING (SOFT)
FENCING (ACRES)
GRAVEL AREA (SOFT)
TOTAL ANTICIPALED PRE-PROJECT
MPERVIOUS (SOFT)
TOTAL ANTICIPALED PRE-PROJECT
MPERVIOUS (% OF PROJECT)

VALUE 435,600 10 415,600 1,306,800

EASTWARD 0.4%<1.3%

0.055 720 EXISTING CONDITIONS

ELEVATION DATA SOURCE:
 I.1. TITLE: MATIONAL ELEVATION DATA 3-METER
 I.2. ORGINATOR: USDA / NRCS
 NATIONAL GEOSPATIAL CENTER FOR EXCELLENCE


DRAWING NO: C-1


DRAWN BY: REVIEWED BY:

2025.08.17 1"=75' JRG JRG SHEET TITLE:
DRAINAGE PLAN
EXISTING



5675 HOPE WAY BYRON, CA 94514 PRELIMINARY
NOT FOR
CONSTRUCTION OPSON <u>HubbarD</u> FARMING & FORESTRY

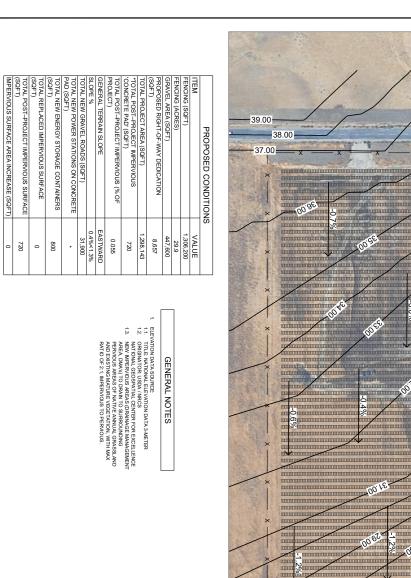

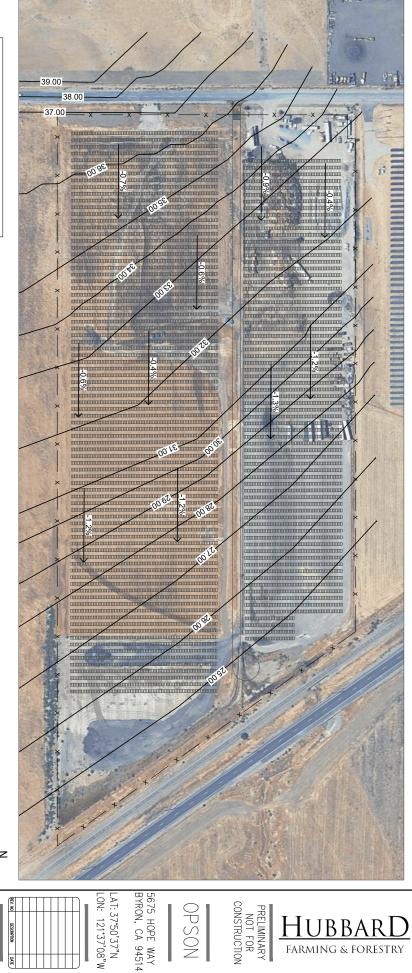



C-2	DRAWING NO:	DRAINAGE & GRADING PL PROPOSED
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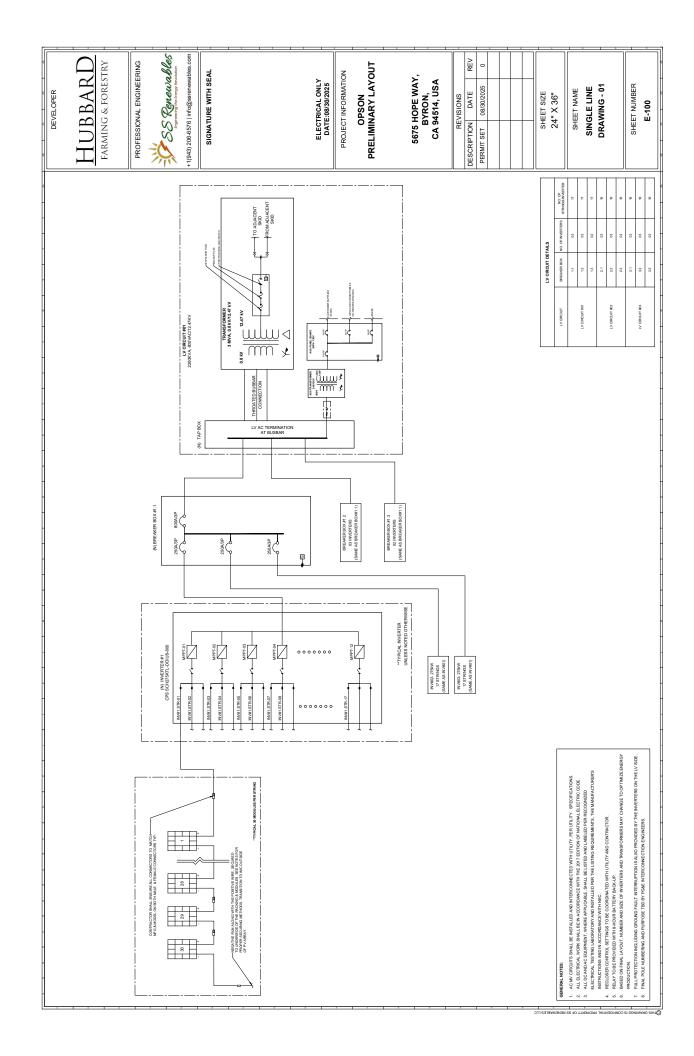
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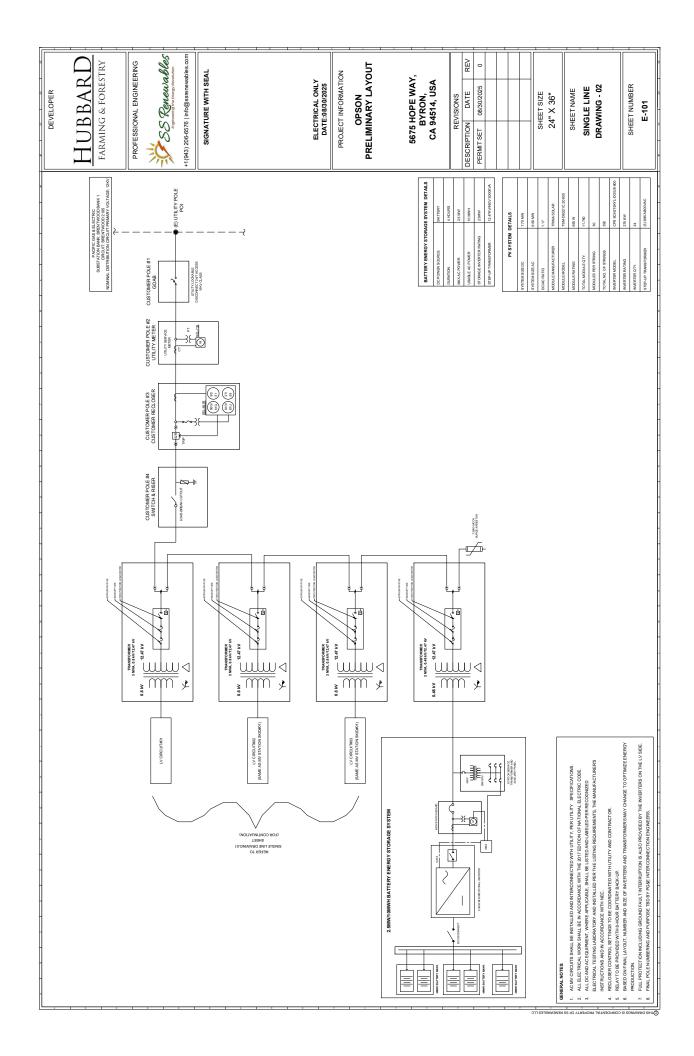
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PRELIMINARY
NOT FOR
CONSTRUCTION


<u> Hubbarl</u> FARMING & FORESTRY


DRAWN BY:	JRG
REVIEWED BY:	JRG
DATE:	2025.08.17
SCALE:	1"=75'
PROJECT NUMBER:	









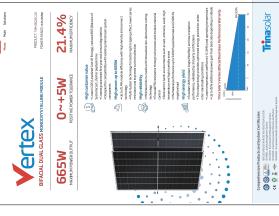

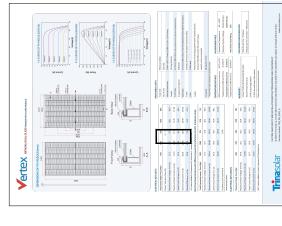

INVERTER SPECIFICATION

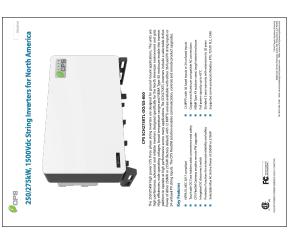

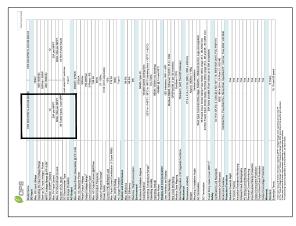

DEVELOPER	HUBBARD FARMING & FORESTRY	
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SS Renewables -1(943) 206-6576 | info@ssrenewables.com PROFESSIONAL ENGINEERING

SIGNATURE WITH SEAL

ELECTRICAL ONLY DATE:08/30/2025

PROJECT INFORMATION

OPSON PRELIMINARY LAYOUT

5675 HOPE WAY, BYRON, CA 94514, USA

RE	REVISIONS	
DESCRIPTION	DATE	REV
PERMIT SET	08/30/2025	0

SHEET SIZE 24" X 36"

DATA SPECIFICATIONS SHEET NAME

SHEET NUMBER

E-102


5675 Hope Way_Aerial



Map Legend Parcels Assessment

Spatial Reference PCS: WGS 1984 Web Mercator Auxiliary Sphere Datum: WGS 1984


Credits: Esri Community Maps Contributors, California State Parks, © OpenStreetMap, Microsoft, Esri, TomTom, Garmin, SafeGraph, GeoTechnologies, Inc, MET/NASA, USGS, Bureau of Land Management, EPA, NPS, US Census Bureau, USDA, USFWS, Maxar

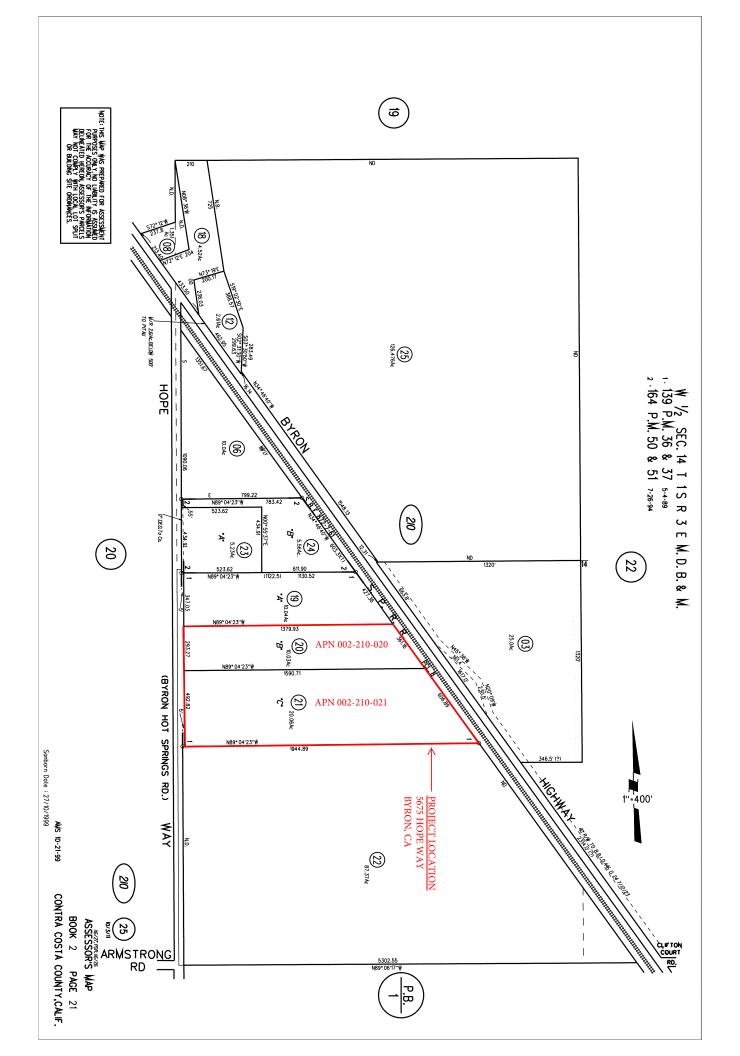

National Flood Hazard Layer FIRMette


121°37'33"W 37°50'50"N



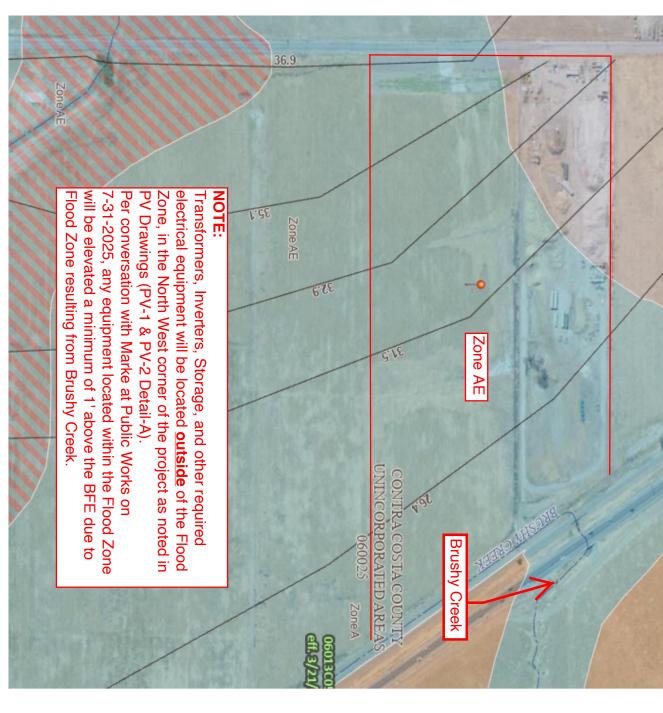

Legend

SEE FIS REPORT FOR DETAILED LEGEND AND INDEX MAP FOR FIRM PANEL LAYOUT

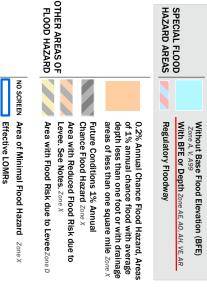

OTHER AREAS


Area of Undetermined Flood Hazard Zone D


GENERAL

---- Channel, Culvert, or Storm Sewer

STRUCTURES

1111111 Levee, Dike, or Floodwall

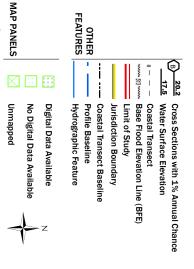

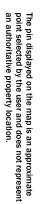

This map complies with FEMA's standards for the use of digital flood maps if it is not void as described below. The basemap shown complies with FEMA's basemap accuracy standards

accuracy standards

The flood hazard information is derived directly from the authoritative NFHL web services provided by FEMA. This map was exported on 8/30/2025 at 5:47 PM and does not reflect changes or amendments subsequent to this date and time. The NFHL and effective information may change or become superseded by new data over time.

This map image is void if the one or more of the following map elements do not appear: basemap imagery, flood zone labels, legend, scale bar, map creation date, community identifiers, FIRM panel number, and FIRM effective date. Map images for unmapped and unmodernized areas cannot be used for regulatory purposes.

250


Basemap Imagery Source: USGS National Map 2023

121°36'55"W 37°50'21"N

0.02 0.04 Unincorporated 0.08 mi **Byron Hot Springs Rd** Byron H A District 3 BYRON, CA 5675 HOPE WAY **PROJECT** LOCATION & MAH HOME 2 Hay Rd KMH UOJKE This map is a user generated static output from an internet mapping application and is intended for reference use only. Data layers that appear on this map may or may not be accurate, current, or otherwise reliable. THIS MAP IS NOTIOT DB USED FOR NAVIGATION. CCMap is maintained by Contra Costa County Compartment of information Technology, County GIS. Data layers contained within the CCMap application are provided by wastics. Contra Costa County Departments. Please direct all data inquires to the appropriate department. Spatial Reference PCS: WGS 1984 Web Mercator Auxiliary Sphere Datum: WGS 1984 General Plan (DCD) Planning Layers Map Legend Supervisors County Border Assessment Parcels AL (Agricultural Lands) (1 du/10 Districts Unincorporated Semi-Public) in DPZ) ac) (1 du/20 ac PS (Public and Board of

5675 Hope Way_ General Plan

Credits: Contra Costa County Development of Conservation and Department, Esri Community Maps Contributors, California State Parks, © OpenStreetMap, Microsoft, Esri, TomTom, Garmin, SafeGraph, GeoTechnologies, Inc, METI/NASA, USGS, Bureau of Land Management, EPA, NPS, US Census Bureau, USTA, USCS, Bureau of Land Management, EPA, NPS, US Census Bureau, USTA, USCS, Bureau of Land Management, EPA, NPS, US Census Bureau, USTA, USCS, Bureau of Land Management, EPA, NPS, USCS, Bureau of Land Manageme

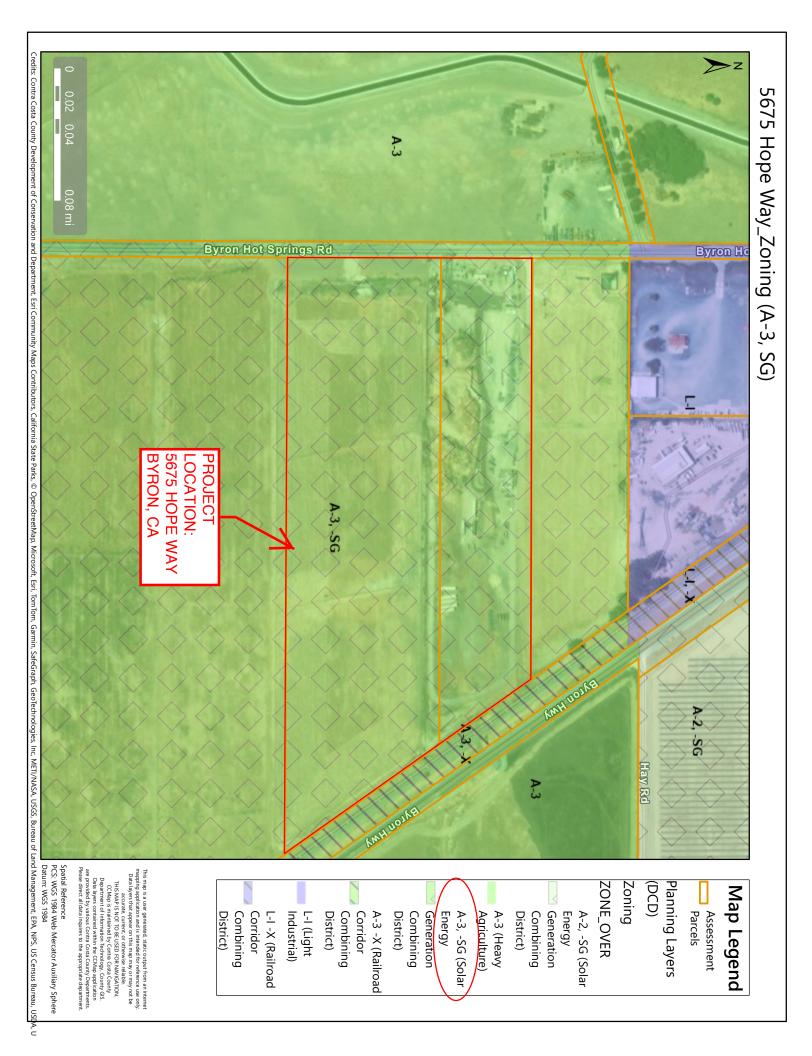



Hubbard Farming & Forestry, LLC

PO Box 2996

Livermore, CA 94551

August 30th, 2025

Contra Costa County
Department of Conservation and Development
30 Muir Rd.
Martinez, CA 94553

RE: OPSON SOLAR PROJECT- PROJECT NARRITIVE EXHIBIT TO LAND USE APPLICATION

Dear Department of Conservation and Development,

Hubbard Farming & Forestry (Owner and Applicant) has proudly been part of the Byron community since 2007, and is seeking approval of a small-scale utility solar energy generating project on approximately 30-acres of land in Byron, CA. The physical addresses are **5675 Hope Way** (AKA Byron Hot Springs Road) **APN 002-210-021** and **5595 Hope Way** (AKA Byron Hot Springs Road) **APN 002-210-020**. The property is zoned A-3 with Solar Energy Generation Combining District ("SG") and is located within the Agricultural Lands (AL) General Plan land use designation.

As currently designed, the project will generate a total of 6.6 megawatts (MW/AC) of reliable clean energy for our community as we interconnect to PG&E's existing distribution feeder system located on the property. The power that is generated and stored from this project will be sold to a buyer through a Power Purchase Agreement ("PPA").

The single axis tracking system will rotate the approximate 11,760 modules to track the sun's solar energy throughout the day. The approximate 24 inverters will then convert that energy into A/C current, dispatching it to California's grid which has publicly announced a commitment to achieve 90% clean electricity by 2035 and 100% by 2045 (as mandated by Senate Bill 100). The portion of electricity that is stored during the day will be dispatched in the evening providing grid reliability, stability, peak load management, and enhances local energy security to our community.

Flood Zone:

The inverters, transformers, battery storage, and other required equipment will be located <u>outside</u> of the Flood Zone as described in the attached exhibits. The existing drainage pattern will be maintained.

Drainage Pattern:

An exception from Collect and Convey requirements is requested due to the favorable existing drainage pattern.

CEQA:

After careful review of similar project staff reports we anticipate a Negative Declaration or a Mitigated Negative Declaration.

TRAFFIC:

The property will be unmanned and will not require regular staff for daily operation.

WATER:

A significant decrease in water use is anticipated due to ceasing crop irrigation and dust suppression at the project location.

SANITARY SEWER:

The property will be unmanned and a sewage system will not be required.

FIRE PROTECTION:

No change in land use (e.g., chemical storage, explosives) or structural improvements are planned for this project. The existing combustible stockpiles of material, e.g., compost, recycled wood piles, etc. from the current tenant will be removed.

EXISTING INVENTORY & EQUIPMENT ON-SITE:

The current tenant business operating on the property will be re-locating, and will remove their inventory, equipment, etc.

Thank you for this opportunity, we look forward to working along-side the County through the application review and approval process.

Sincerely,

Hubbard Farming & Forestry, LLC