CONTRA COSTA COUNTY DEPARTMENT OF CONSERVATION AND DEVELOPMENT

COMMUNITY DEVELOPMENT DIVISION

30 Muir Road

Martinez, CA 94553-4601 Phone: 925-655-2700 Fax: 925-655-2758



AGENCY COMMENT REQUEST

Date___3/6/2024

Ve request your comments regarding the attached application	cation currently under review.
DISTRIBUTION	Please submit your comments to:
INTERNAL	Project Planner Dominique Vogelpohl
✔ Building Inspection Grading Inspection	Phone #925-655-2880
Advance Planning Housing Programs	E-mail_dominique.vogelpohl@dcd.cccounty.u
Trans. Planning Telecom Planner	County File # CDDP24-03008
ALUC Staff ✓ HCP/NCCP Staff	,
APC PW Staff County Geologist	Prior toApril 3, 2024
HEALTH SERVICES DEPARTMENT	* * * *
✔ Environmental Health Hazardous Materials	We have found the following special programs apply to this application:
PUBLIC WORKS DEPARTMENT	
Engineering Services (1 Full-size + 3 email Contacts)	Active Fault Zone (Alquist-Priolo)
Traffic	Flood Hazard Area, Panel #
Flood Control (Full-size) Special Districts	✓ 60-dBA Noise Control ✓ 50-dBA Noise Control ✓ 50-dBA Noise Control ✓ 60-dBA Noi
LOCAL	CA EPA Hazardous Waste Site
✓ Fire District	High or Very High FHSZ
San Ramon Valley – (email) rwendel@srvfire.ca.gov Consolidated – (email) fire@cccfpd.org East CCC – (email) brodriguez@eccfpd.org Sanitary District	* * * * * AGENCIES: Please indicate the applicable code section for any recommendation required by law or ordinance. Please send copies of your response to the Applicant and Owner.
✓ Water District Diablo Water	Comments: None Below Attached
City of	Tone Below / Addoned
School District(s)	
LAFCO	
Reclamation District #	
East Bay Regional Park District	
Diablo/Discovery Bay/Crockett CSD	
✓ MAC/TAC Knightsen TAC	
Improvement/Community Association	
✓ CC Mosquito & Vector Control Dist (email)	
OTHERS/NON-LOCAL	
CHRIS (email only: nwic@sonoma.edu)	
CA Fish and Wildlife, Region 3 – Bay Delta	Print Name
Native American Tribes	
ADDITIONAL RECIPIENTS	Signature DATE
Delta Protection Committee; Delta Stewardship Council	Agency phone #



Planning Application Summary

County File Number: CDDP24-03008 File Date: 3/5/2024

Applicant:

Debra Fromme choicepps@yahoo.com Choice Plans and Permit Services (925) 783-1858

1021 Vineyard Drive Oakley, CA 94561

Property Owner:

ROBERT CORT cortproperty@gmail.com

757 3RD AVE (415) 573-7443

SAN FRANCISCO, CA 941183908

Project Description:

The applicant requests approval of a Development Plan with a Variance to allow a 6.5-foot setback (where 10 feet is required) for the conversion of an existing, approximately 542 square-foot detached dwelling unit building into a storage building. Interior and exterior improvements include foundation repair/replacement, roof change from pitched to flat, increase height to 13 feet to match main building, and new doors/windows.

Project Location: (Address: 3011 KNIGHTSEN AVE, KNIGHTSEN, CA 945480328), (APN:

020073008)

Additional APNs:

General Plan Designation(s): CO Zoning District(s): "R-B, -CE"

Flood Hazard Areas: X

AP Fault Zone: Liquefaction


60-dBA Noise Control: Yes


MAC/TAC: Knightsen TAC


Sphere of Influence: None Fire District: CONSOLIDATED FIRE Former ECC

Sanitary District: None Housing Inventory Site: No

Fees:				
Fee Item	Description	Account Code	Total Fee	Paid
048F	Fish & Wildlife Fee (\$75)	002606-9660-REV-000-5B048F	75.00	75.00
052B	Notification Fee (\$30)	002606-9660-REV-000-5B052B	30.00	30.00
DP016A	Dev Plan Minor Modification (Administrative)	002606-9660-REV-000-5B016A	1500.00	1500.00
HSDR	Environmental Health Fee (\$57)	002606-9660-REV-000-5BHSDR \$5.00	57.00	57.00
		Total:	1662.00	1662.00

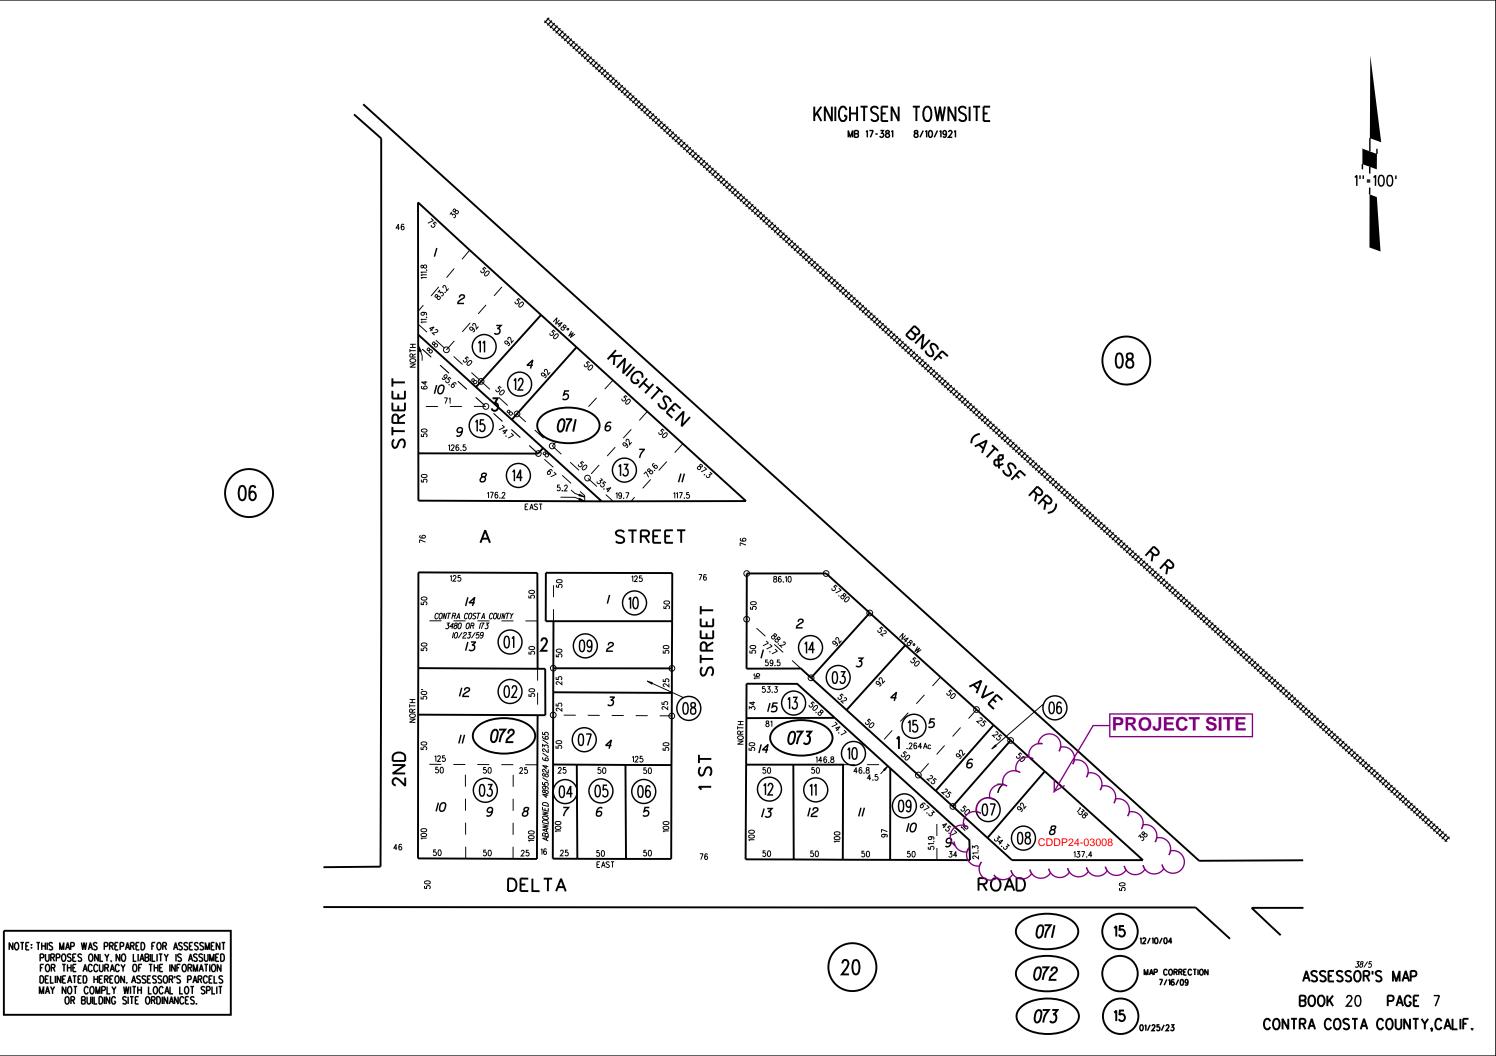

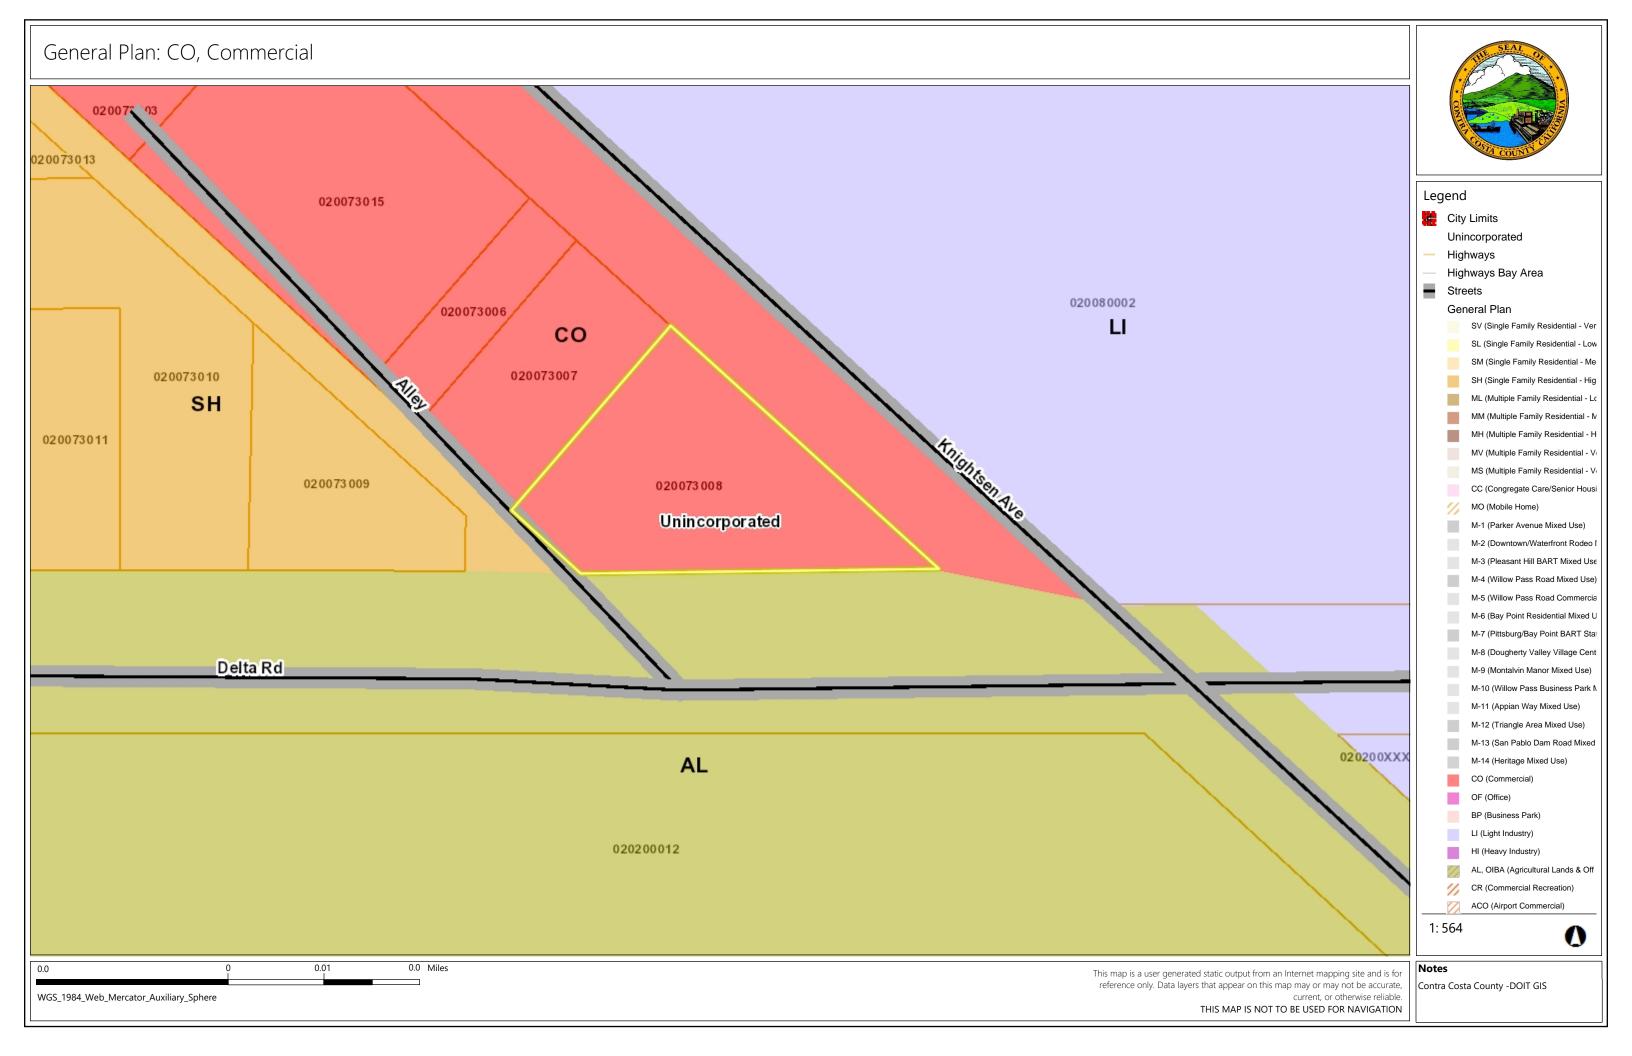

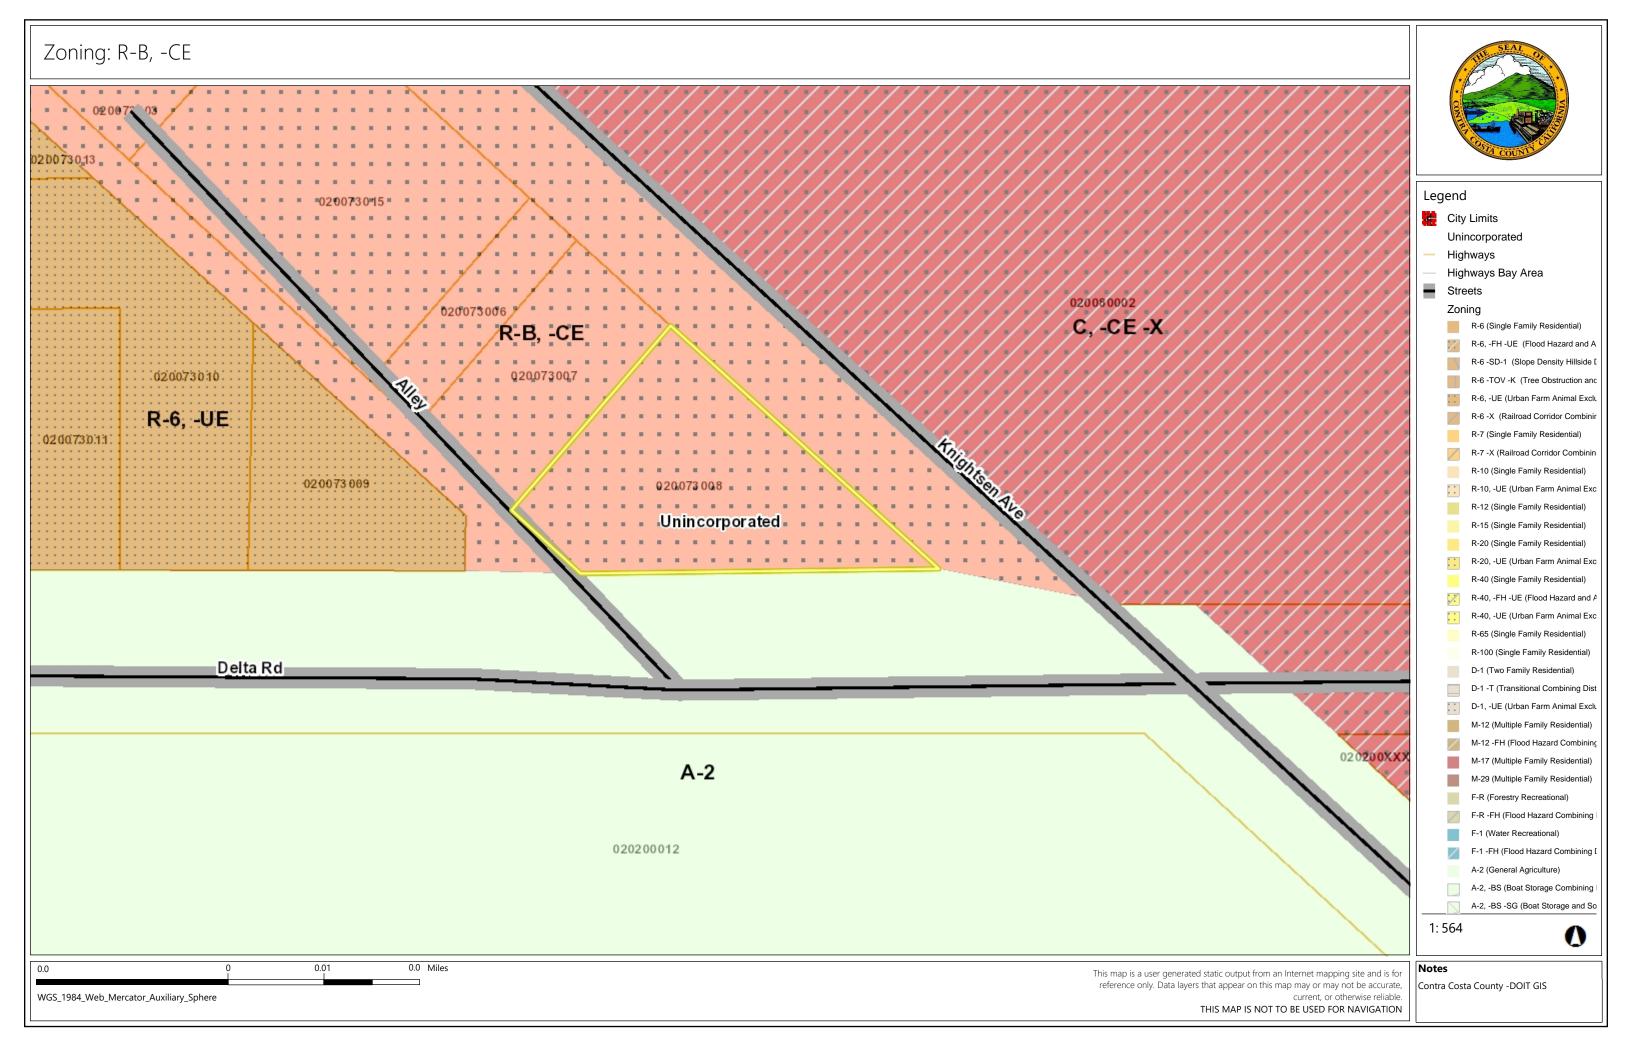


Aerial View Legend City Limits Unincorporated Highways Highways Bay Area Streets 020080002 Water Bodies County Boundary Bay Area Counties Assessment Parcels World Imagery Low Resolution 15m Imagery High Resolution 60cm Imagery 020073011 High Resolution 30cm Imagery Citations 020073009 020073008 Unincorporated. Delta Rd 020200XXX 020200012 1:564 0 0.0 Miles 0.01

WGS_1984_Web_Mercator_Auxiliary_Sphere

This map is a user generated static output from an Internet mapping site and is for reference only. Data layers that appear on this map may or may not be accurate, current, or otherwise reliable. THIS MAP IS NOT TO BE USED FOR NAVIGATION

Contra Costa County -DOIT GIS

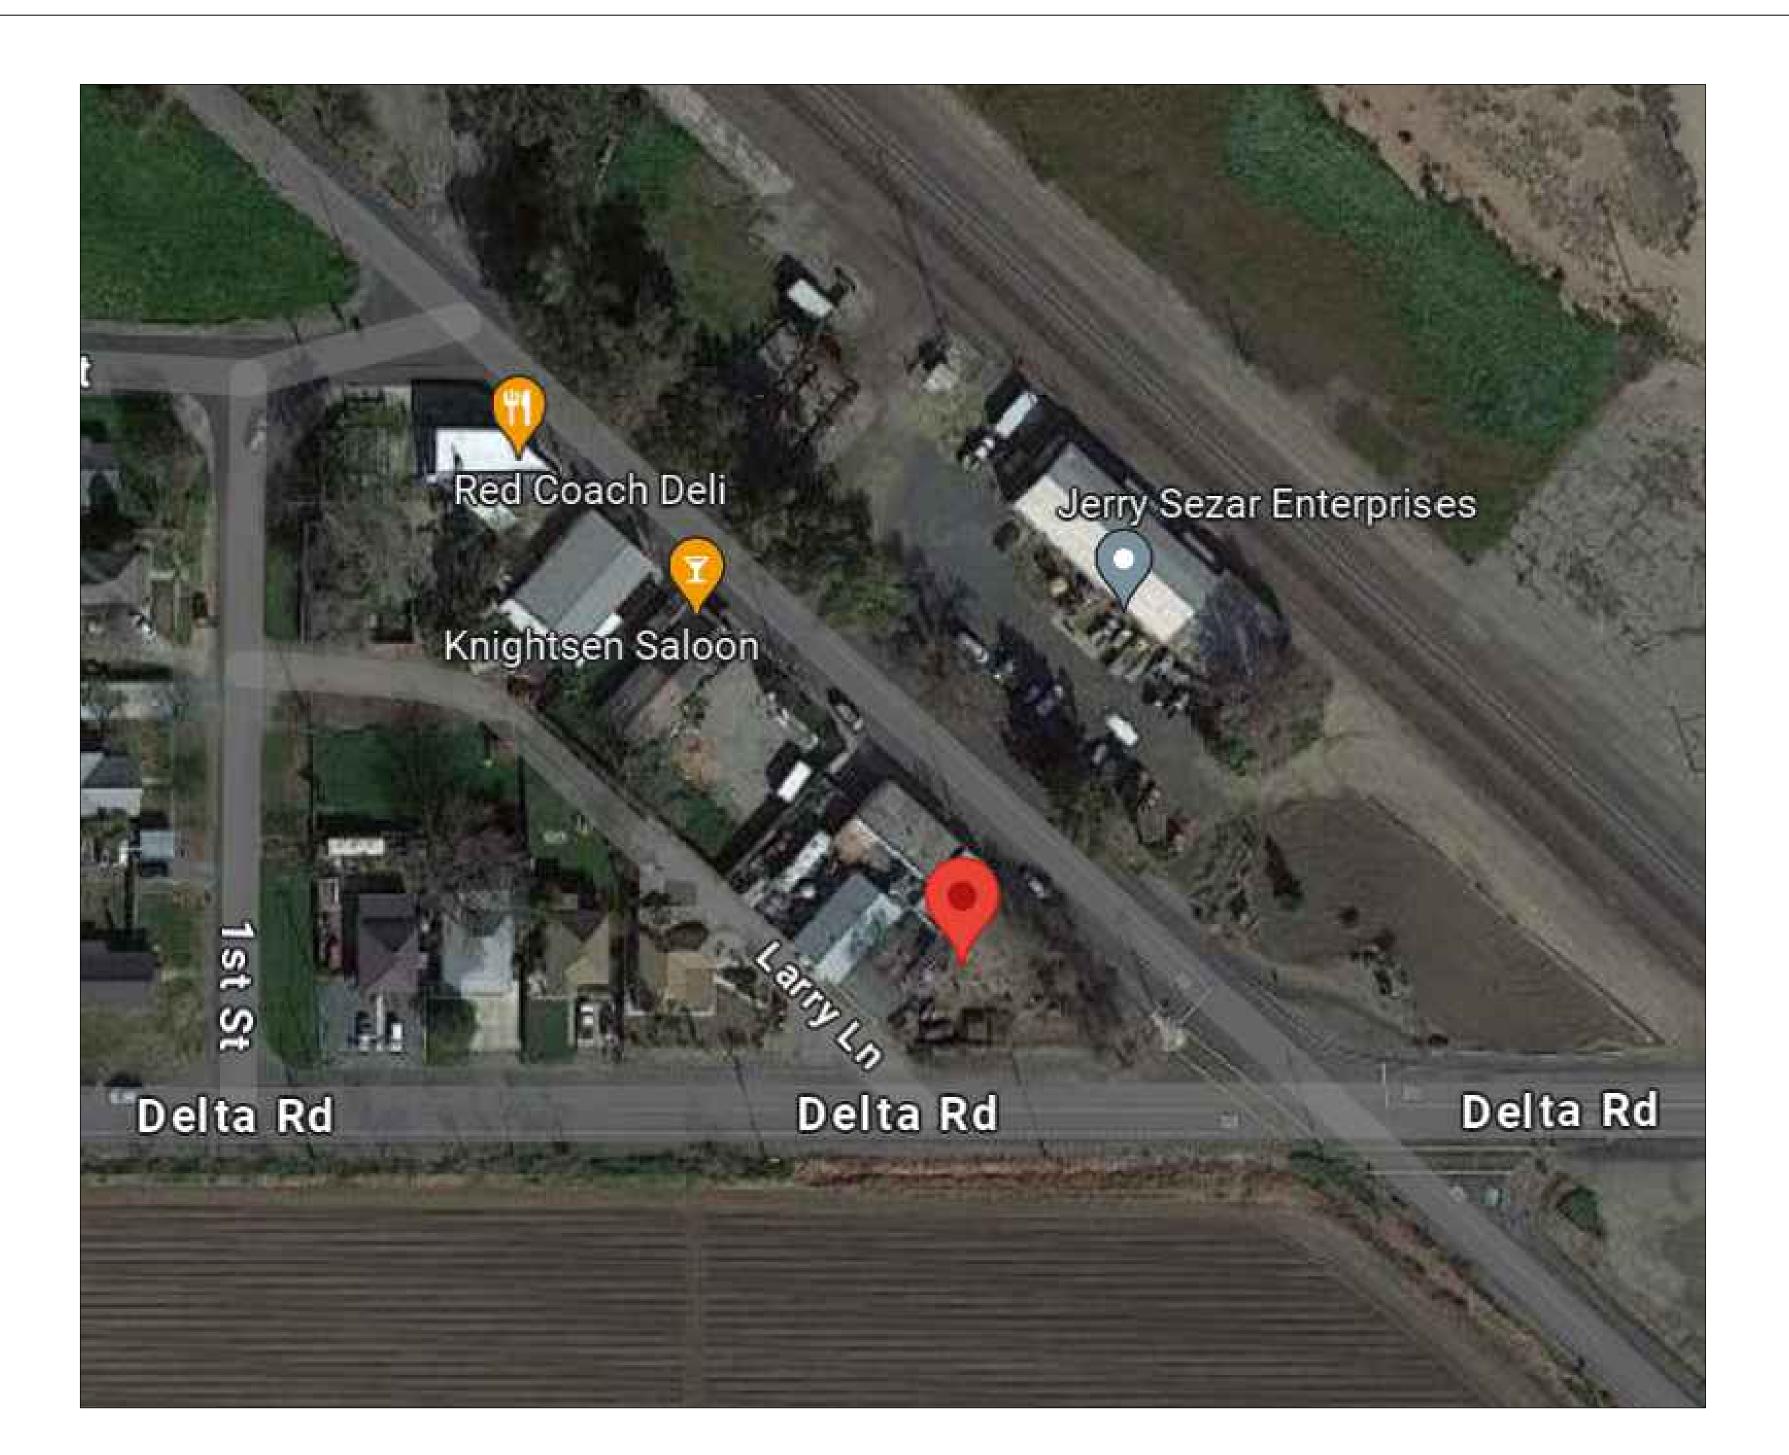



Project:

Accessory Building

Repair/ Alteration

Project Address: 3011 Knightsen Avenue, Knightsen

Sheet Title: Title Page

Revisions			
No.	Descrptn	Date	

Drawn By: Robert Cort

Date:

16Jan24

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Page

SCOPE OF WORK

- REPAIR/ALTER EXISTING LIVING UNIT INTO STORAGE BUILDING IN SAME LOCATION; NO CHANGE IN SIZE

APPLICABLE CODES

2022 CALIFORNIA BUILDING CODE 2022 CALIFORNIA ELECTRICAL CODE 2022 CALIFORNIA PLUMBING CODE 2022 CALIFORNIA MECHANICAL CODE 2022 CALIFORNIA ENERGY CODE 2022 CALIFORNIA CALGREEN CODE

PROJECT DATA

OCCUPANCY TYPE: U TYPE OF CONSTRUCTION: V STORIES: SINGLE AREA OF WORK: STORAGE BUILDING FIRE SPRINKLERS: NO RISK CATEGORY: II SEISMIC DESIGN CATEGORY: D ADDRESS: 3011 KNIGHTSEN AVE


CITY: KNIGHTSEN

APN: 020-073-008

SHEET INDEX

TITLE PAGE A GENERAL NOTES A1 SITE PLAN A2 EXISTING/PROPOSED FLOOR PLAN A3 EXISTING ELEVATIONS A4 PROPOSED ELEVATIONS S1 FOUNDATION/FRAMING PLAN CD1 CONSTRUCTION DETAILS E1 ELECTRICAL PLAN P1 PLUMBING PLAN

General Notes	Grading Notes	Framing Notes	Plumbing Notes	
 Contractor is responsible for construction Subcontractors are the responsibility of the contractor. Contractor shall comply with all local laws and ordinances of the public agencies having jurisdiction on this project. The scope of plan services are limited to providing a plan set. The plan set is for obtaining a permit, but may not contain all materials and methods for construction. All standard notes are typical U.O.N. Construction design is based on current California Codes (Title 24). Habitable rooms designed with adequate 	1. Contractor shall be responsible for adequate temporary drainage facilities during rainy season operation and protect all areas from erosion. Contractor shall repair any areas of erosion 2. All excavated soil for foundation work shall be redistributed on site or if removed from site should be properly disposed 3. Finished grade shall match existing grade and topography of the property including proper drainage away from the foundation with a minimum 5% slope	 Wood members to be Douglas-Fir and grade No. 2 or better. Mud sill required to be pressure treated Studs to be continuous from floor to roof or ceiling. Exterior stud framing to be 2x6 spaced 16 inch on center Interior stud framing to be 2x6 spaced 16 inch on center Project using conventional light framing. All wood framing connections per CRC Table 602.3(1) Fastening Schedule. 	1. Domestic water lines material is copper piping. 2. Atmospheric breakers required at exterior hose bibbs. 3. Drain, waste, vent (DWV) system to be ABS. 4. Toilets installed with min 24 inch clearance in front and 15 inch clearance on sides from the centerline. 5. Toilets installed with max 1.28 gallons per flush.	Project: Accessory Building Repair/
 6. Habitable rooms designed with adequate natural light and ventilation according to code minimums. 7. Property line setback requirements based on current zoning regulations. Actual setback distances in the field for structures are the responsibility of the property owner. 8. Existing structures and construction based on field conditions and are not the 	Concrete Notes		Finishes Notes 1. Stucco installed per manufacture with underlayment installed per manufacture. 2. Roof material to match existing and is the responsibility of the property owner and contractor 3. Roof gutters to be installed and properly drained to lawn or subsurface drain.	Alteration Project Ac 3011 Knig Avenue, Knightsen
responsibility of the plan designer. 9. Hard wired smoke alarms (detectors) installed in each bedroom and the adjacent hallway. Smoke alarms to be interconnected. Smoke alarms located per CRC 314.3.3. 10. Hard wired Carbon Monoxide (CO)	 All rebar #3 in size required to be grade minimum. All rebar #4 in size or greater required to be grade 60 minimum. Minimum strength for structural concrete required to be 2500 psi. Rebar clearances 3 inches to earth & 1 1/2 	 All electrical equipment to be listed and installed per manufacture. Electrical branch circuits and service equipment to be calculated and sized 	Energy/CalGreen	Sheet Tit. General No. Descript
alarm (detector) installed in hallway adjacent to bedrooms. CO alarms to be interconnected CO alarms located per manufacture. 11. Site address installed visible from the street. Address installed with min 4 inch height numbers. 12. Attic Access provided with a min 22x30	1.4.5/9" anabor holts spaced at 4 ft an contar	3. Electrical conductor sizing based on current NEC sizing table 310.15(B)16 4. AFCI protection installed for all new and modified 15 and 20 amp branch circuits located in rooms per CEC 210.12 (A). 5. GFCI protection installed for recptacles	1. All new lighting to be high efficacy and will meet the requirements of CEC table 150A 2. New outdoor lighting to have photocell control and motion sensor	No. Descrpu
inch opening.		located in bathrooms, garage, outdoors, kitchens, and laundry rooms. 6. Exterior equipment installed is rated for outdoors. 7. Outdoor receptacles to be weather-resistive type and have proper covers. 8. All circuits to be properly labeled for the devices served.		Drawn By Robert C Date: 16Jan Scale: N/A Page
				A

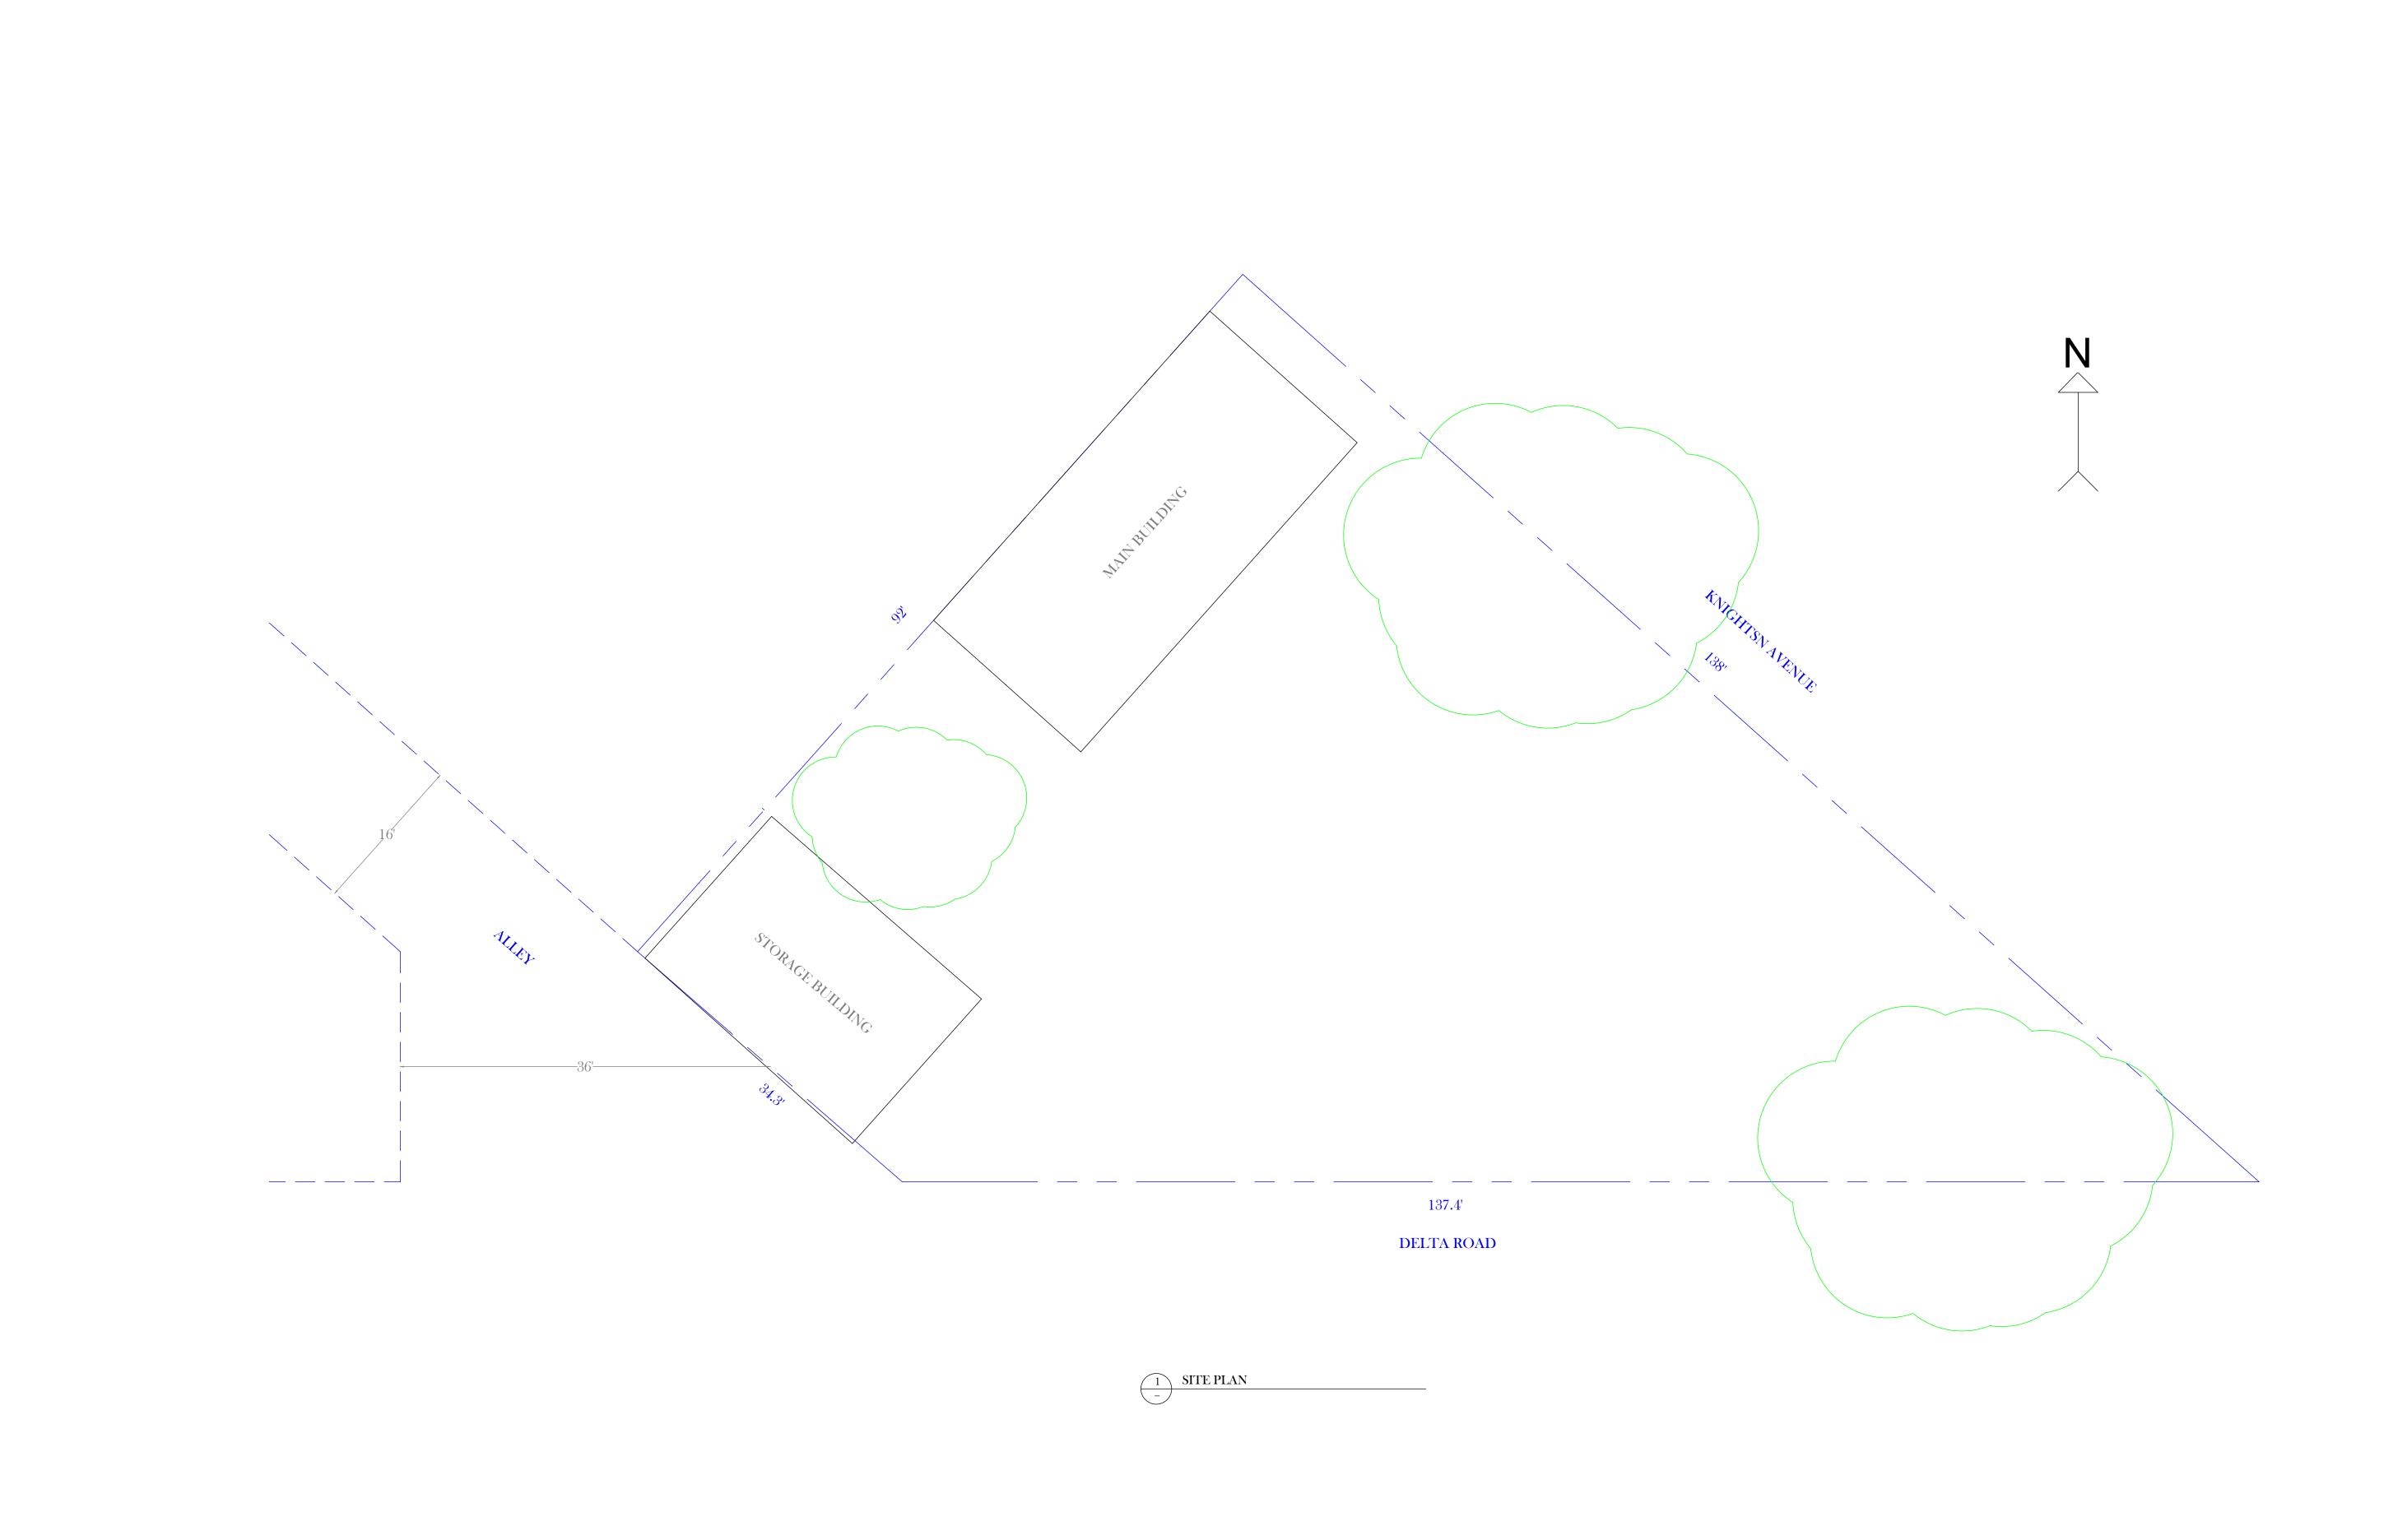

Cort Properties (415) 573-7443

Project:

Accessory Building

Repair/

Alteration
Project Address:

3011 Knightsen Avenue, Knightsen

Sheet Title: Site Plan

Revisions

Description Da

No. Descrptn Date

Drawn By:

Probert Cort

Date:


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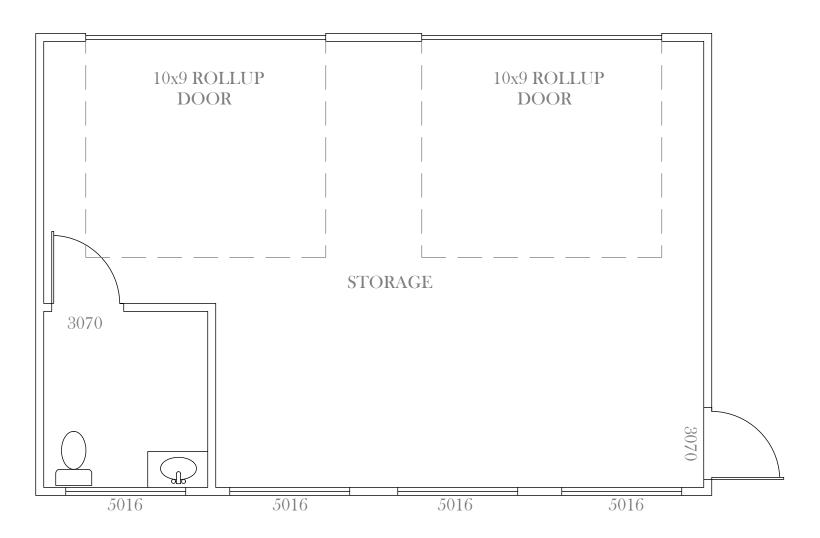
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Page


A 1



1 EXISTING FLOOR PLAN

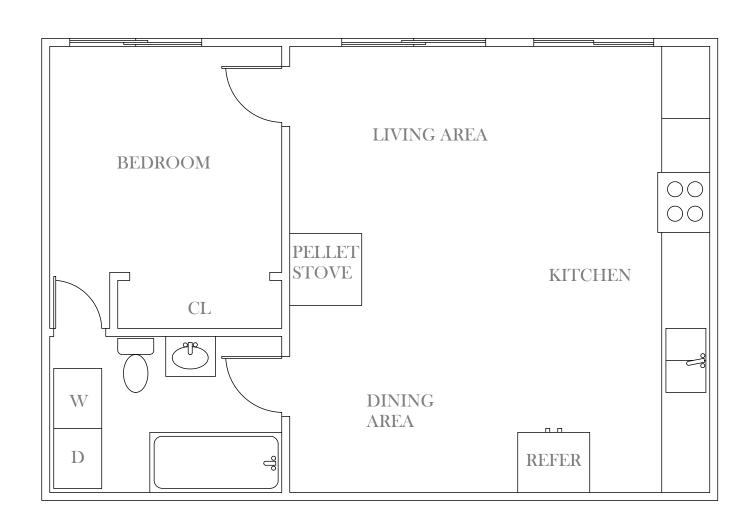

PROPOSED FLOOR PLAN

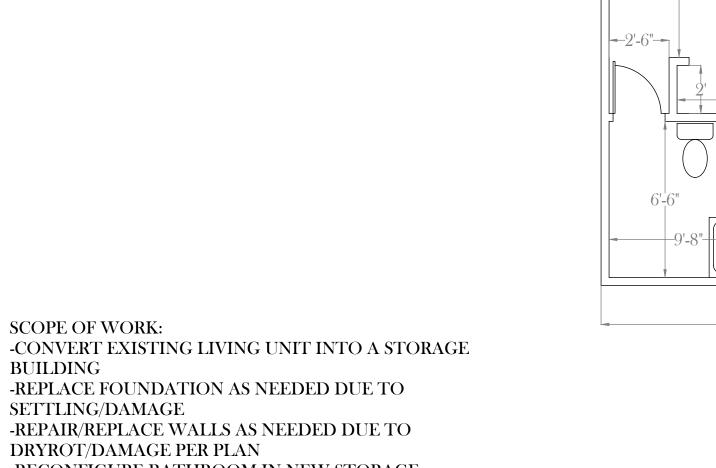

SCOPE OF WORK:

SETTLING/DAMAGE

DRYROT/DAMAGE PER PLAN

MAIN BUILDING WITH A PARAPET

-REPLACE FOUNDATION AS NEEDED DUE TO

-REPAIR/REPLACE WALLS AS NEEDED DUE TO

-RECONFIGURE BATHROOM IN NEW STORAGE

-EXTEND EXISTING WALLS RAISING THE ROOF AND


-REPLACE MAIN ELECTRICAL PLAN AND REWIRE PER PLAN

CREATING A FLAT ROOF TO MATCH THE EXISTING


-INSTALL NEW DOORS AND WINDOWS PER PLAN

BUILDING FROM EXISTING LIVING UNIT

BUILDING

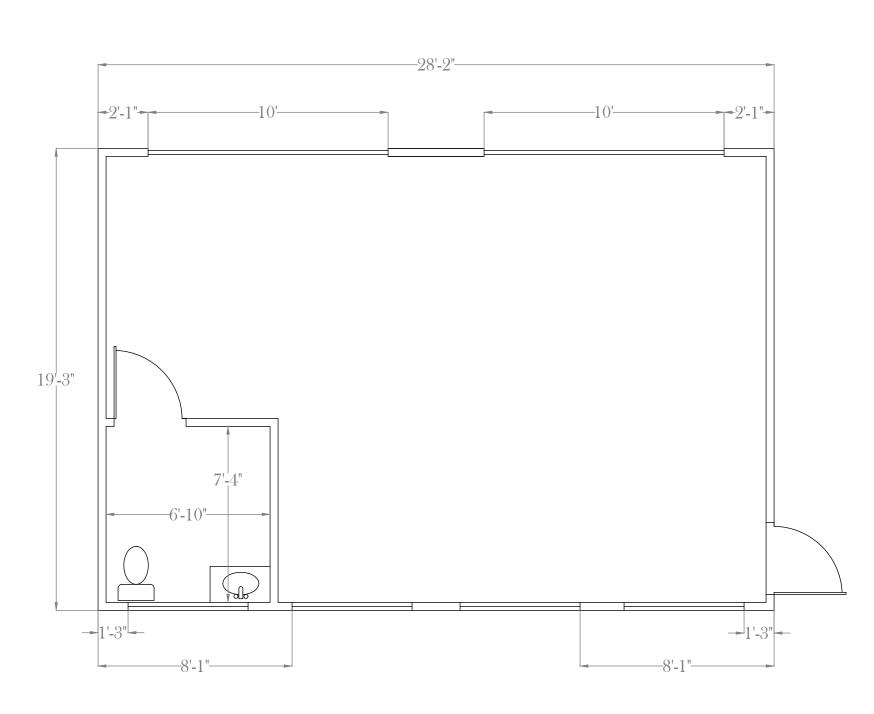

PROPOSED FLOOR PLAN
WITH DIMENSIONS

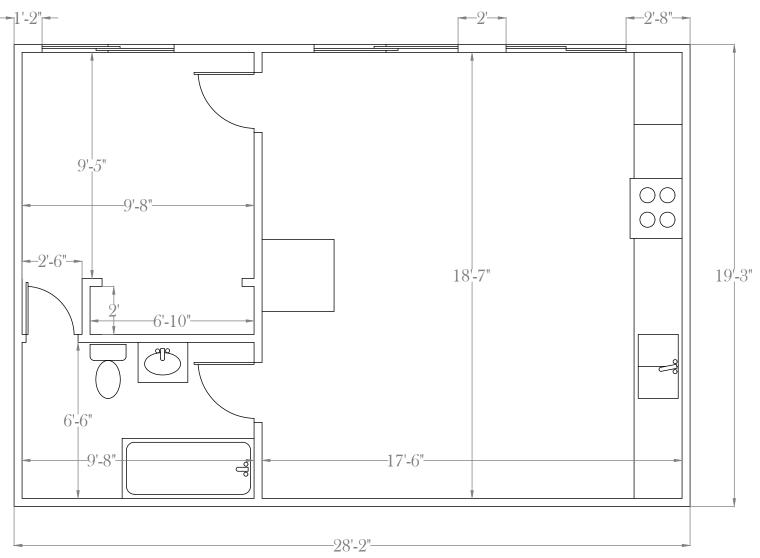

2 EXISTING FLOOR PLAN - WITH DIMENSIONS

> Sheet Title: Existing & Proposed Floor Plan

Project:

Accessory

Alteration

Project Address:

3011 Knightsen

Building

Repair/

Avenue,

Knightsen

	Revisions		
No.	Descrptn	Date	


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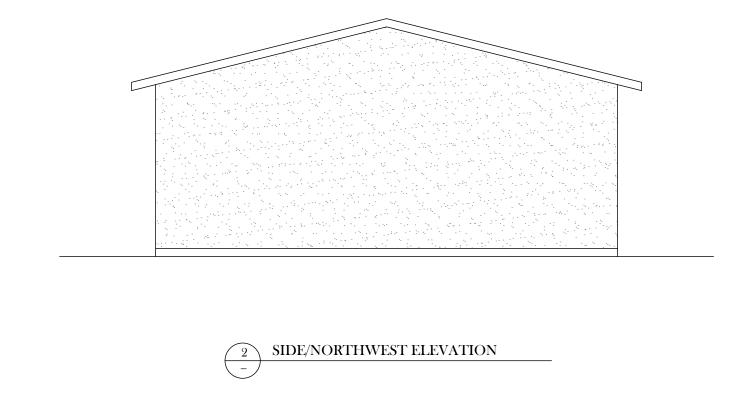
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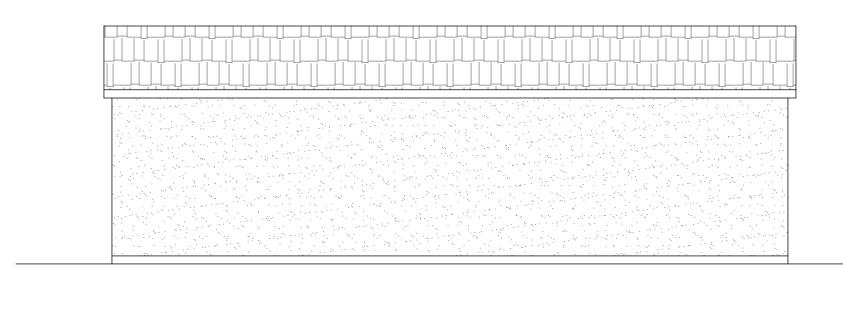
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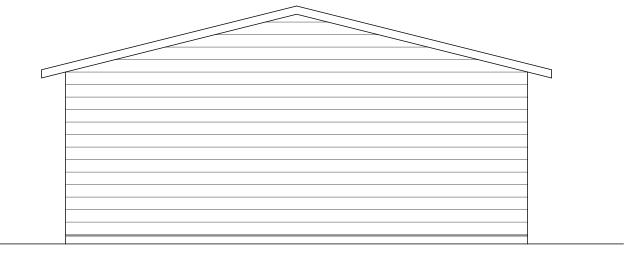
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REAR/SOUTHWEST ELEVATION



Project:

Accessory Building Repair/

Alteration Project Address:

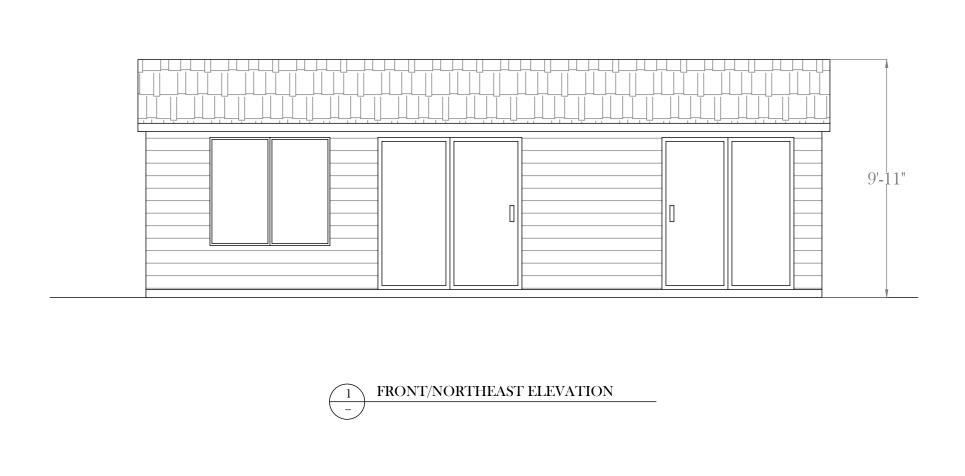3011 Knightsen Avenue, Knightsen

Sheet Title: Existing Elevations

Revisions		
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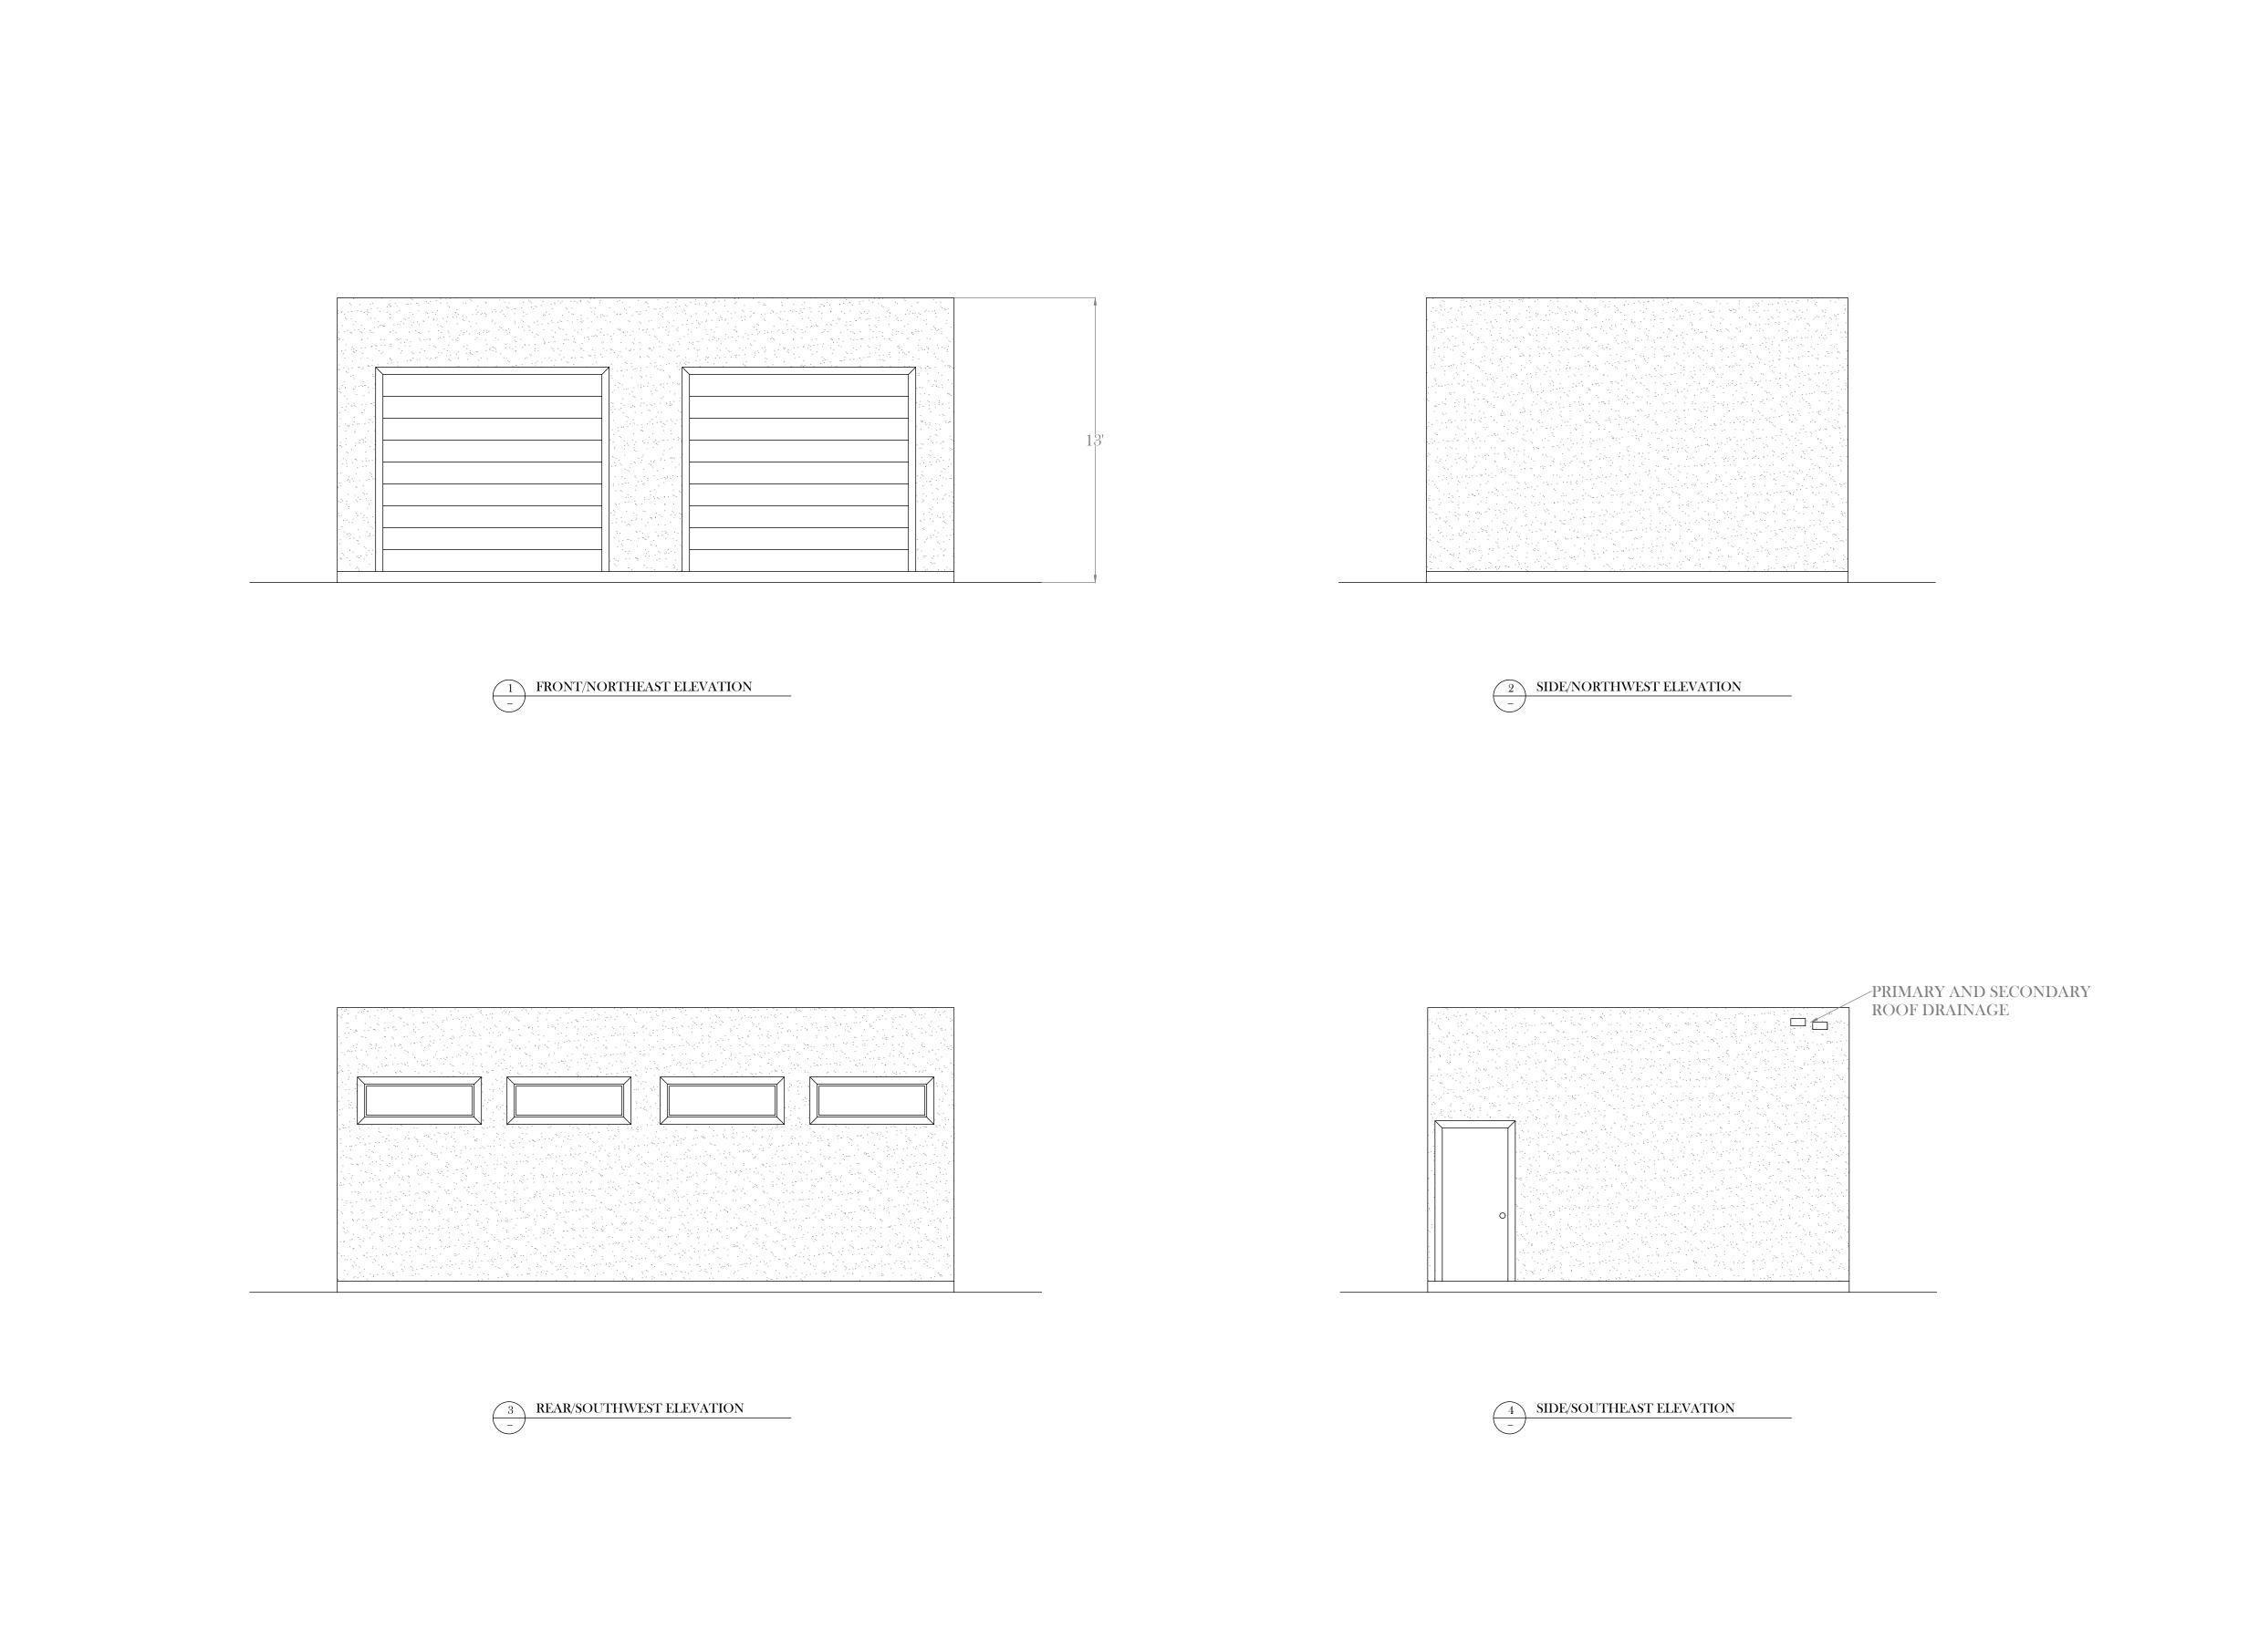
Robert Cort

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1/4" = 1' 0"



Project:

Accessory
Building
Repair/
Alteration

Project Address: 3011 Knightsen Avenue, Knightsen

Sheet Title: Proposed Elevations

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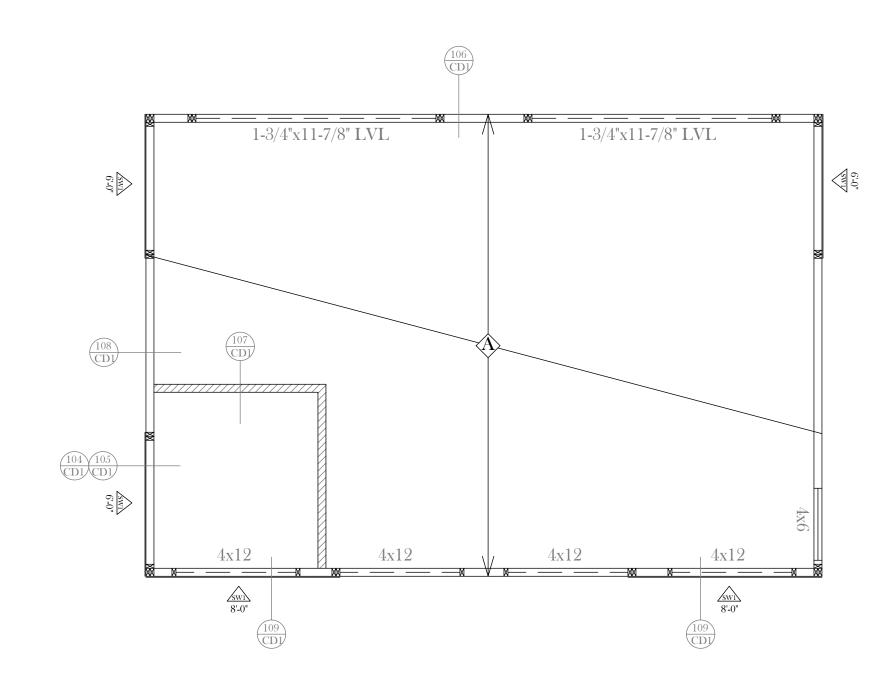
1/4" = 1' 0"

FOUNDATION PLAN

BRACED WALL PANEL SCHEDULE

	Plywood or OSB Sheathing	10d Edge Nailing	10d Field Nailing	Framing member at adjoining panel edges	,	Top connector
SW1	15/32"	10d @ 4" o.c.	10d @ 12" o.c.	3x or 2 - 2xs stitched	48" o.c. max	A35 @ 24" o.c.

 $\ \ \, \ \, \ \, 12"$ MITEK OPEN WEB WOOD ROOF TRUSSES @ 16" O.C.



BRACED WALL/FRAMING PLAN

*10-6" CEILING HEIGHT

NEW 2X4 BEARING WALLS

NEW 2X4 NON-BEARING WALLS

Sheet Title: Foundation and Framing

Project:

Accessory

Building Repair/

Avenue,

Knightsen

Alteration

Project Address:

3011 Knightsen

Plan

Revisions
No. Descrptn Date

No. Descripting Date

Drawn By:

Robert Cort

Date:


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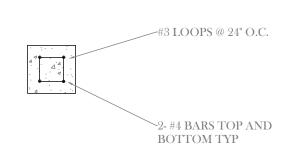
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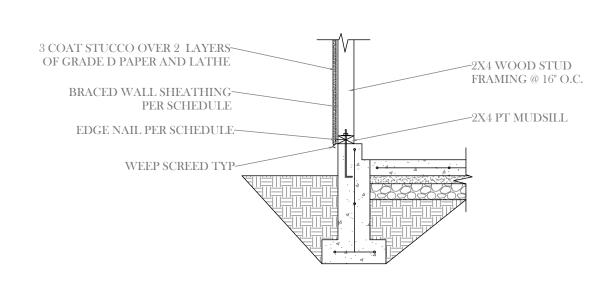
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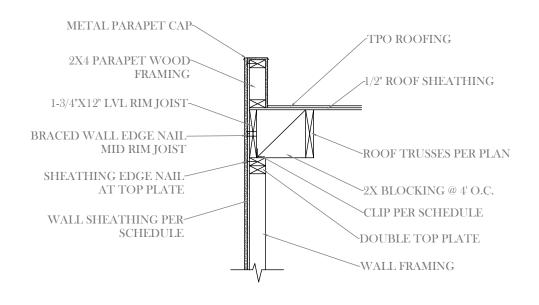
TIE BEAM INTERSECTION


#4 BARS HOOK INTO\


#4 HORIZONTAL BARS IN STEM WALL

STEM WALL

BRACED WALL CONNECTION

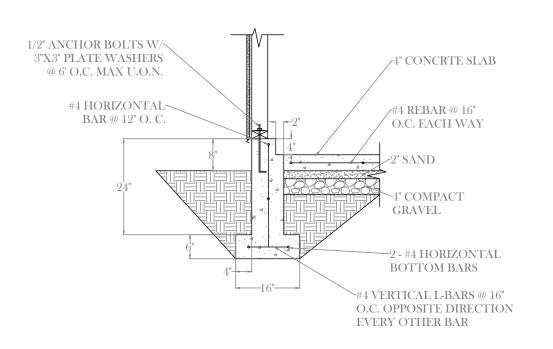


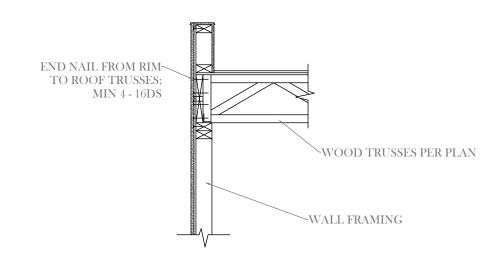

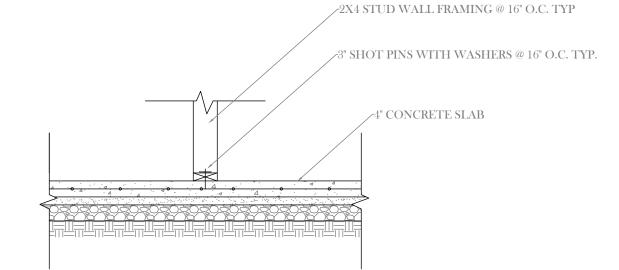

STEM WALL

TIE BEAM PER PLAN

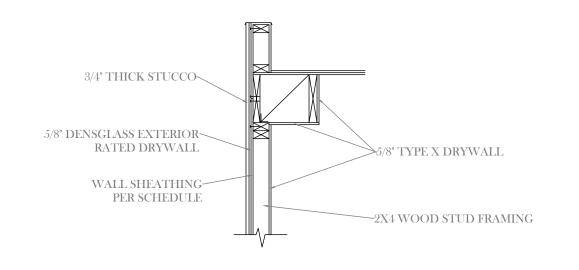








INTERIOR WALL FRAMING DETAIL TYP

1 HOUR RATED WALL UL U305 / GA WP 8130

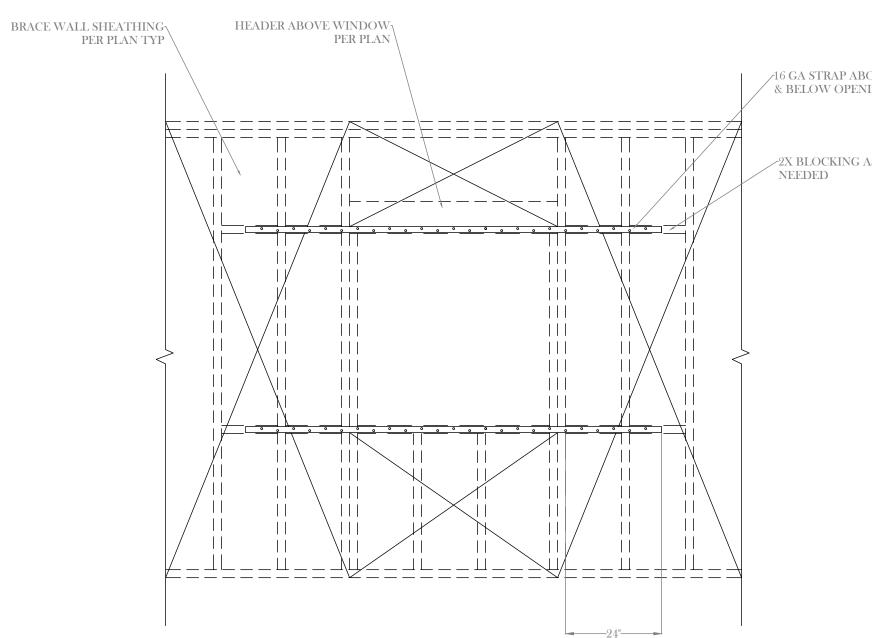

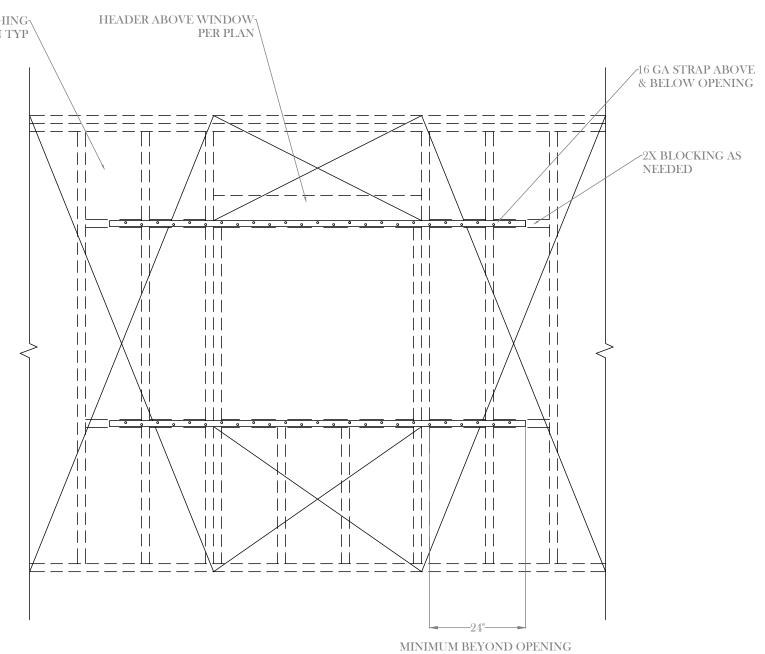



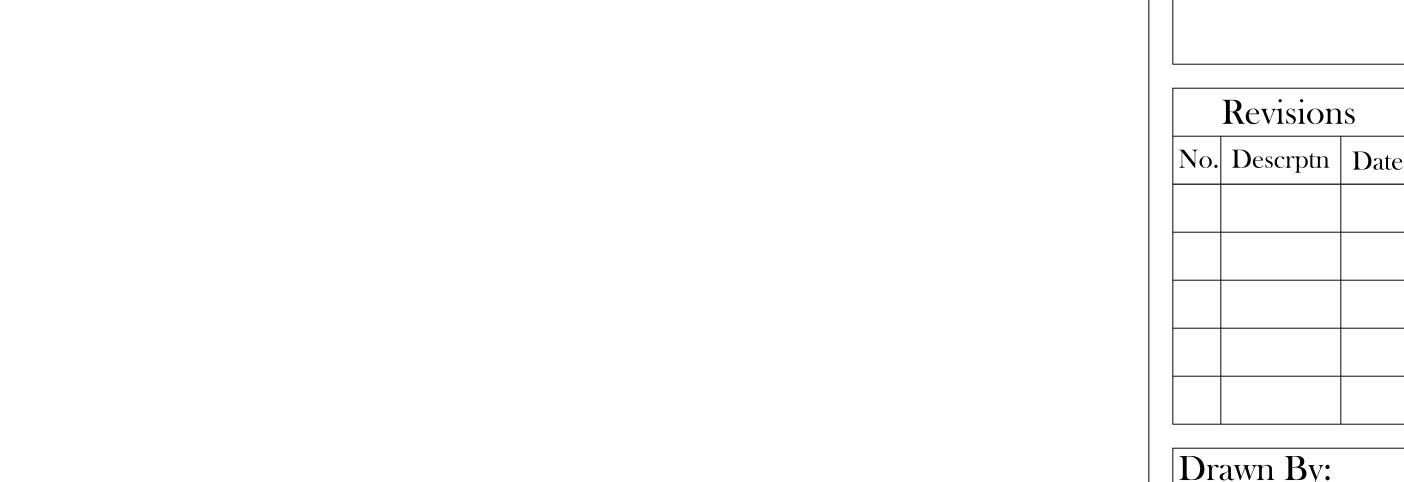

Project:

Accessory

Building Repair/ Alteration Project Address: 3011 Knightsen Avenue, Knightsen

Sheet Title: Construction Details

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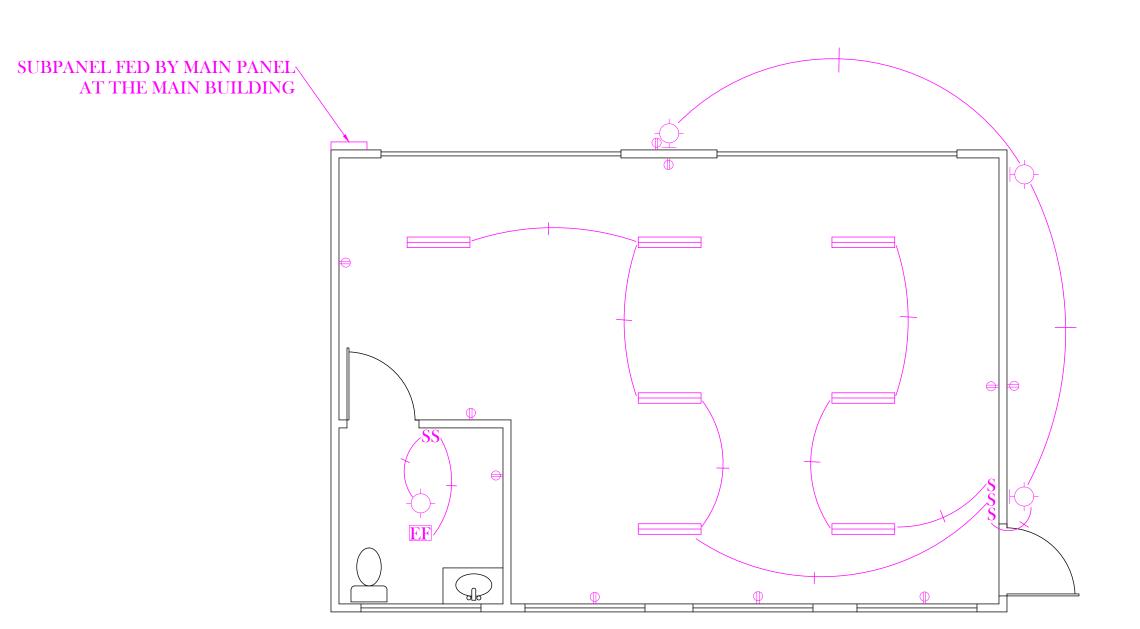
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1/2" = 1' 0"



	DESCRIPTION	COMMENTS
	LIGHT FIXTURE	
	DROP LIGHT	
	EXTERIOR LIGHT	
S	SWITCH	
EF	EXHAUST FAN	
Ф	RECEPTACLE	GFCI AS REQ

REPLACE FEEDERS TO 2/0 AWG THWN CONDUCTORS -NEW ELECTRICAL THROUGHOUT PER PLAN -RECEPTACLES IN BATHROOM AND EXTERIOR TO BE GFCI PROTECTED -EXTERIOR RECEPTACLES TO BE WEATHERPROOF (WP) TYPE WITH PROPER WATER RESISTANT COVER -ALL LIGHTING TO BE LED TYPE -EXHAUST FAN & LIGHTING TO BE CONTROLLED SEPARATELY IN THE BATHROOMS -EXTERIOR LIGHTS TO HAVE PHOTOCELL AND MOTION OR AUTOMATIC CONTROL -EXTERIOR LIGHTING TO SHALL BE SUITABLE FOR WET LOCATIONS -VACANCY SENSORS REQUIRED FOR LIGHTING CONTROL IN **BATHROOMS**

-EXISTING 100 AMP SUBPANEL UPGRADED TO 200 AMP;

SCOPE OF WORK:

Project:

Accessory Building

Repair/

Alteration

Project Address:

3011 Knightsen Avenue, Knightsen

Sheet Title: Electrical Plan

Revisions

No. Descrptn Date

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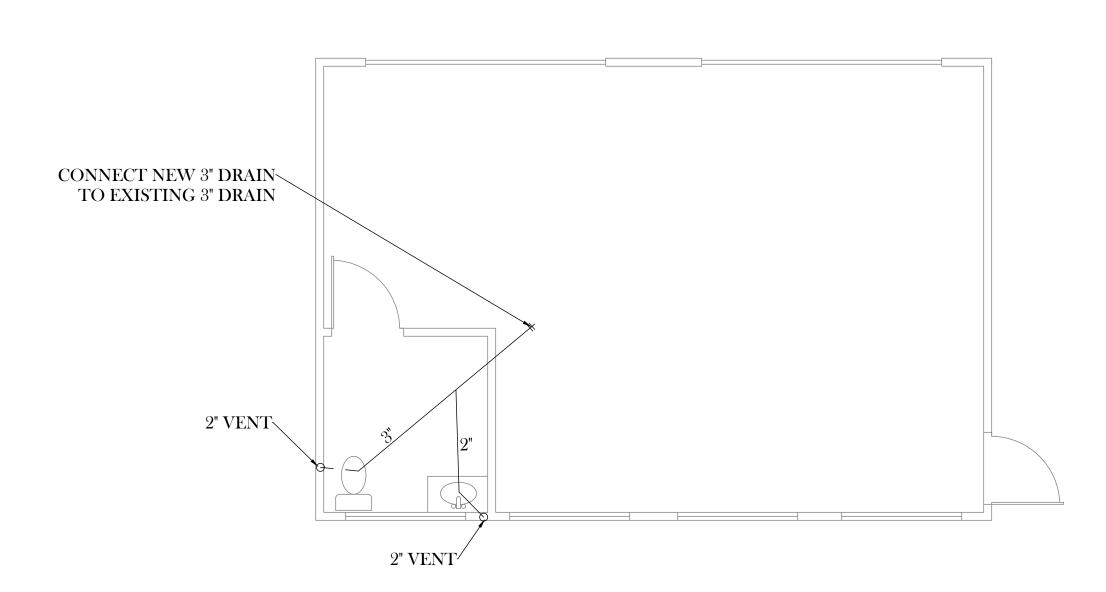
Robert Cort

Date:

16Jan24

Scale:

1/4" = 1'0"



SCOPE OF WORK:
-INSTALL NEW TOILET AND SINK IN
NEW CONFIGURED BATHROOM
-CONNECT NEW DRAIN LINES TO
EXISTING BUILDING MAIN DRAIN
-RECONFIGURE EXISTING COLD
WATER LINE FOR NEW TOILET AND
SINK
-ADD ON-DEMAND HOT WATER
HEATER UNDER THE SINK FOR HOT
WATER

1 PLUMBING PLAN
-

Cort Propertie (415) 573-7448

Project:

Accessory Building

Repair/

Alteration

Project Address: 3011 Knightsen

Avenue, Knightsen

Sheet Title: Plumbing Plan

Revisions		
No.	Descrptn	Date

Drawn By:

Robert Cort

Date:

16Jan24

Scale:

1/4" = 1' 0"

Page

P1