## 1524 MANNING LN., ALAMO A RESIDENTIAL EXPANSION PROJECT



### VICINITY MAP

**ABBREVIATIONS** 

AC: Air Conditioning, Acoustical

ADJ: Adjust, Adjustable, Adjacent

AGA: American Gas Association

ALT: Alternate, Alteration; Altitude

AFF: Above Finished Floor

&: And

ABV: Above

ADH: Adhesive

BR: Bedroom,

CLO.: CLEAN-OUT

CSMT: CASEMENT

ELEC.: ELECTRICAL

GC: General Contractor

GPH: Gallons Per Hour

GYP BD: Gypsum Board

S.D.: STRUCTURAL DRAWING

U.O.N.: Unless Otherwise Noted

W.P.M Water Proofing Membrane

V.C.T. Vinyl Composition Tile

V.I.F.: VERIFY IN FIELD

GFCI: Ground Fault Circuit Interrupted

GA: Gauge, Gage

CLG: Ceiling

DTL. DETAIL

E: EXISTING

GAL: Gallon

GLZ: Glaze

GVL: Gravel

GYP: Gypsum

INSTL.: Install

PNL.: PANEL

VERT. Vertical

WDW. Window

VYL. Vinyl

WD. Wood

WT. Weight

YD. Yard

**OPT.: OPTIONAL** 

SH: SINGLE HUNG

N: NEW

@: At



**GRAPHIC SYMBOL LEGEND** 

- DETAIL NUMBER

SHEET LOCATION

- DETAIL AREA CUT

- ELEVATION VIEW

SHEET LOCATION

SHEET LOCATION

-REVISION NUMBER

3'-0'X5'-0"

DOOR TAG,

WINDOW TAG,

AREA OF REVISION

SHEET NOTES TAG

**ELEVATION NUMBER** 

**BUILDING SECTION LETTER** 

FULL BUILDING SECTION

PARTIAL BUILDING SECTION

PROJECT AND TRUE NORTH

WINDOW AND DOOR SIZE TAG:

SEE WINDOW/DOOR SCHEDULE

SEE WINDOW/DOOR SCHEDULE

#### PROJECT DIRECTORY

Owner: Javaid and Jocelyn Noorzad 1524 Manning Ln., Alamo, CA 94507 Email: jocelynnoorzad@gmail.com Phone #: 510-600-5100

Architect: LNX Architecture inc. Address: 6710 Corte Snata Maria, Pleasanton, CA 94566 Responsible Person: Yuan Lin, Architect Phone#: 925 357 5801 Email: yuanlin29@yahoo.com

#### **CODE COMPLIANCE:**

2022 CBC,CMC,CPC,CEC, CRC, CFC 2022 CAL GREEN STANDARDS 2022 CALIFORNIA ENERGY CODE CONTRA COSTA CO. CODES/ORDINANCES

## DRAWING DIRECTORY

A-1.1 COVER SHEET AND SITE PLAN WORK POINT, CONTROL POINT A-2.1 1ST FLOOR PLAN OR DATUM POINT INDICATION NOTALL CUT INDICATOR

A-2.2 2ND FLOOR PLAN

G-1 SURVEY MAP

A-2.3 ROOF PLAN A-3.1 ELEVATIONS & SECTION A-3.2 ELEVATIONS & SECTION

> 3). Add 2nd story to accomodate 4 bedrooms/ 4 baths 4). Install new 400AMP electrical panel, heat pump

> water heater and ducted AC unit;

5). Install new fire sprinkler system, permit separately; 6). Modify (E) driveway and front yard landscaping.

#### PROJECT INFO.

LOCATION:	1524 Manning Ln.,	Alamo, CA 94507
APN:		191-040-028-0
ZONING:		R-20
LOT SIZE:		9,889 SF
CONSTRUCTIO	N TYPE: TYPE V/B;	SPRINKLERED
OCCUPANCY GROUP: R-3/U(garage)		
(E) HOUSE:		
(E) LIVING AREA	<b>∖</b> :	1140 SF
(E) GARAGE AREA:		488 SF
(E) BUILDING FOOT PRINT:		1745 SF
(N) ADDITION:		
(N) 1ST FLOOR:		1741 SF

(N) 2ND FLOOR: 2119 SF (N) TOTAL MAIN HOUSE LIVING AREA: 3860 SF 656 SF (N) GARAGE AREA: (N) COVERED FRONT PORCH: 82 SF

LOT COVERAGE: (1741+656+82+272)/ 9889 = 27.8% FAR(FLOOR AREA RATIO): 3860/ 9889 = 39%

272 SF

FIRE SPRINKLERS: YES, DEFERRED SUBMITTAL OF NFPA 13D 2019 APPROVED FIRE SPRINKLER SYSTEM PER SMC 16.17.080

#### SCOPE OF WORK:

(N) COVERED SIDE PATIO:

1). Expand (E) house of 1140 sf to 1876 sf on 1st floor to accomodate open living/dining/kitchen and foyer. 2). Expand (E) garage to accomodate extra storage and

## ---- (E) HOUSE FOOTPRINT (E) EXTERIOR WALL TO REMAIN N66°53'54"E BUILDING OUTLINE PROPERTY LINE 107' (E) LANDSCAPING TO REMAIN WALL TO REMAIN 7'-6" -(E) ĠARAGE FOOTPRINT SIDE PATIO : 191-040-028 **NEW ADDITION** ₩ SIDE SETBACK 23'-9 1/8" (E) LANDSCAPING TO REMAIN SÉTBACK (E) HOUSE **FOOTPRINT BENCH** (N) DRIVEWAY -EX. GAS METÆR ROOF LINE 12'-6 1/2" 10 6 1/2" 20'-6" PLANTER TORM DRAIN ZEX. NHLYTY POLÉ /107.00<sup>\*</sup>/\$66°53'54"W (X MANNING LANE

**LEGEND** 

## **PLAN NORTH** SITE PLAN SCALE: 1"=10'-0"

#### SITE PLAN NOTES

1. SEE GENERAL NOTES ON A2.1 FOR ADDITIONAL INFORMATION 2. THE SITE PLAN IS NOT A SURVEY. IT IS PROVIDED FOR BUILDING AND LIMITED SITE PLAN LAYOUT ONLY. THE CONTRACTOR SHALL VERIFY IN FIELD ALL GRADES, EXISTING IMPROVEMENTS, PROPERTY LINES AND SETBACKS, EASEMENTS, UTILITIES AND SUBSTRUCTURES. SITE SPECIFIC SOILS REPORTS AND CIVIL DRAWINGS SHALL TAKE PRECEDENCE OVER NOTES AND DETAILS ON THIS SET OF

3. THIS PLAN IS NOT A GRADING AND DRAINAGE OR EROSION CONTROL PLAN. CONSULT A CIVIL ENGINEER FOR SUCH INFORMATION. 4. DISPLACED TOP SOIL SHALL BE STOCKPILED FOR REUSE IN A DESIGNATED AREA AND COVERED

OR PROTECTED FROM EROSION 5. ALL GRADING, SITE PREPARATION, PLACEMENT AND COMPACTION OF FILL IS TO BE DONE IN ACCORDANCE WITH THE COUNTY OF CONTRA COSTA. GRADING ORDINANCE AND ALSO UNDER THE OBSERVATION OF THE GEOTECHNICAL ENGINEER.

6. AT A MINIMUM, THE PAD GRADE UNDER BUILDING SHALL HAVE POSITIVE SLOPE TO A MINIMUM OF ONE AREA DRAIN WHICH SHALL BE PIPED TO STREET(OR OTHER SUITABLE DISCHARGE POINT DETERMINED BY THE CIVIL ENGINEER AND/OR LOCAL GOVERNING AUTHORITY ), VIA A

NON-CORROSIVE DEVICE. 7. ALL FOUNDATION PERIMETER AND ROOF DRAINAGE SHALL BE PIPED TO STREET OR APPROVED DISCHARGE SYSTEM. 8. IRRIGATION SYSTEM SHALL BE DESIGNED TO PREVENT SATURATION OF SOIL ADJACENT TO THE

BUILDING, STRUCTURES, OR UTILITY BOXES 9. SEE LANDSCAPE OR CIVIL DRAWINGS FOR ALL SITE AND HARDSCAPE DRAIN 10. WATER SHOULD BE PREVENTED FROM PONDING ANYWHERE ON THE LOT PARTICULARLY NEAR THE HOUSE. WATERFROM DOWN SPOUTS AND YARD DRAINS SHOULD BE CONNECTED TO TIGHTLINE PIPES THAT CARRY THE WATER TO AVAILABLE DISCHARGE FACILITIES. REFER TO A-4 CALGREEN

11. CRAWL SPACES SHOULD BE GRADED IN SUCH A WAY THAT WATER WHICH MAY STILL ENTER THE CRAW SPACE FLOWS TO A LOW POINT WHERE IT CAN BE PIPED BENEATH THE PERIMETER FOUNDATION (GRADE BEAM OR "T" FOOTING ) AND DISCHARGED.

12. AT ALL RETAINING WALLS, LANDSCAPE WALLS OR CLOSE PROXIMITY TO STRUCTURES, PROTECTIVE SUB DRAINAGE SHALL BE INSTALLED BENEATH THE FILLS IN THE SWALE AREAS. THE SUB DRAINS SHOULD CONSIST OF A BLANKET OR TRENCH FILLED WITH CLASS TWO PERMEABLE MATERIAL AND HAVING A WIDTH OF AT LEAST 18 INCHES. THE SUB DRAINS SHOULD HAVE A VERTICAL HEIGHT OF 4 FEET AND SHOULD BE INSTALED AT THE BACK OF THE LOWEST ELEVATION POSSIBLE TO PERMIT DAYLIGHT DRAINAGE ON THE PROPERTY(OR TO AN APPROVED DISCHARGE SYSTEM). ENDS OF PIPES SHALL BE RIP RAPPED SO THEY WILL NOT BECOME BLOCKED IN THE FUTURE. SLD. AND SEE CIVIL AND LANDSCAPE PLUS SEE DETAILS FOR ANY REQUIRED WATERPROOFING ALONG THE VERTICAL FACE OF ANY BURIED WALLS. 13. THE CONTRACTOR IS RESPONSIBLE FOR KEEPING A SET OF CURRENT, THOROUGH, AND

ACCURATE AS-BUILT DRAWINGS AT THE PROJECT SITE. 14. ALL WATER USE SHALL BE METERED EXCEPT FOR USE IN DISINFECTION AND FLUSHING OF WATER MAINS.

15. NO WATER VALVES ON THE EXISTING SYSTEM NOR ANY NEW VALVE CONNECTED TO THE EXISTING SYSTEM SHALL BE OPENED OR CLOSED BY ANYONE EXCEPT AUTHORIZED

WATER DEPARTMENT PERSONNEL. 16. MAINTAIN, SECURE, AND PROTECT ANY EXISTING WATER SYSTEM FACILITY IN PLACE UNTIL THE PROPOSED WATER SYSTEM IS COMPLETED AND ACTIVATED. 17. PARTS FROM ABANDONED CITY FACILITIES, INCLUDING METERS AND VALVES, SHALL BE

RETURNED TO THE WATER DEPARTMENT INSPECTOR. 18. NO EXISTING OR NEW UTILITY METERS OR VAULTS SHALL BE LOCATED WITHIN THE NEW DRIVEWAY APPROACH. ALL EXISTING OR NEW UTILITY VAULTS SERVING THE PROJECT SITE

SHALL BE LOCATED ON-SITE AND NOT WITHIN THE PUBLIC UTILITY EASEMENT, IF ANY.



**REVISIONS** 

PROJECT NAME


SHEET NAME **COVER SHEET** & SITE PLAN

5

DATE: 06/11/2024

SCALE: AS SHOWN

SHEET NO.

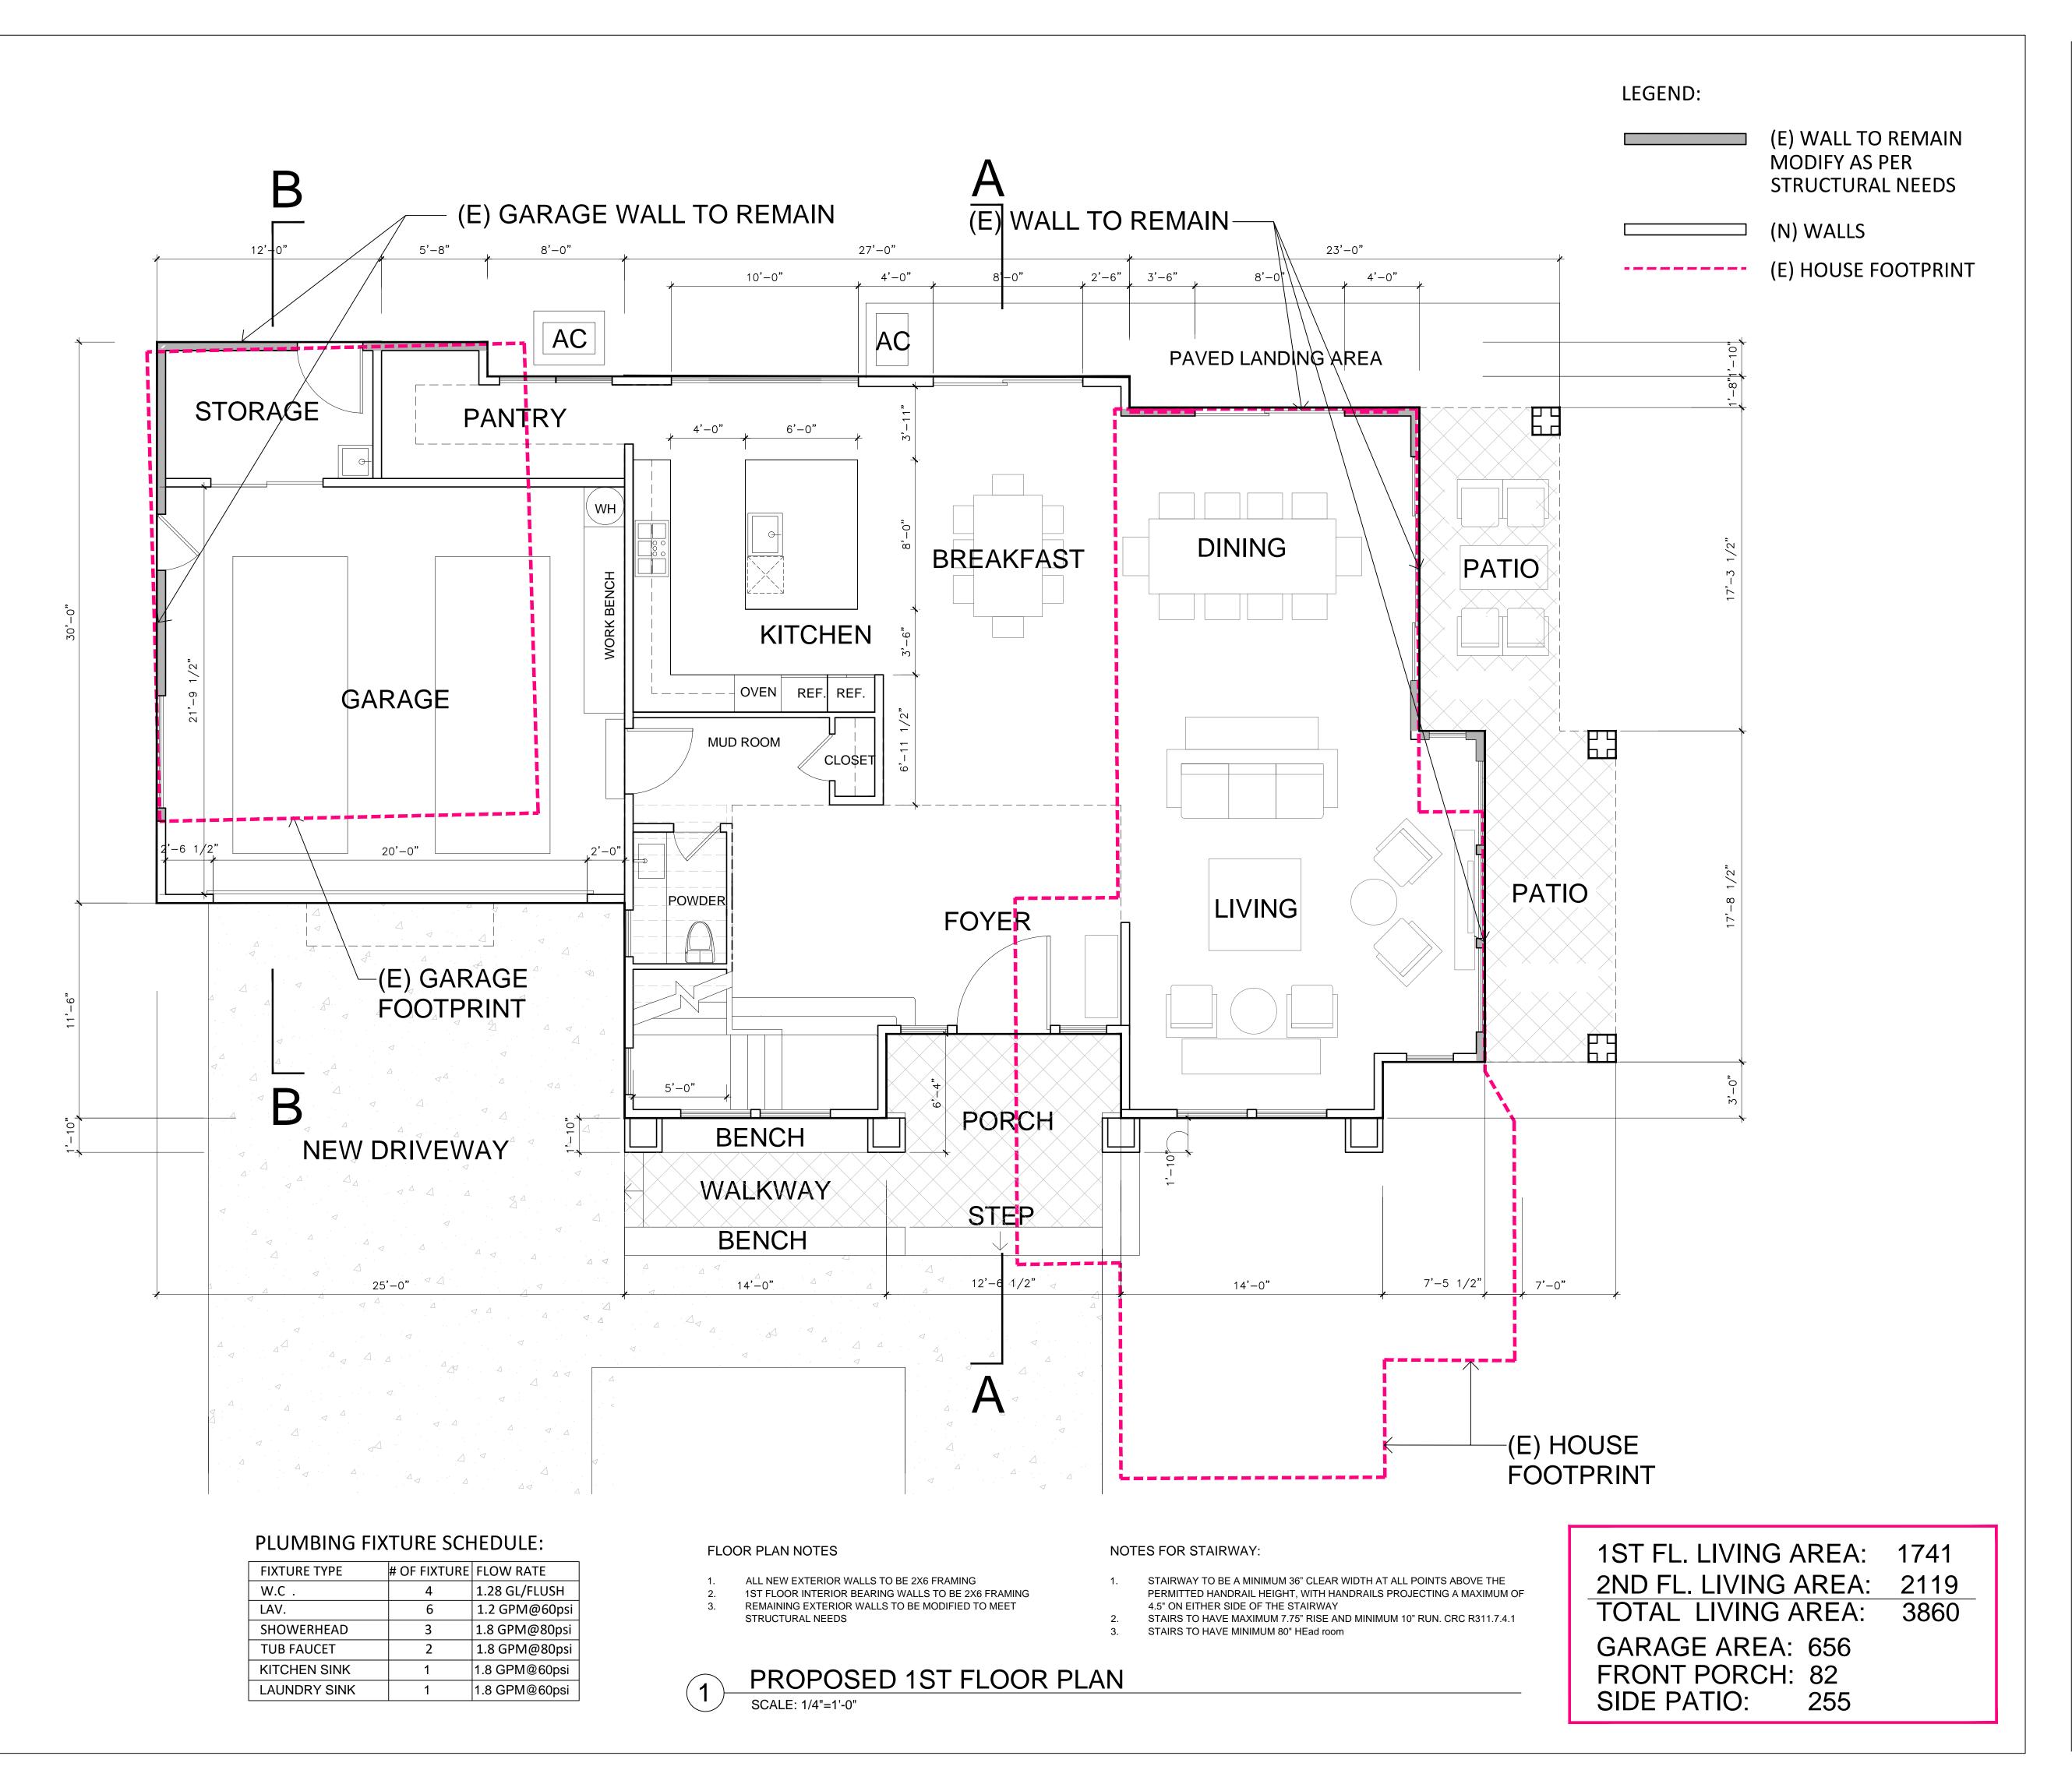



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ARCHITEC INC.



REVISIONS

PROJECT NAME


1524 MANNING LN., ALAMO, CA A HOME EXPANSION PROJECT

DATE: 06/11/2024 SCALE: AS SHOWN SHEET NAME

1ST FLOOR PLAN

SHEET NO.

A-2.1

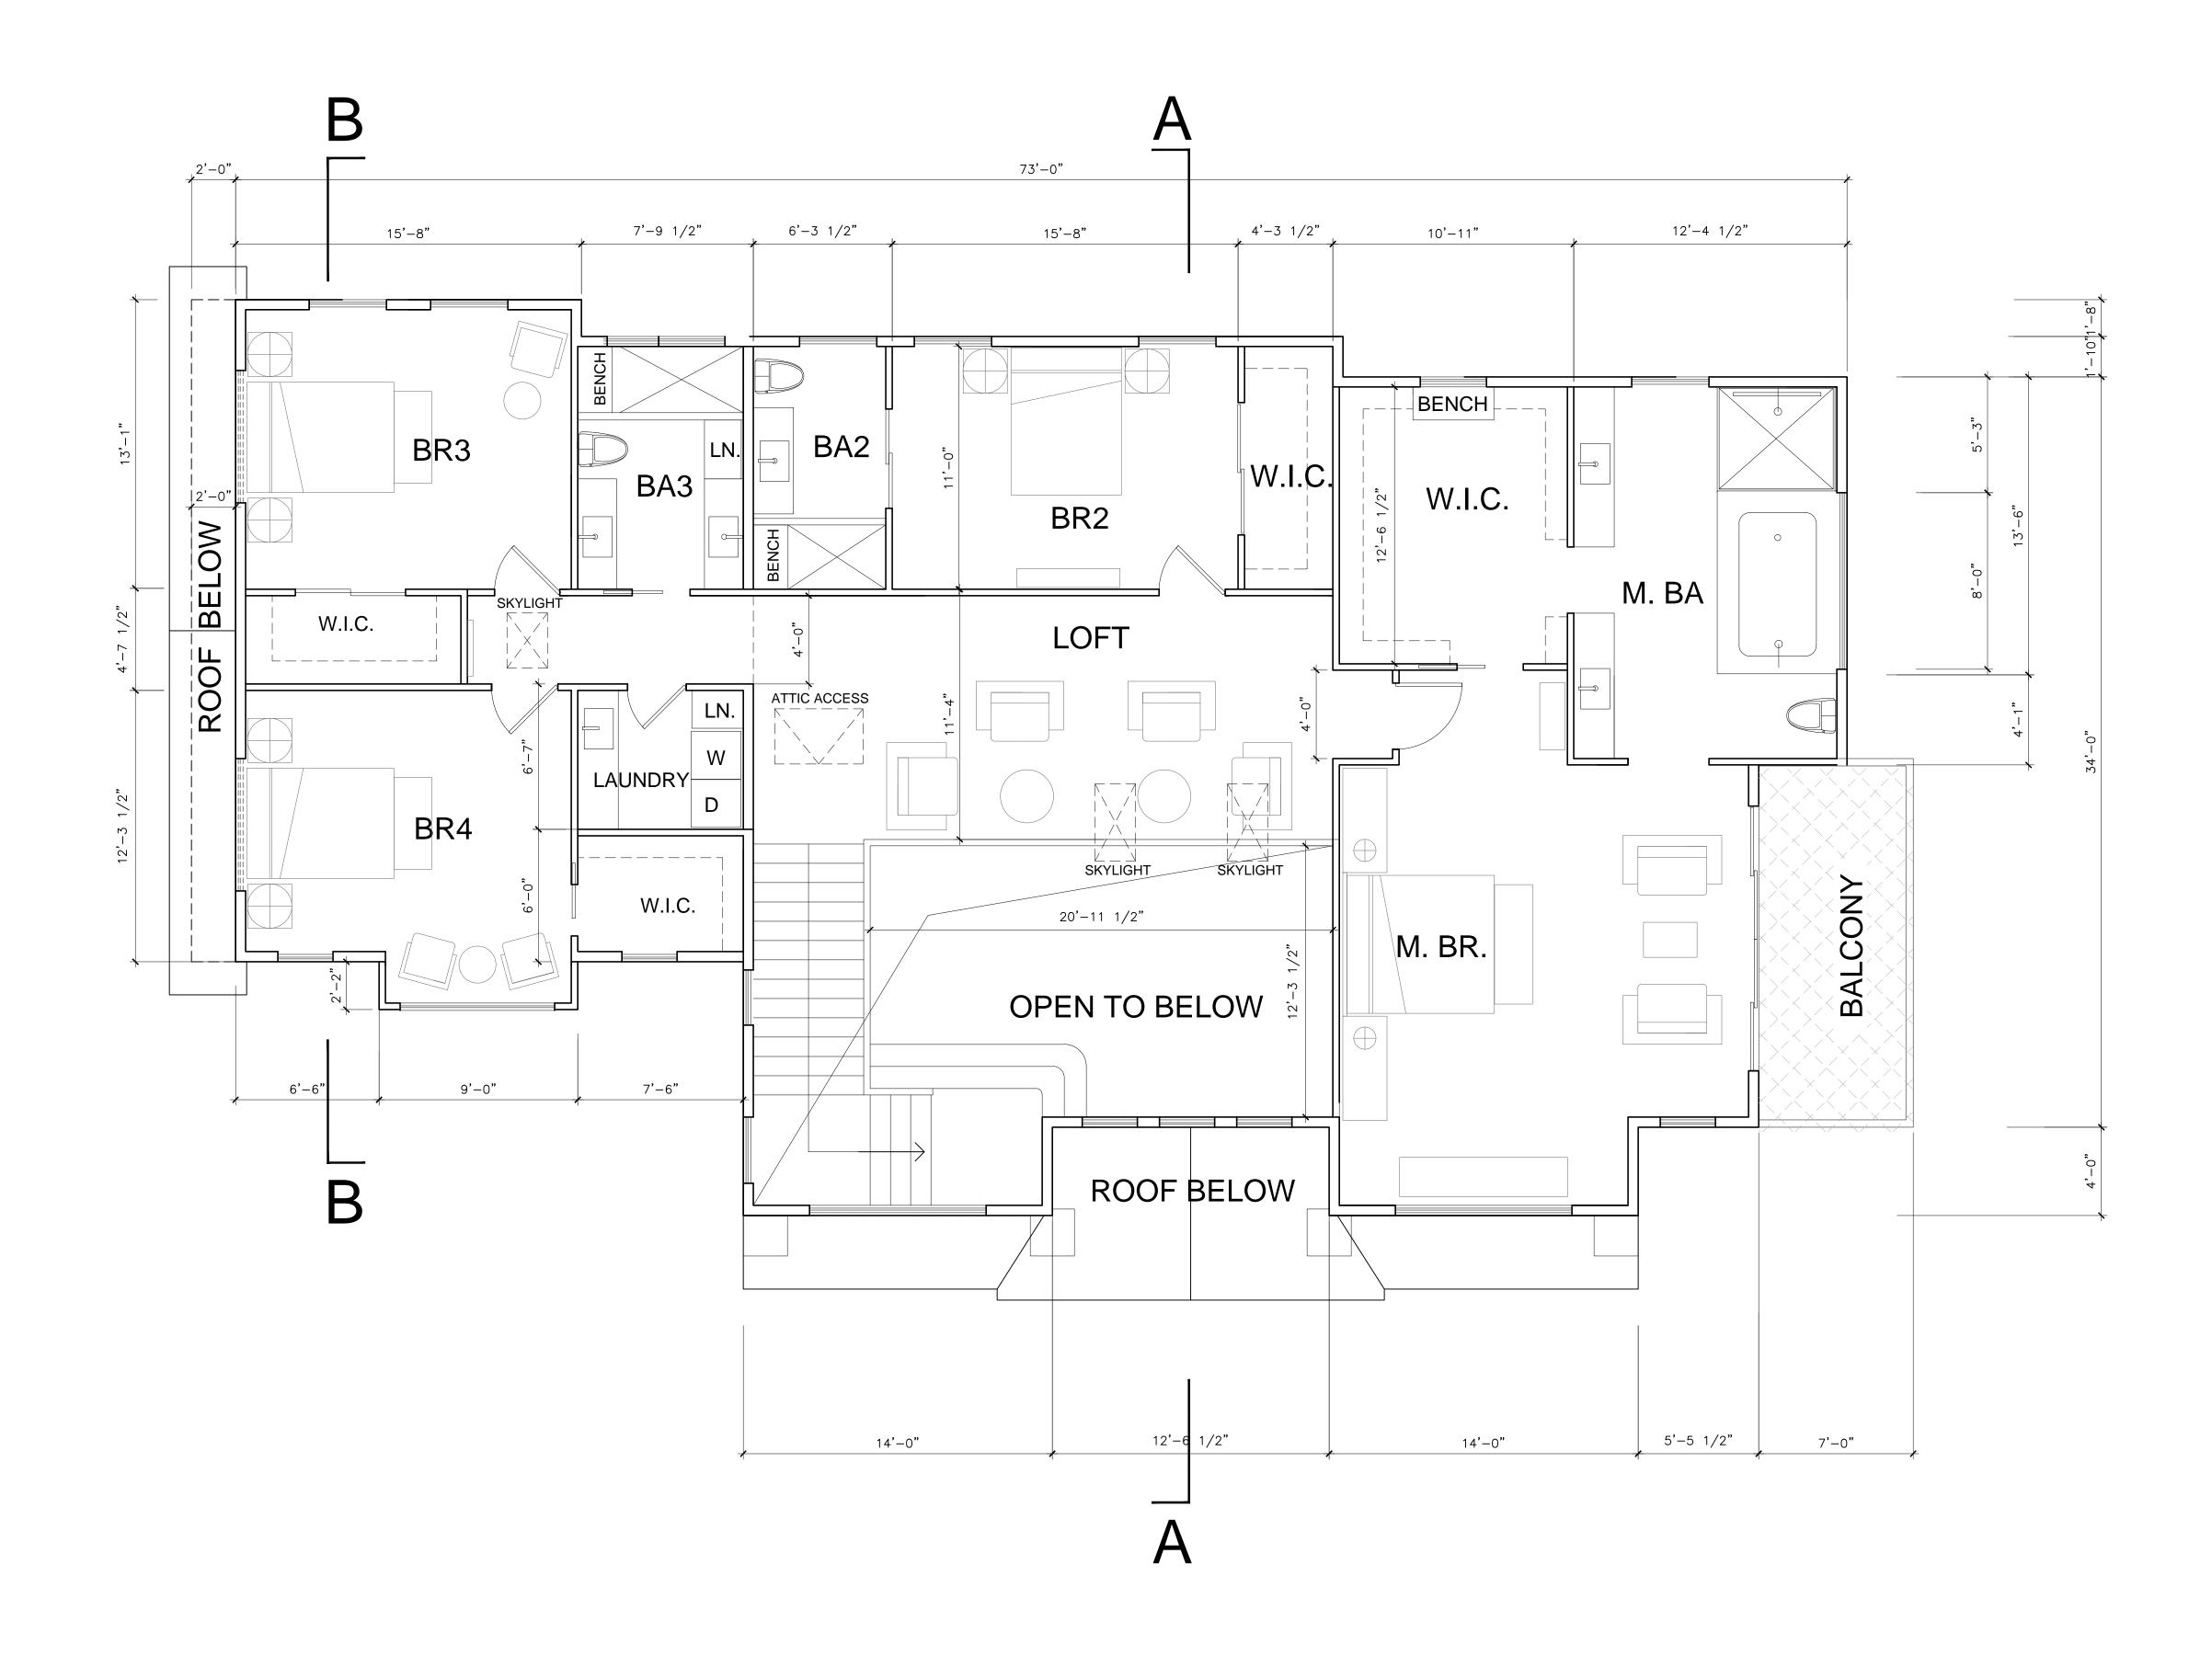



SH SINGLE HUNG
DH DOUBLE HUNG
SLD SLIDING DOOR
SLW SLIDING WINDOW
AWN AWNING WINDOW
FX FIXED WINDOW
PKD POCKED DOOR
CSM CASEMENT WINDOW
COM COMBINATION WINDOWS
STK STACKED WINDOW
3080 3'-0"X8'-0"
2680 2'-6"X8'-0"
OPT. OPTIONAL
TEMPERED GLASS

1 PROPOSED 2ND FLOOR PLAN
SCALE: 1/4"=1'-0"

LIVING AREA: 2119 SF

ARCHITECTURE INC.



REVISIONS

PROJECT NAME

1524 MANNING LN., ALAMO, CA A HOME EXPANSION PROJECT

A-2.2

2ND FLOOR PLAN

DATE: 06/11/2024 SCALE: AS SHOWN SHEET NAME

SHEET NO.

#### ROOF PLAN NOTES

ROOF PLATE HEIGHTS ARE REFERENCED FROM TOP OF SUB FLOOR AT ENTRY, U.N.O.

CLASS A ROOF COVERING SHALL BE

MANUFACTURER: OWENS CORNING ROOFING OR EQUAL QUALITY PRODUCT

COMP. SHINGLE ROOFING FOR SLOPED ROOF

COLOR:

GUTTERS ON ALL ELEVATIONS SHALL BE PROFILED ALUMINUM GUTTERS BY AMERIMAX OR

ROOF PITCH SHALL BE AS NOTED ON ROOF PLAN

OVERHANG DIMENSIONS SHALL BE AS NOTED ON ROOF PLAN

DASHED LINES INDICATE WALL(STRUCTURE) BELOW.

LOCATE GUTTERS AND DOWNSPOUTS AS SHOWN. NOTE: LOCATE DOWNSPOUTS MIN. 8" OFF CORNER WHERE POSSIBLE (U.O.N.)

ALL ROOF DRAINAGE SHALL BE PIPED TO STREET OR APPROVED DRAINAGE FACILITY.

ALL PLUMBING VENTS SHALL BE COMBINED INTO A MINIMUM AMOUNT OF ROOF PENETRATIONS. ALL ROOF PENETRATIONS SHALL OCCUR TO THE REAR OF THE MAIN RIDGE (WHERE POSSIBLE) SEE DETAIL 11 /A-4.1


ATTIC VENTILATION SHALL BE PROVIDED PER SECTION 1505.3 OF THE UBC. (SEE CALCULATIONS, THIS SHEET)

LOCATE UPPER AND LOWER ROOF VENTS AS SHOWN ON PLAN.

UNDERLAYMENT FOR ASPHALT SHINGLES SHALL COMPLY WITH ASTM D226 TYPE I; ASTM D4869 TYPE I,II,III OR IV; ASTM D6757, AND SHALL BEAR A LABEL INDICATING COMPLIANCE TO THE STANDARD DESIGNATION. (R905.1.1)

FLASH ALL ROOF VALLEYS (INSTALL FLASHING OVER 30# FELT)


ALL FLASHING SHALL BE 26 GAUGE G.S.M.

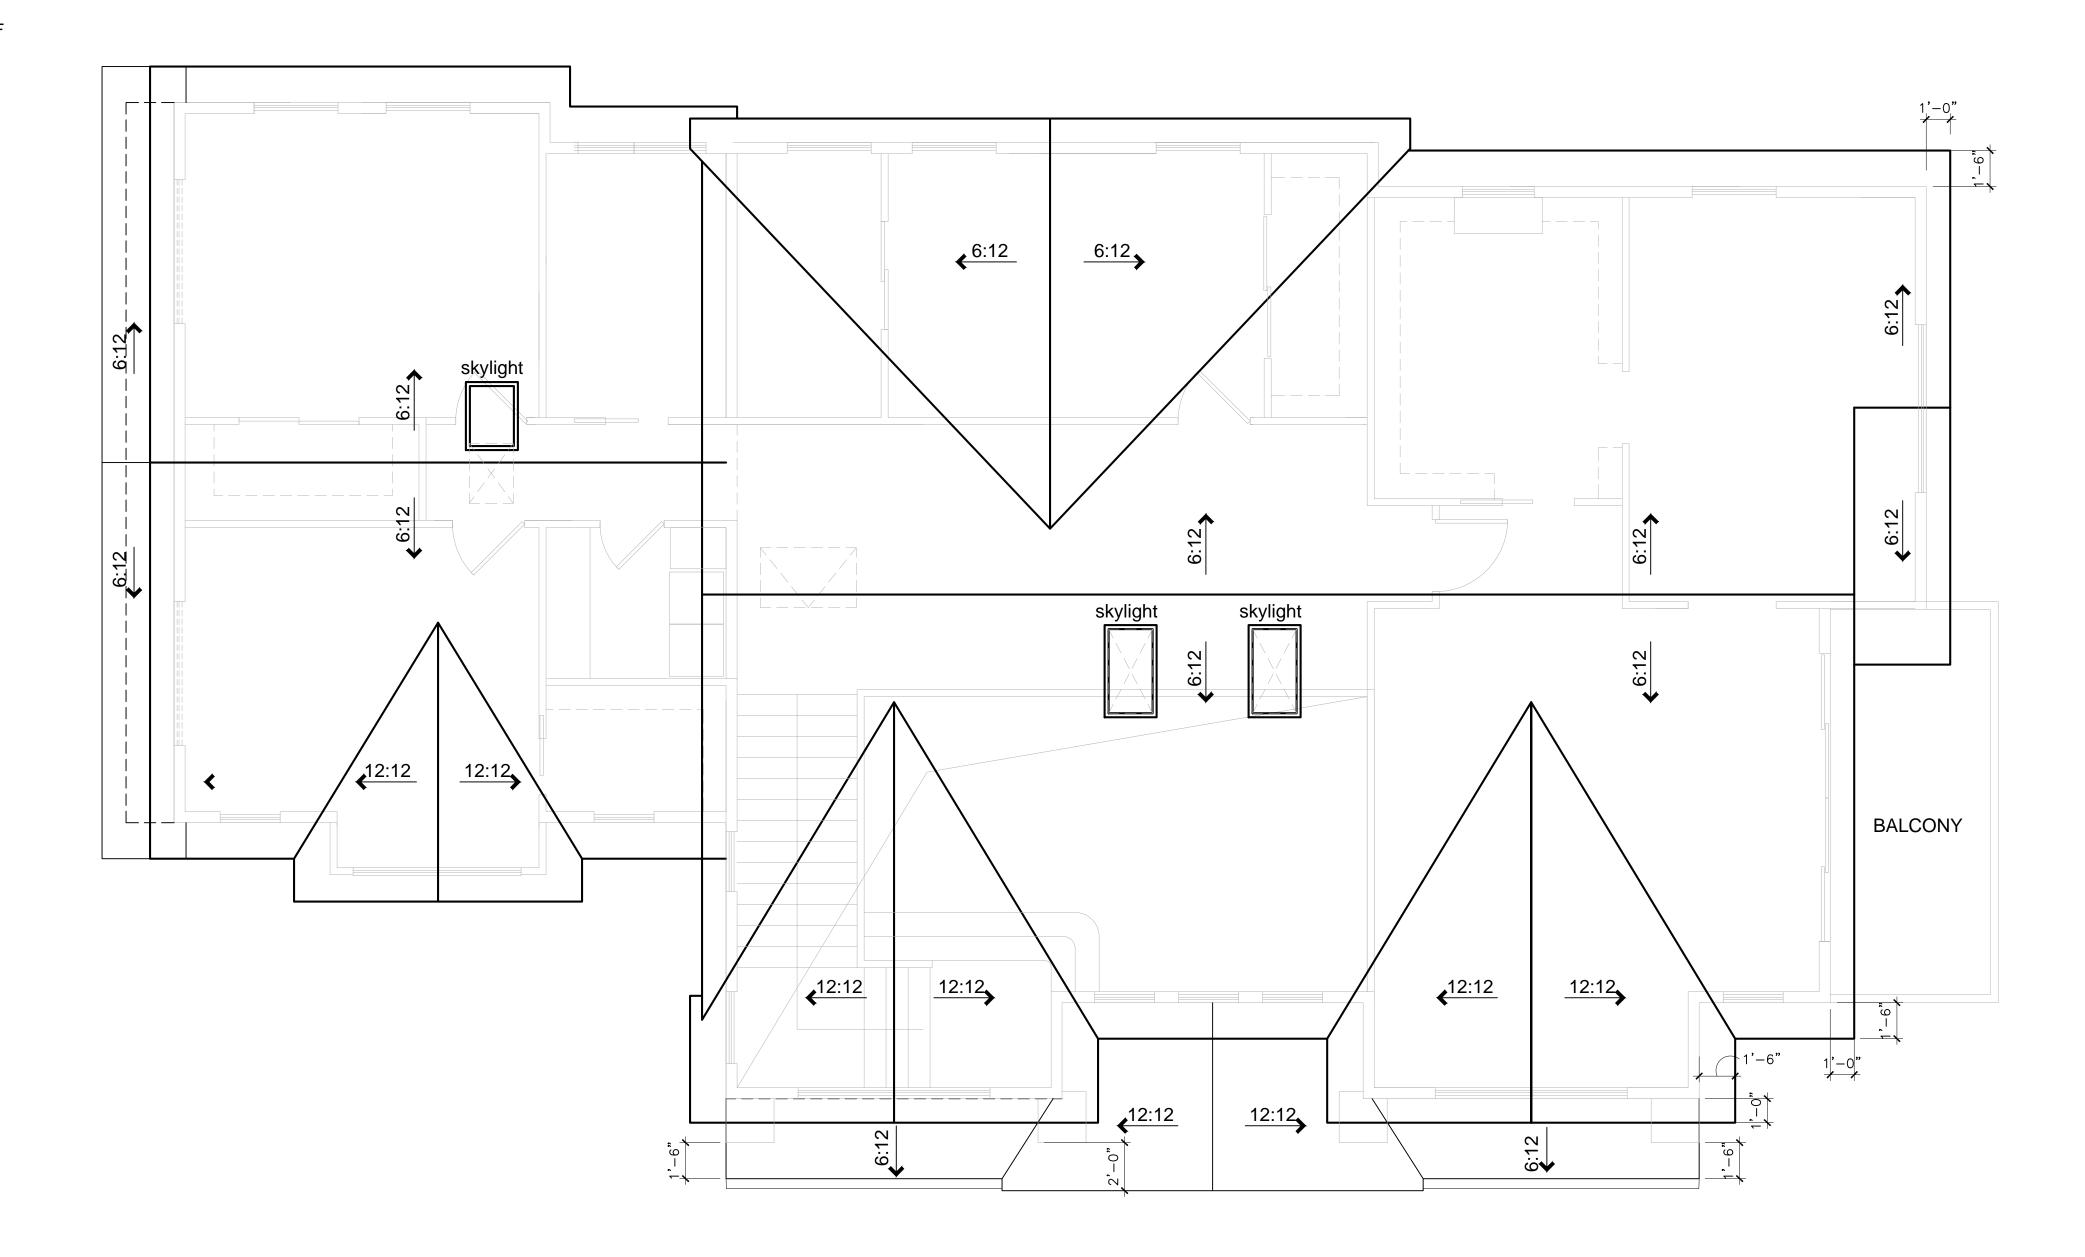





HITECTURE

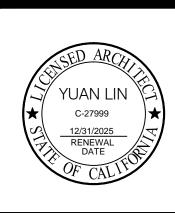

REVISIONS


PROJECT NAME

1524 MANNING LN., ALAMO, CA A HOME EXPANSION PROJECT

DATE: 06/11/2024 SCALE: AS SHOWN SHEET NAME ROOF PLAN

SHEET NO.

A-2.3

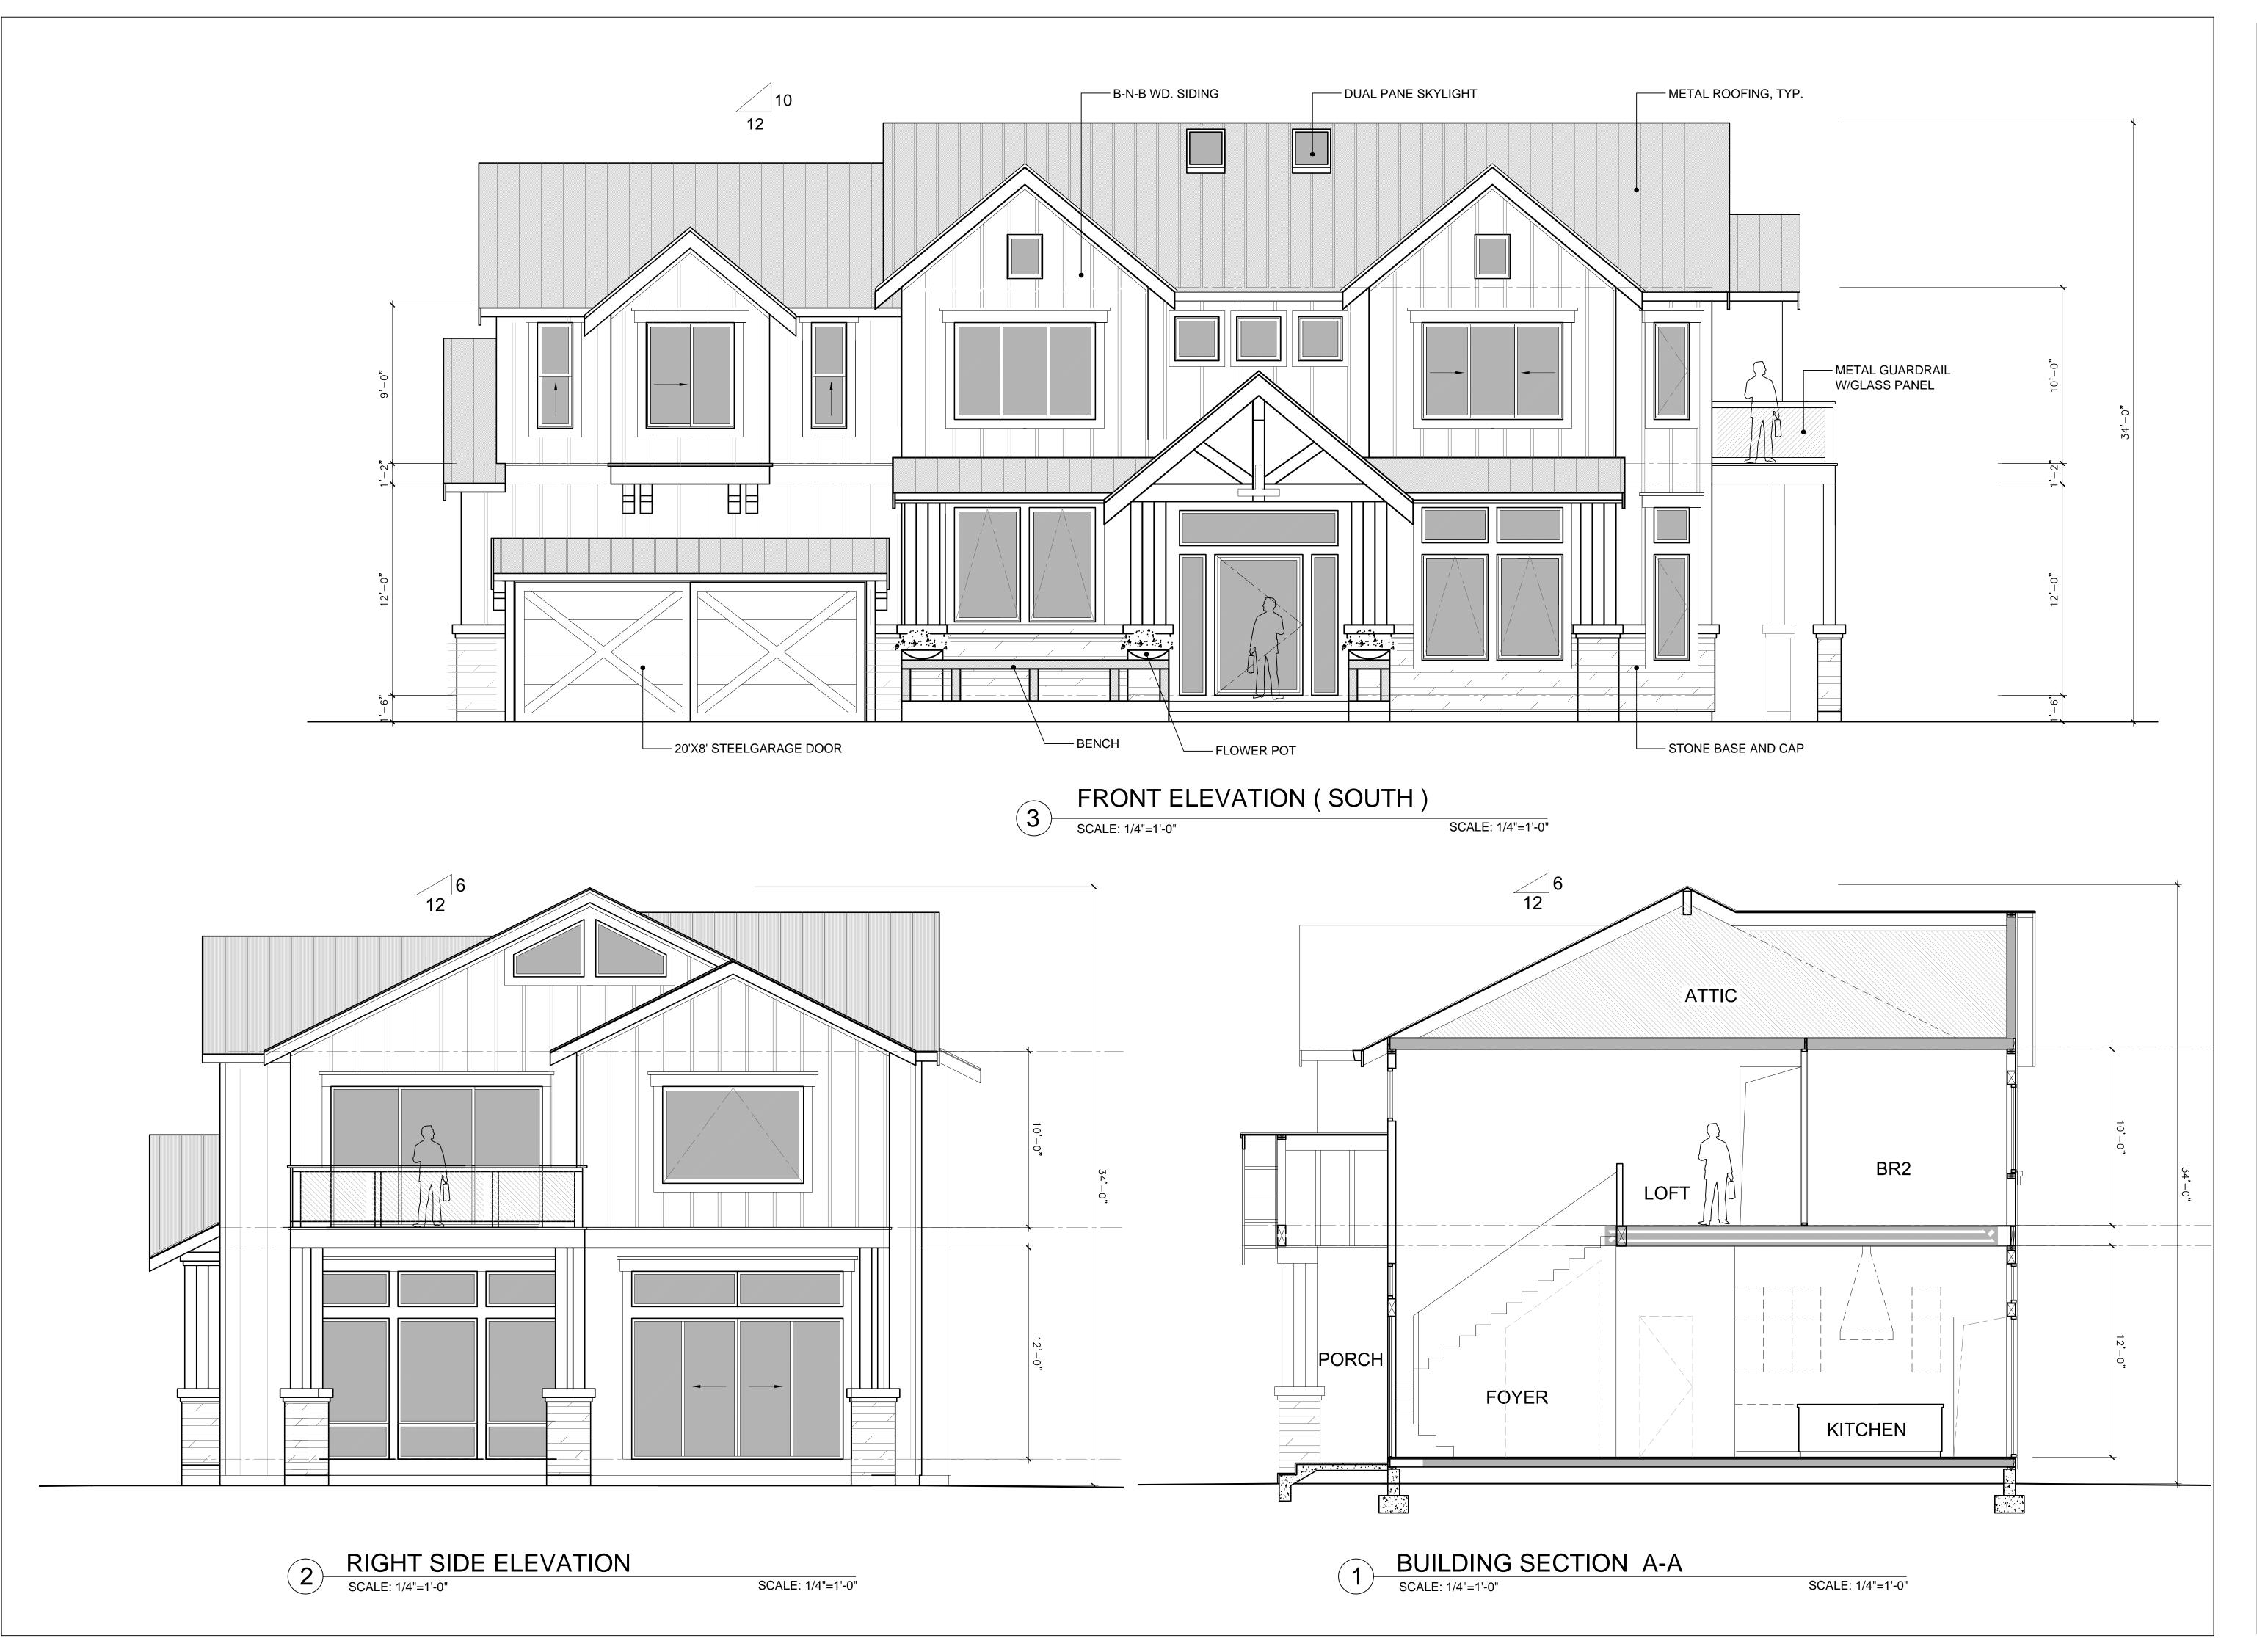



LINA ARCHITECTURE INC.



REVISIONS

PROJECT NAME

1524 MANNING LN., ALAMO, CA A HOME EXPANSION PROJECT

DATE: 06/11/2024
SCALE: AS SHOWN
SHEET NAME

BUILDING
ELEVATIONS
& SECTION

SHEET NO.

A-3.1



# REAR ELEVATION








REVISIONS

PROJECT NAME

1524 MANNING LN., ALAMO, CA A HOME EXPANSION PROJECT OWNER: Mr. & Mrs. Javaid Noorzad

A-3.2

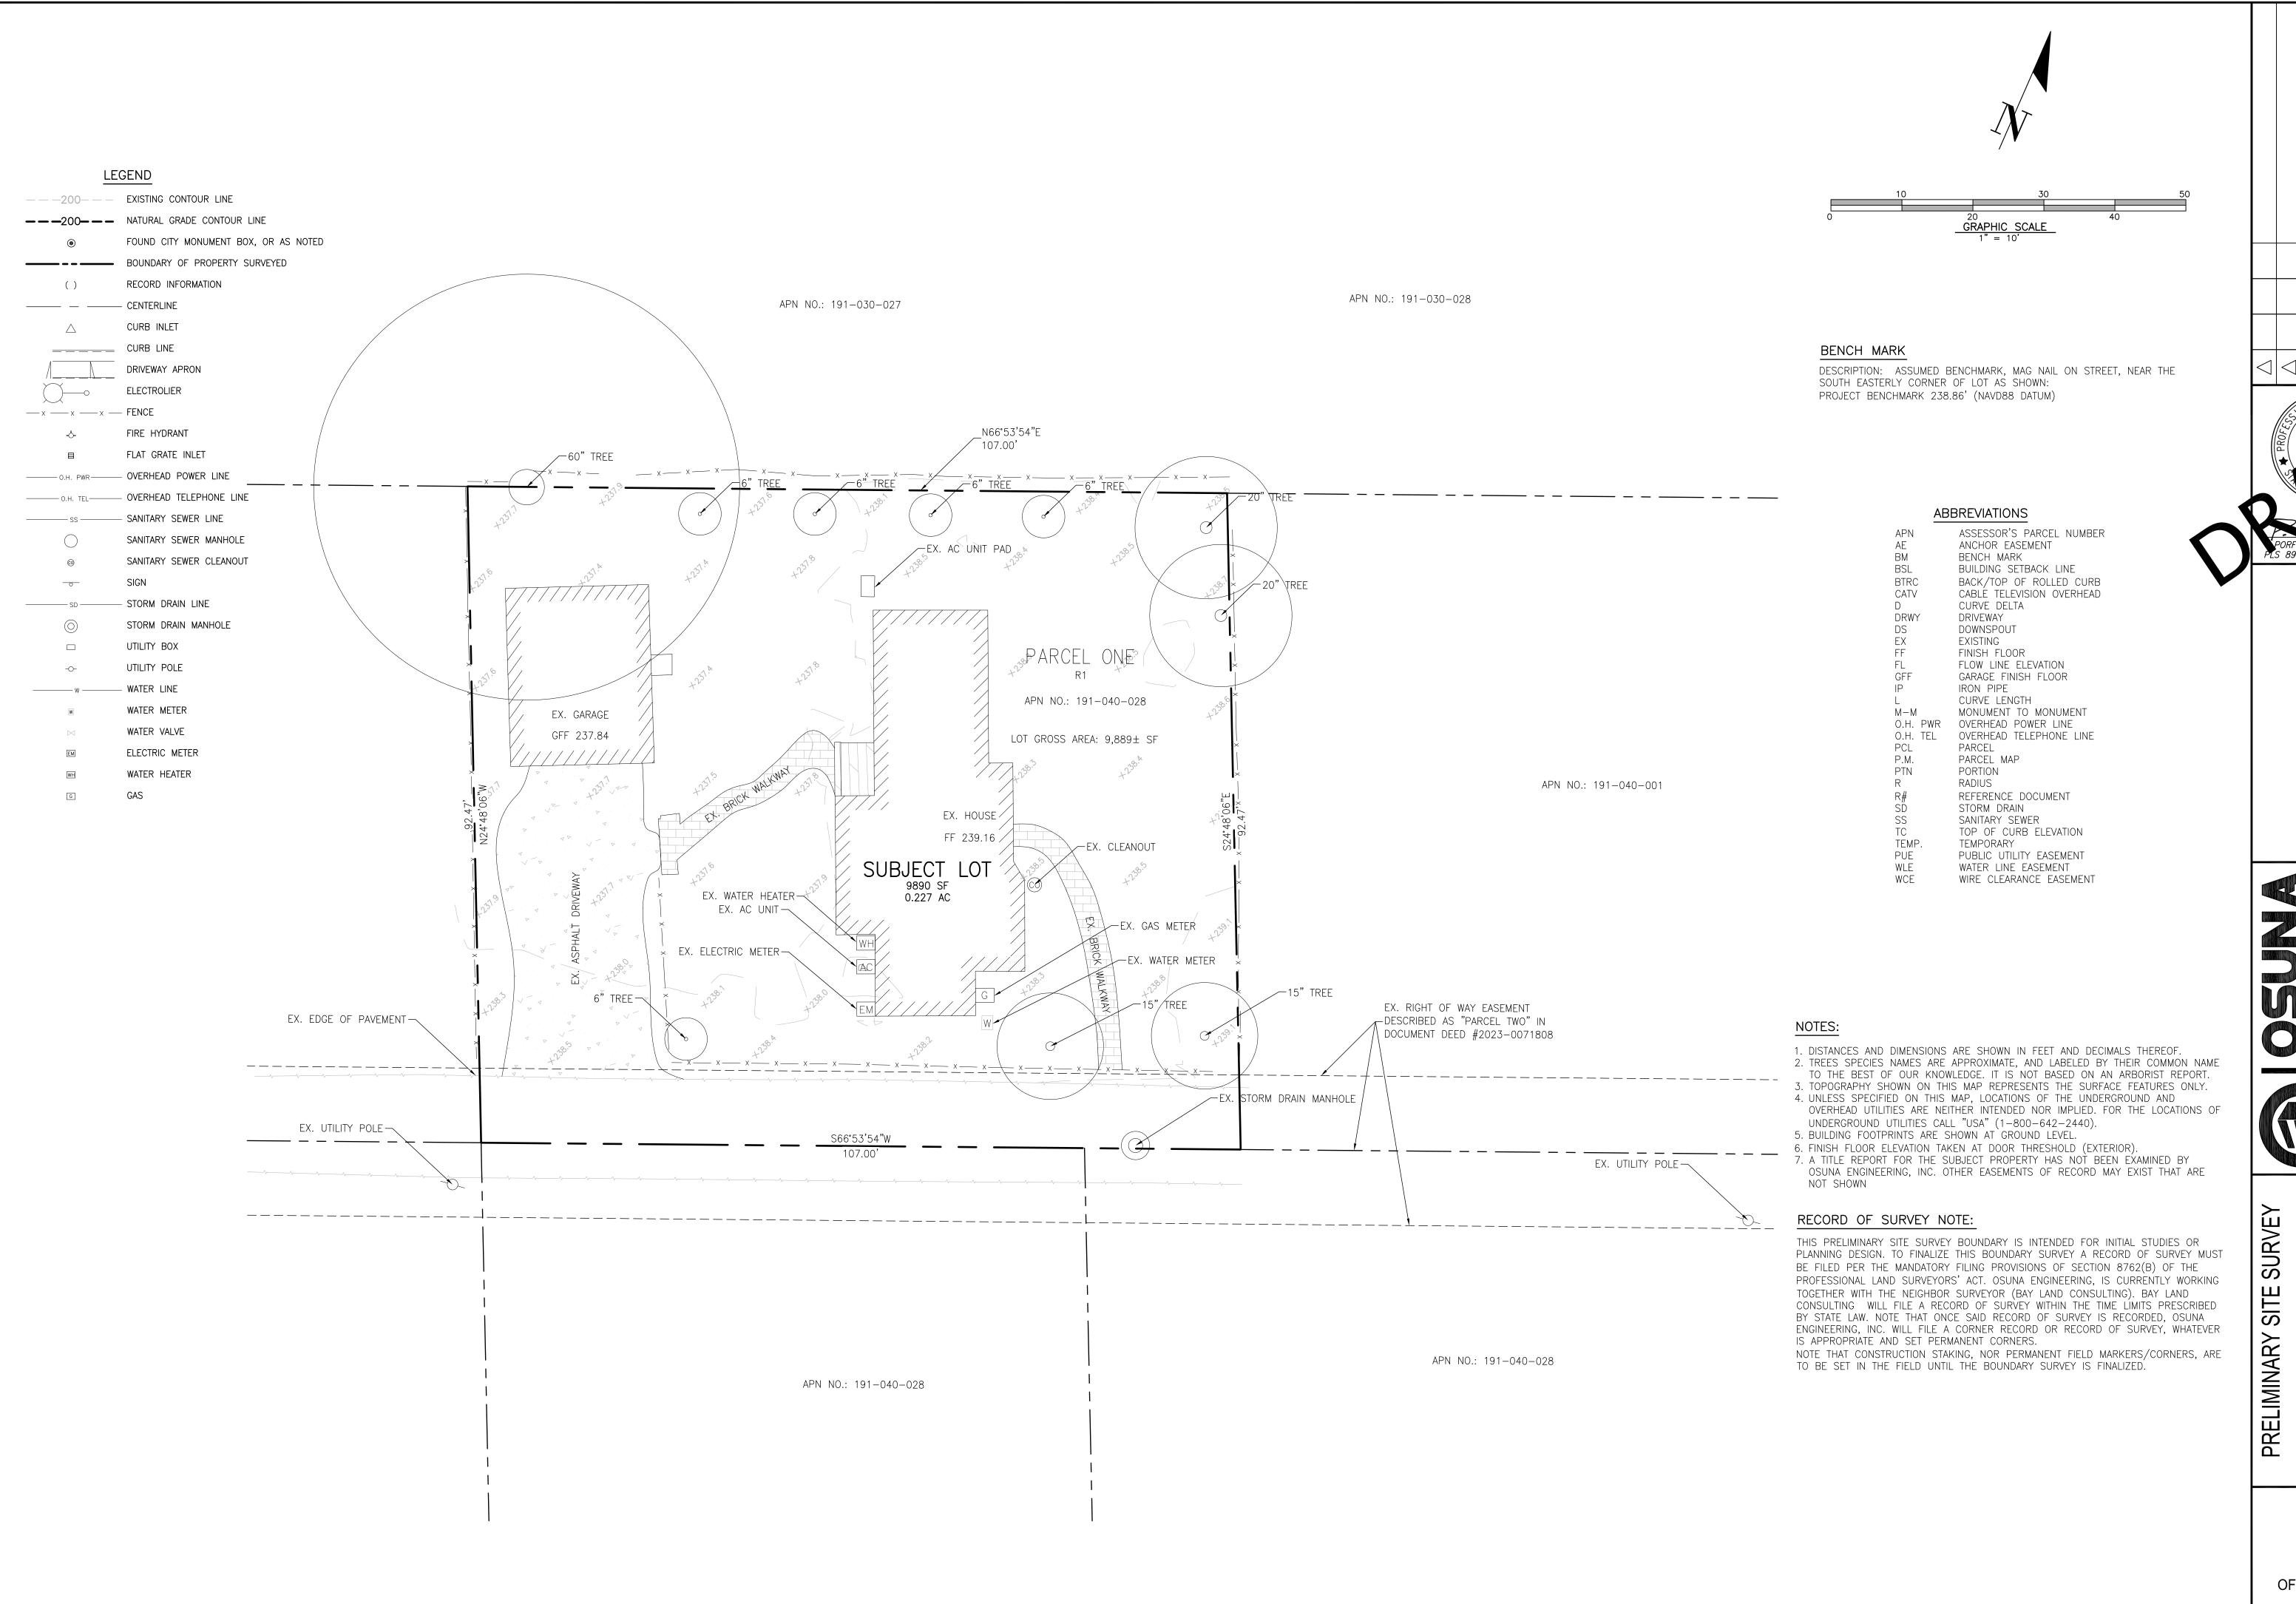

SONAT DATE REVISIONS

OSCAR OSUM No. 821 Exp. 9-30 PORFIRIO OSCAR OSUNA PLS 8921 EXP. 9-30-24

NGINEERS & LAND SURVEYORS

ENGINI

Planning|Surconsulting civil engineers & Santa teresa bivo 206

CONSULTING CIVED 6920 SANTA TERESA E SAN JOSE, CA 95119

1524 MANNING LANE APN.: 191-040-028-0

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SHEET

OF 1 SHEETS