
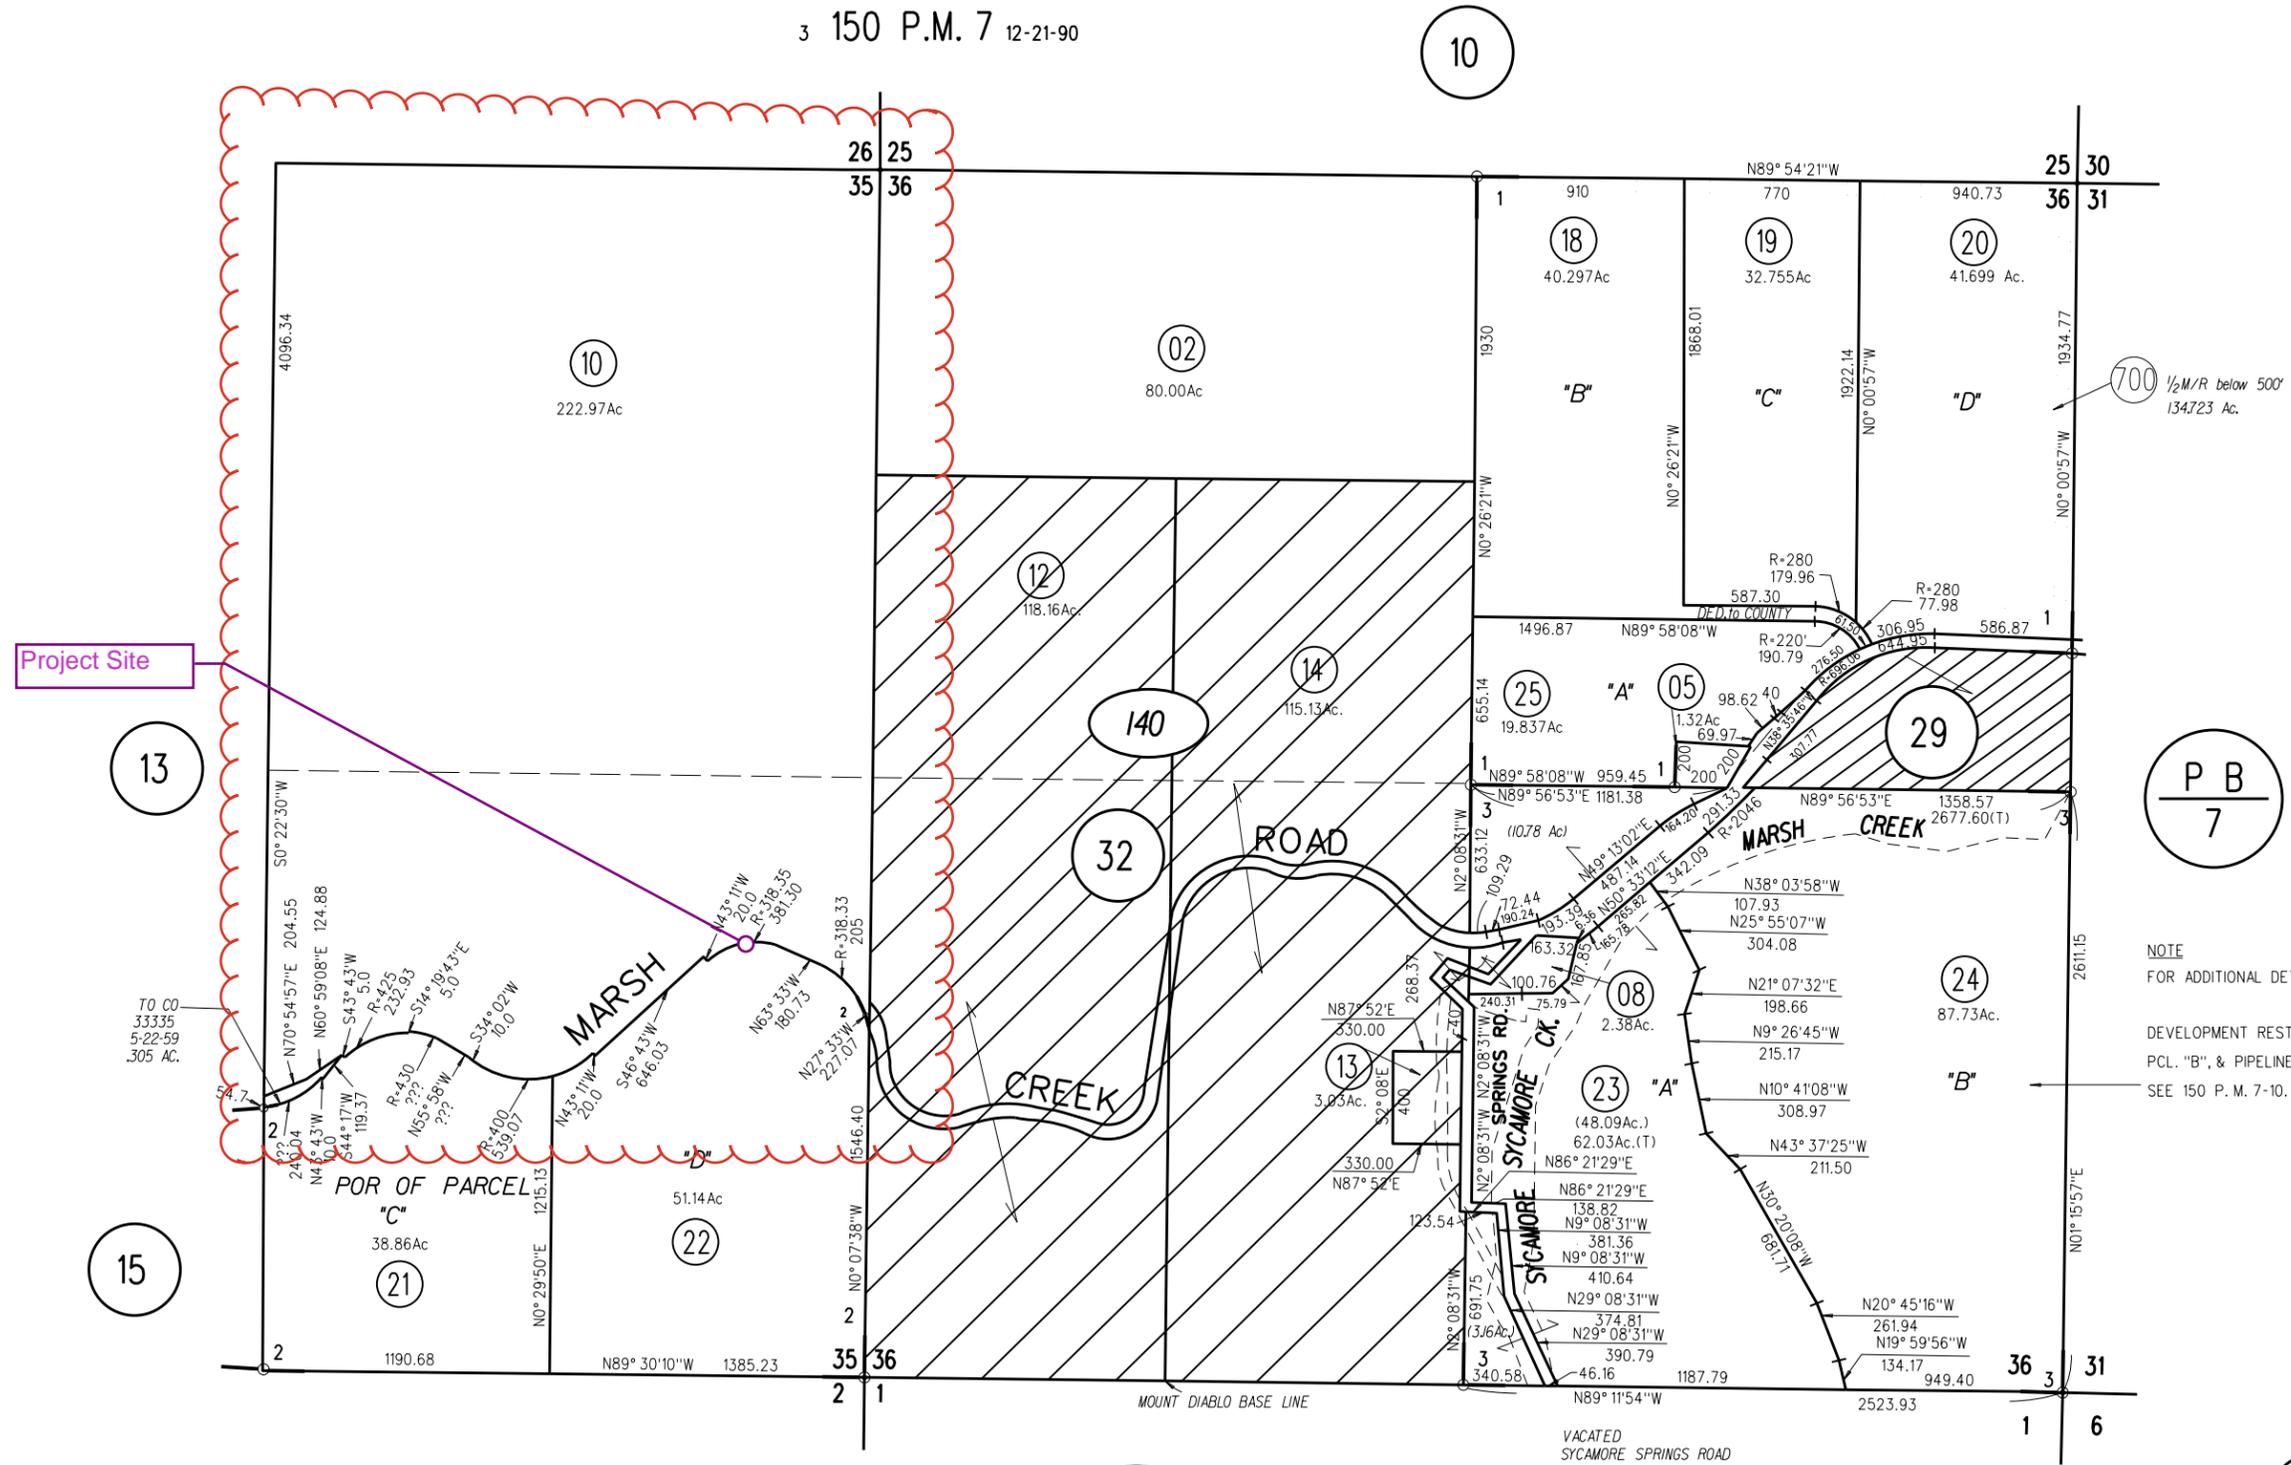


E 1/2 SEC 35 & SEC 36 T1N R1E MDBM

- 1- 37P.M.18 & 19 3-14-75
- 2- 89P.M.22 9-17-80
- 3- 150 P.M. 7 12-21-90

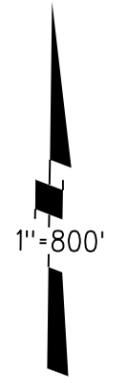

Project Site

P B / 7


NOTE
FOR ADDITIONAL DETAILS OF
DEVELOPMENT RESTRICTIONS OF
PCL. "B", & PIPELINE ESMTS.,
SEE 150 P. M. 7-10.

NOTE: THIS MAP WAS PREPARED FOR ASSESSMENT PURPOSES ONLY. NO LIABILITY IS ASSUMED FOR THE ACCURACY OF THE INFORMATION DELINEATED HEREON. ASSESSOR'S PARCELS MAY NOT COMPLY WITH LOCAL LOT SPLIT OR BUILDING SITE ORDINANCES.

P B / 80

140 25 / 10/16/14

General Plan Designation - AL

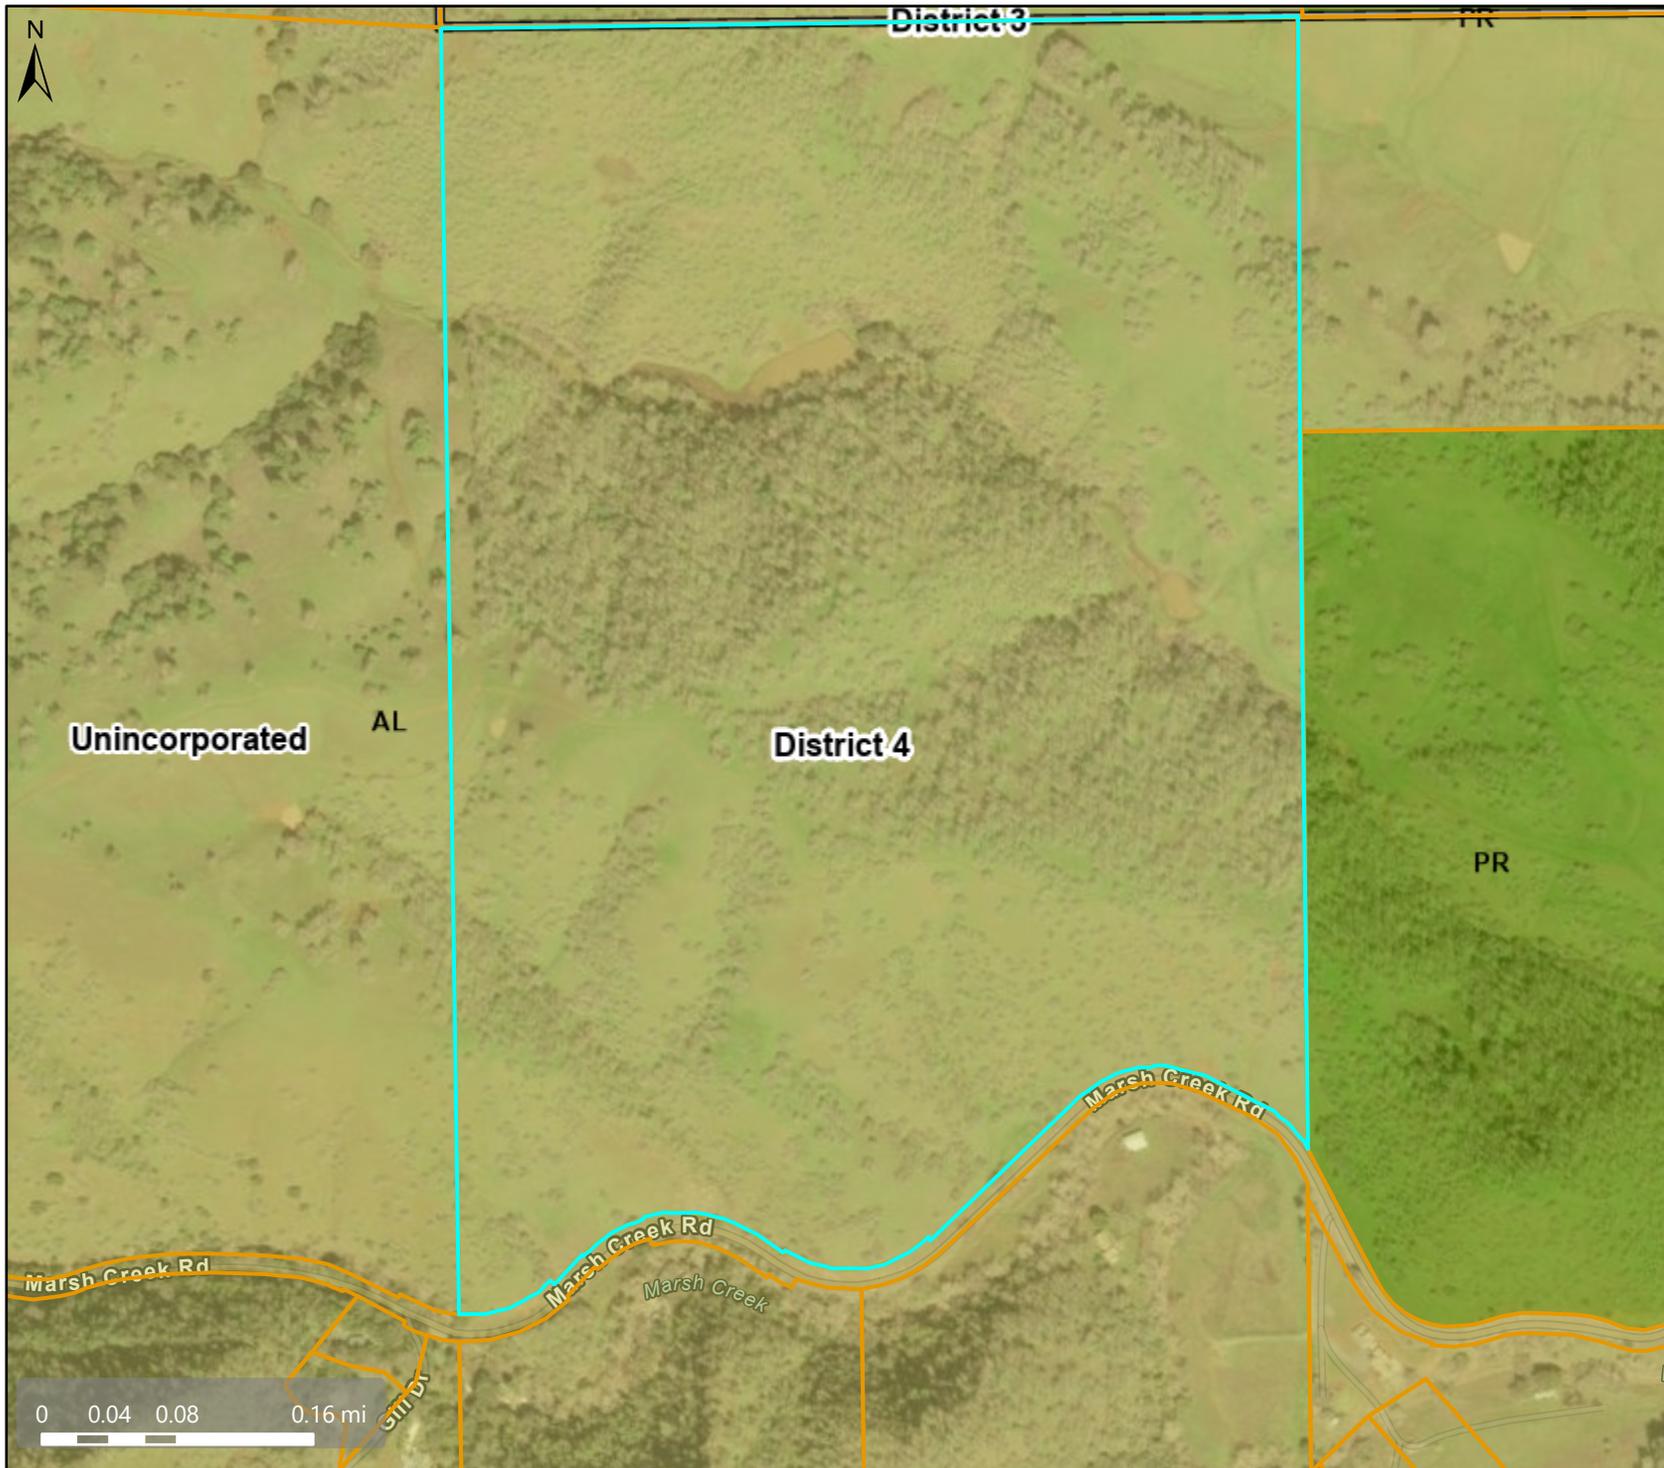

Map Legend

- Assessment Parcels
- Planning Layers (DCD)
- General Plan
 - PR (Park and Recreation)
 - AL (Agricultural Lands) (1 du/10 ac) (1 du/20 ac in DPZ)
 - Unincorporated Board of Supervisors' Districts

This map is a user generated, static output from an internet mapping application and is intended for reference use only. Data layers that appear on this map may or may not be accurate, current, or otherwise reliable. THIS MAP IS NOT TO BE USED FOR NAVIGATION. CCMMap is maintained by Contra Costa County Department of Information Technology, County GIS. Data layers contained within the CCMMap application are provided by various Contra Costa County Departments. Please direct all data inquiries to the appropriate department.

Spatial Reference
PCS: WGS 1984 Web Mercator Auxiliary Sphere
Datum: WGS 1984

Zoning District - A-2




Map Legend

- Assessment Parcels
- Planning Layers (DCD)
- Zoning
- ZONE_OVER
 - A-2 (General Agriculture)
 - A-4 (Agricultural Preserve)
 - Unincorporated
- Board of Supervisors' Districts

This map is a user generated, static output from an internet mapping application and is intended for reference use only. Data layers that appear on this map may or may not be accurate, current, or otherwise reliable. THIS MAP IS NOT TO BE USED FOR NAVIGATION. CCMMap is maintained by Contra Costa County Department of Information Technology, County GIS. Data layers contained within the CCMMap application are provided by various Contra Costa County Departments. Please direct all data inquiries to the appropriate department.

Spatial Reference
PCS: WGS 1984 Web Mercator Auxiliary Sphere
Datum: WGS 1984

Aerial View

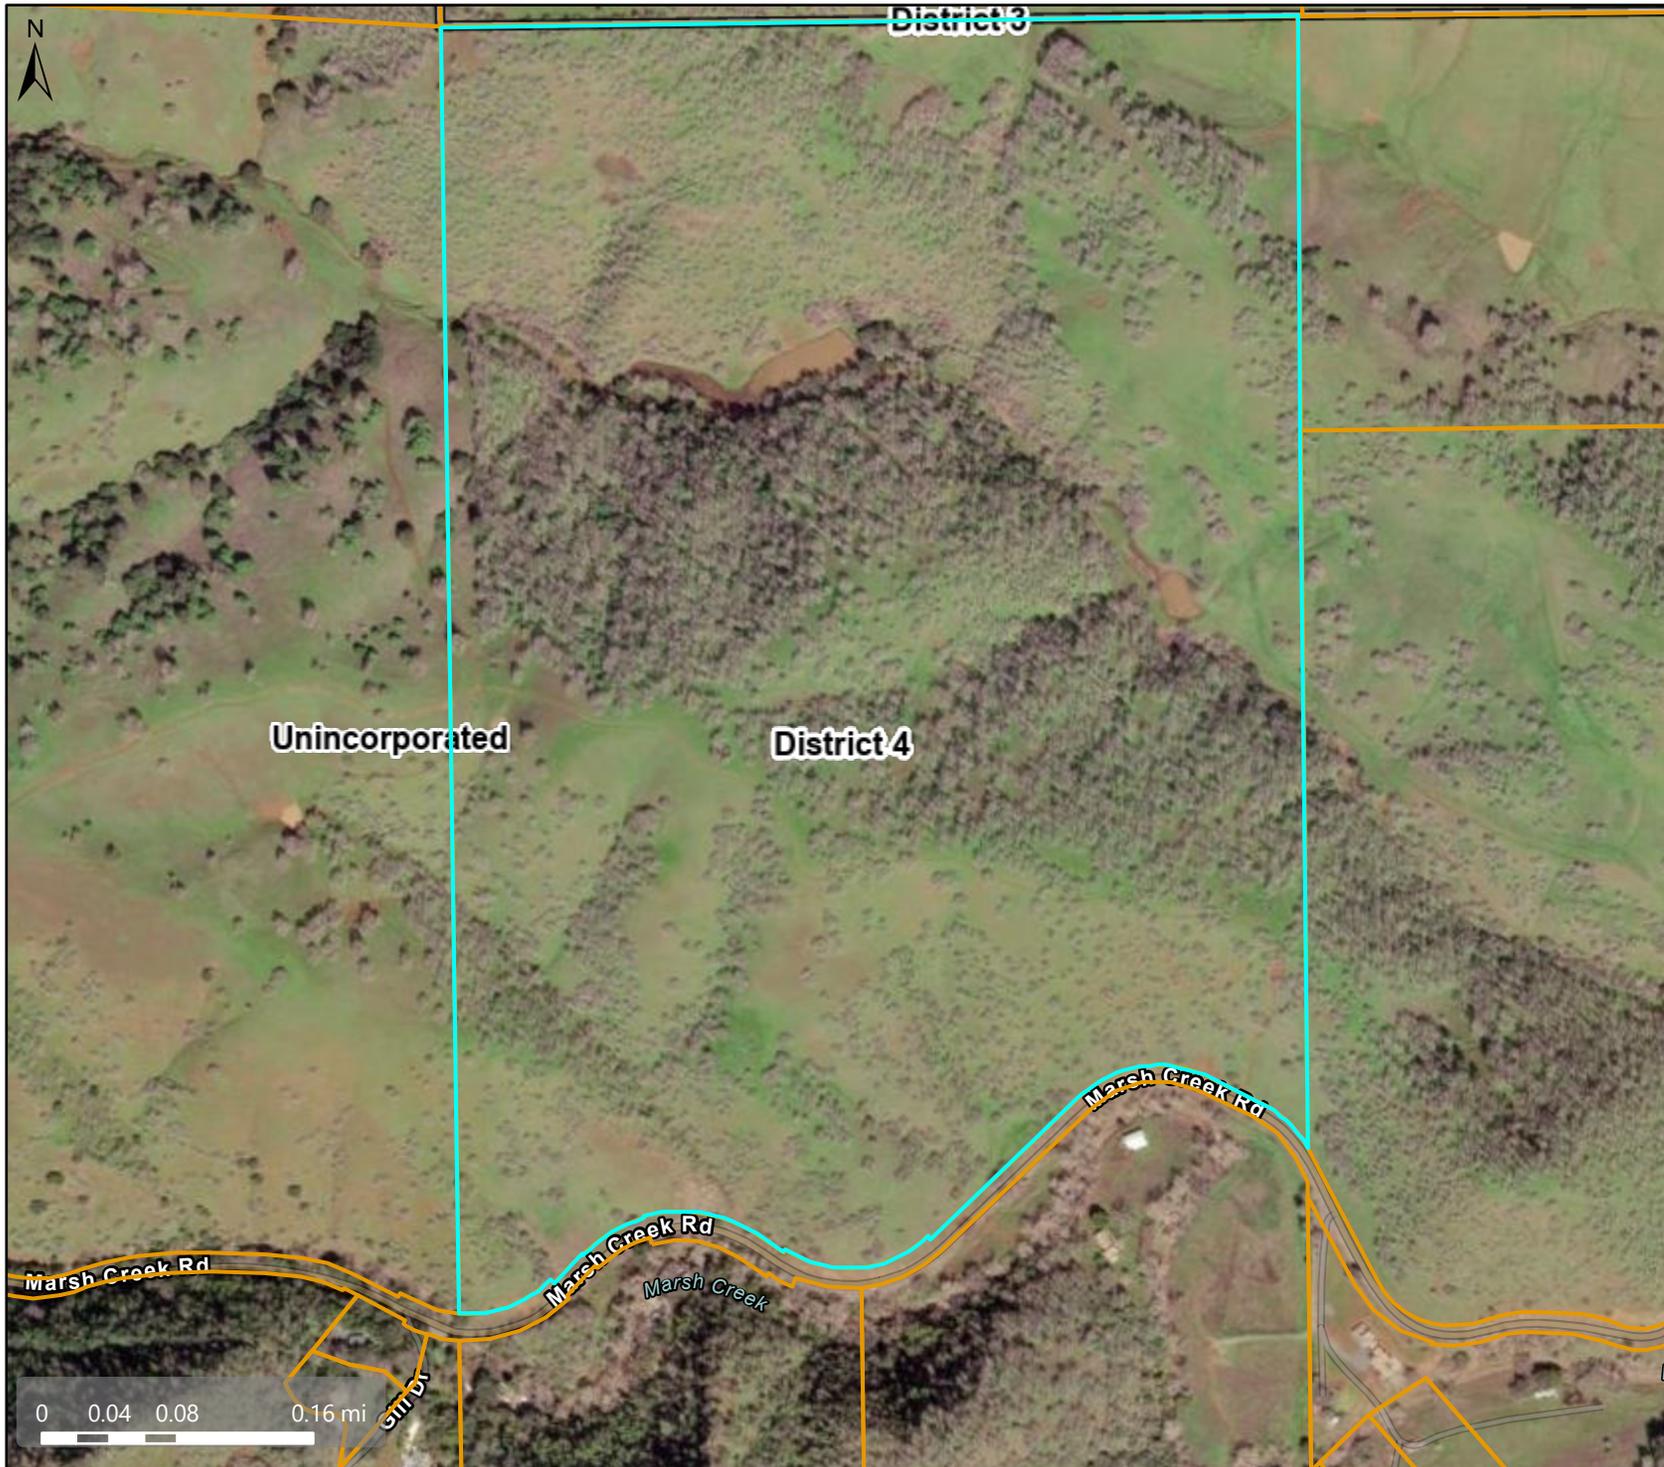


Map Legend

- Assessment Parcels
- Planning Layers (DCD)
 - Unincorporated
 - Board of Supervisors' Districts


This map is a user generated, static output from an internet mapping application and is intended for reference use only. Data layers that appear on this map may or may not be accurate, current, or otherwise reliable. THIS MAP IS NOT TO BE USED FOR NAVIGATION. CCMMap is maintained by Contra Costa County Department of Information Technology, County GIS. Data layers contained within the CCMMap application are provided by various Contra Costa County Departments. Please direct all data inquires to the appropriate department.

Spatial Reference
PCS: WGS 1984 Web Mercator Auxiliary Sphere
Datum: WGS 1984

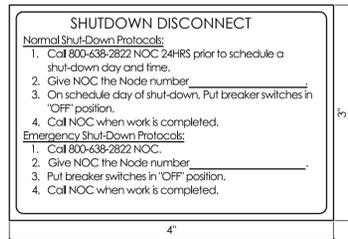

- NOTES:**
- SIGN PROVIDED BY GC, MOUNTED TO OUTSIDE OF DISCONNECT COVER
 - CONTRACTOR TO NOTE MARKET ID, SITE ID, SITE NAME

RADIO 8863 (OR APPROVED EQUAL)
 COLOR: GRAY
 DIMENSIONS: 16.5" TALL x 14.8" WIDE x 6.3" DEEP
 WEIGHT: 57.4± LBS

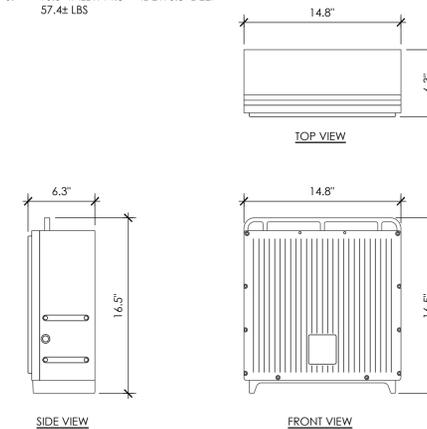

verizon
 VERIZON WIRELESS
 2785 MITCHELL DRIVE, SUITE 9
 WALNUT CREEK, CA
 94598

NextEdge


1355 WINDWARD CONCOURSE,
 SUITES 410
 ALPHARETTA, GA
 30005

SHUTDOWN SIGNAGE SCALE NTS 12




NOT USED SCALE NTS 9

NOT USED SCALE NTS 6

RADIO 8863 SCALE NTS 3

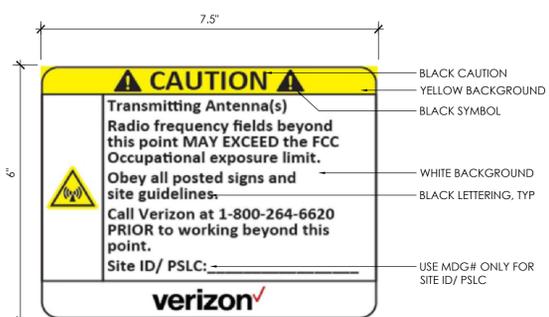

NOTES:
 ALUMINUM SUBSTRATE SIGNS PRINTED WITH UV RESISTANT ECO-SOLVENT INK, REINFORCED WITH UV, CHEMICAL, ABRASION, AND MOISTURE RESISTANT LAMINATE LAYER.
 SUBSTRATE: 0.040" ALUMINUM, WHITE ENAMEL COATED BOTH SIDES
 PRINTING LAYER: 4.0 MIL VINYL WITH PERMANENT ACRYLIC ADHESIVE UV STABLE ECO-SOLVENT INK
 LAMINATE: 2.5 MIL PVC FILM (OPTICALLY CLEAR) SCRATCH RESISTANT CHEMICAL RESISTANT UV RESISTANT
 MOUNTING: 0.20" DIAMETER HOLES IN EACH OF 4 CORNER; OFFSET 025" FROM ADJACENT EDGE.

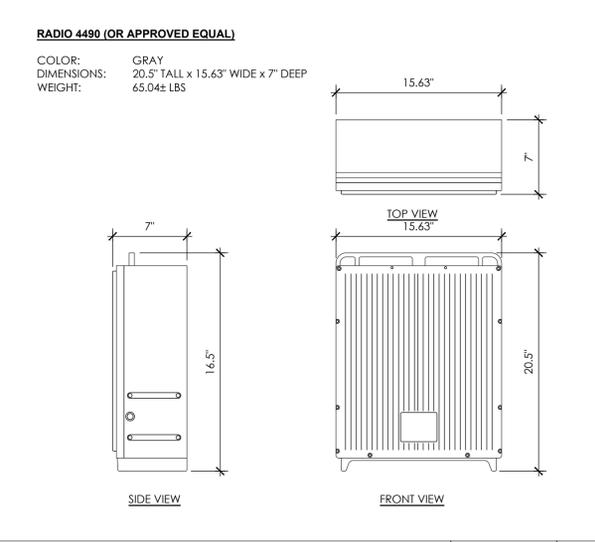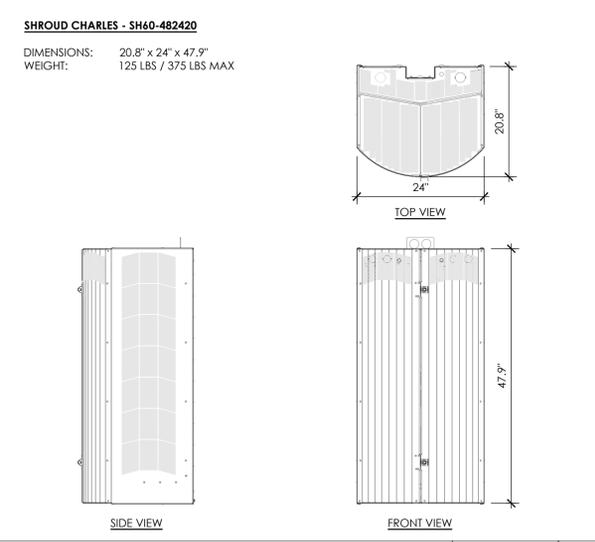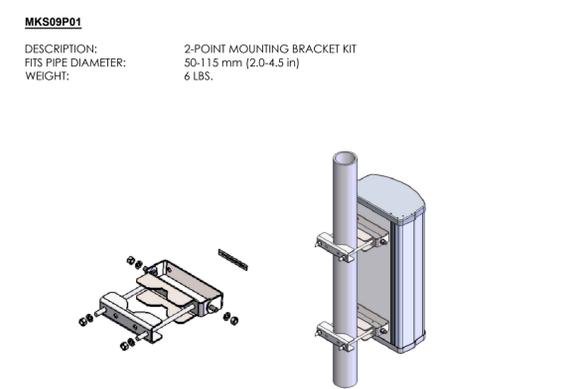

DRAWN BY: JLV
 CHECKED BY: TDL
 APPROVED BY: CW



REV	DATE	DESCRIPTION
0	01/28/25	90% CD
0	02/27/25	100% CD
1	06/30/25	REDESIGN

G.O. 95 RF SIGNAGE SCALE NTS 11

ANTENNA MOUNTING BRACKET SCALE NTS 8

RADIO CABINET SCALE NTS 5

RADIO 4490 SCALE NTS 2

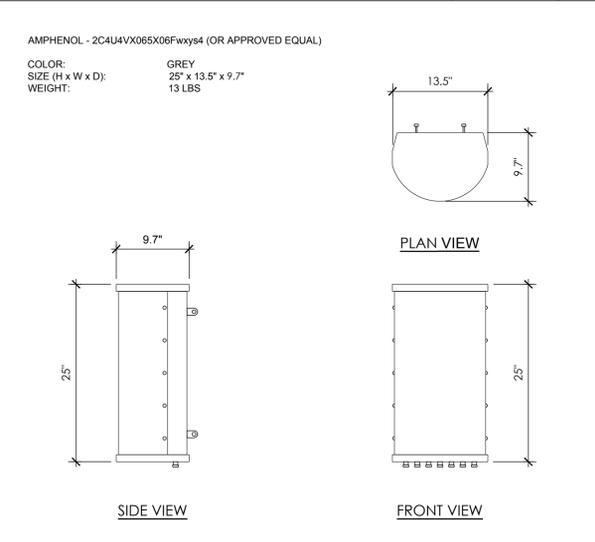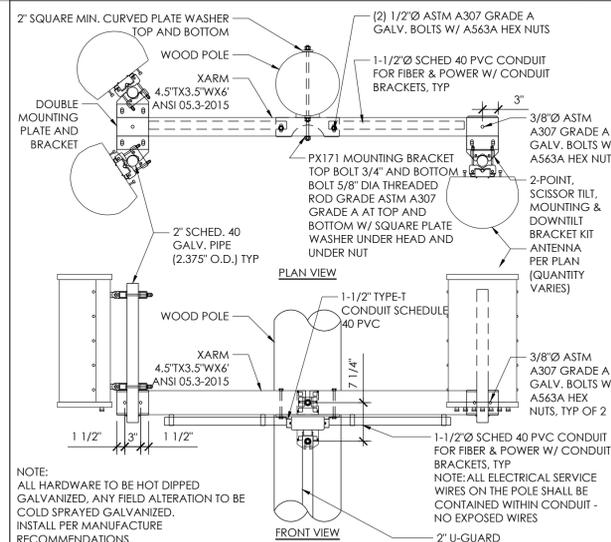

IT IS A VIOLATION OF THE LAW FOR ANY PERSON, UNLESS THEY ARE ACTING UNDER THE DIRECTION OF A LICENSED PROFESSIONAL ENGINEER, TO ALTER THIS DOCUMENT

MARSH CREEK RD SC1
 (ADJ. TO) 14101 MARSH CREEK RD
 CLAYTON, CA 94517

DETAILS

D-1


NOT USED SCALE NTS 10

SIDE MOUNT ANTENNA BRACKET SCALE NTS 7

5G ANTENNA SCALE NTS 4

NOT USED SCALE NTS 1

Electrical Load Calculations @ 240V			
Radio	Wattage	1.25*VA	Amps
4490	480	600.0	2.5
8863	1109	1386.3	5.8
		0.0	0.0
		0.0	0.0
		0.0	0.0
Totals		1986.3	8.3
Disconnect / Meter: 100 Amps			
Total Load: 8.3%			

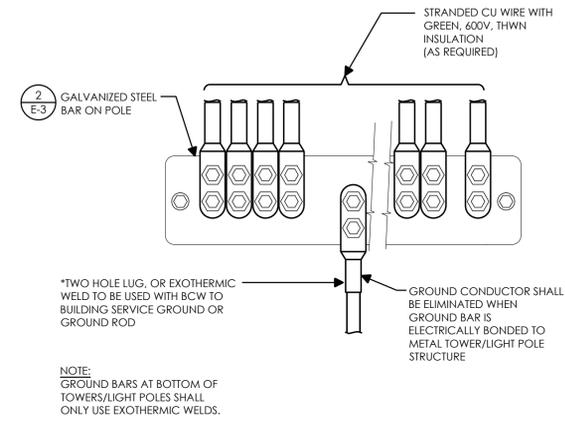

VERIZON WIRELESS
2785 MITCHELL DRIVE, SUITE 9
WALNUT CREEK, CA
94598



1355 WINDWARD CONCOURSE,
SUITES 410
ALPHARETTA, GA
30005

DRAWN BY: JLV
CHECKED BY: TDL
APPROVED BY: CW

REV	DATE	DESCRIPTION
0	01/28/25	90% CD
0	02/27/25	100% CD
1	06/30/25	REDESIGN



IT IS A VIOLATION OF THE LAW FOR ANY PERSON, UNLESS THEY ARE ACTING UNDER THE DIRECTION OF A LICENSED PROFESSIONAL ENGINEER, TO ALTER THIS DOCUMENT

MARSH CREEK RD SC1

(ADJ. TO) 14101 MARSH CREEK RD
CLAYTON, CA 94517

ELECTRICAL DETAILS

E-3



NOT USED

12 NOT USED

9 LOAD CALCULATIONS

6 GROUND WIRE TO BAR

3

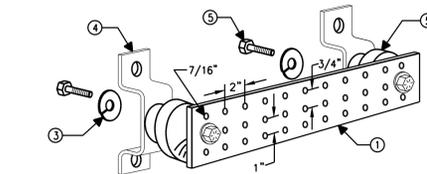
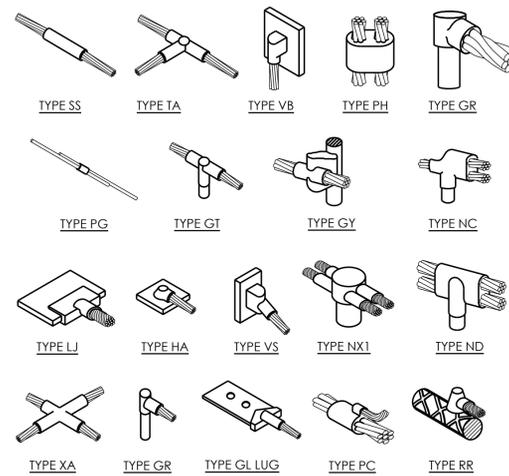


- NOTES:
1. COPPER GROUND BAR, HOLE CENTERS TO MATCH NEMA DOUBLE LUG CONFIGURATION. (ACTUAL GROUND BAR SIZE WILL VARY BASED ON NUMBER OF GROUND CONNECTIONS)
 2. INSULATORS, NEWTON INSTRUMENT CAT. NO. 3061-4 OR APPROVED EQUAL
 3. 5/8" LOCK WASHERS, NEWTON INSTRUMENT CO., CAT. NO. 3015-8 OR APPROVED EQUAL
 4. WALL MOUNTING BRACKET, NEWTON INSTRUMENT CO., CAT NO. A-6056 OR APPROVED EQUAL
 5. 5/8-11 X 1" HHCS BOLTS, NEWTON INSTRUMENT CO., CAT NO. 3012-1 OR APPROVED EQUAL
 6. INSULATORS SHALL BE ELIMINATED WHEN BONDING DIRECTLY TO TOWER/MONOPINE STRUCTURE. CONNECTION TO TOWER/MONOPINE STRUCTURE SHALL BE PER MANUFACTURERS RECOMMENDATIONS.
 7. VALMONT TINMG212U-K (OR EQUIVALENT) 1/4"X2"X12"

EXOTHERMIC WELD CONNECTION

5 GROUND BAR

2

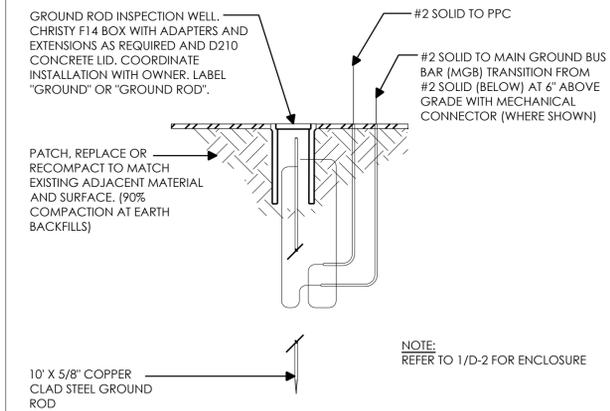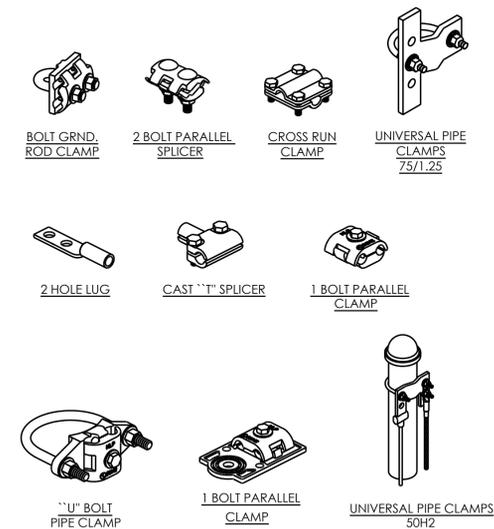

NOT USED

7 MECHANICAL CONNECTION

4 GROUND TEST WELL

1

